ADVERTISEMENT

REQUESTS FOR PROPOSALS for the Lowell Maintenance Facility Financing Town of Lowell, IN

Notice is hereby given that Requests for Proposal (RFP) will be received by the Town of Lowell, Lake County, Indiana until 12:00 p.m. Central Time on July 12, 2024, at the Lowell Town Hall, 501 E. Main Street, Lowell, IN 46356 for the opportunity to provide financing solutions for the proposed Lowell Public Works Maintenance Facility.

The complete RFP is available for download via the Town of Lowell website at www.Lowell.net or by contacting the Lowell Town Manager by email at chendrix@lowell.net or telephone at 219.696.7794.

Town of Lowell Lake County, Indiana By: Craig Hendrix, Town Manager

TOWN OF LOWELL, INDIANA



REQUEST FOR PROPOSALS

for

LOWELL MAINTENANCE FACILITY FINANCING

June 24, 2024

Town of Lowell 501 E. Main Street Lowell, IN 46356

Phone: (219) 696-7794

Attention: Craig Hendrix, PE

INTRODUCTION

The Lowell Town Council, Lowell, Indiana ("Lowell") seeks proposals from financial institutions (Respondent") interested in providing construction and end loans for a new Public Works Maintenance Facility ("Facility") to be located at 7511 Belshaw Road, Lowell, IN. The information sought and background details are further outlined in this Request for Proposals ("RFP").

BACKGROUND INFORMATION

In December of 2020 Lowell purchased a 14.19-acre parcel from John and Judy Keithley. On April 12, 2021, Lowell passed Ordinance 2021-11 annexing the parcel into the Town of Lowell. Lowell granted a variance of use for the proposed facility on June 14, 2021. In September of 2021, the Lowell Plan Commission granted final plat approval of the Maintenance Facility Subdivision ("Plat") consisting of one lot. The Commission also approved a site plan for the Facility which included the building and all site improvements.

The Facility consists of a maintenance building and office space. The building is approximately 16,000 square feet in area. The structure is mainly comprised of "tip-up" precast concrete panels. The Facility will be serviced by NIPSCO gas and electric, Indiana-American Water Company potable water and Town of Lowell sanitary sewer. Stormwater and drainage are managed on site. Asphalt parking and driveways are provided in public areas. Compacted aggregate is provided in non-public areas. A salt storage barn having a capacity of at least 2,000 tons is proposed along with a fueling station. The Facility will be surrounded by a chain-link security fence. Lighting and security cameras will facilitate site security.

The preliminary cost estimate for the Facility is nearly \$7.6 million. Lowell wishes to finance the construction of the facility with a construction loan. At completion, Lowell wishes to roll the construction loan into an end loan with a term between five and ten years.

INFORMATION REQUESTED

- 1) General Information
 - a) Respondent shall provide the following:
 - (1) Name of the financial institution
 - (2) Name and title of the individual who is responsible for the response, including business mailing address, fax, telephone numbers and e-mail.
 - (3) Previous Experience -- List any relevant experience your organization has with municipal entities.
- 2) Proposed Financing Solution
 - a) Respondent shall provide a Financial Solution that includes the following:
 - (1) Construction loan not exceeding 18 months from the date of the first draw
 - (2) Conversion of construction loan into an end loan of not less than five years and not greater than 20 years

- (3) Available funds up to \$10 million
- (4) Proposed payment schedules
- (5) Proposed interest rates
- (6) Anticipated loan closing schedules
- (7) Other financing details

RESTRICTIONS ON COMMUNICATIONS.

The contact named in the Respondent's submittal shall be the sole point of contact throughout the RFP process. All communications, oral and written (whether transmitted by regular mail, express mail, or electronic mail) concerning this process shall be addressed to:

Craig Hendrix, PE Town Manager 501 E. Main Street Lowell, IN 46356 phone: (219) 696-7794 chendrix@lowell.net

OTHER THAN AS PROVIDED ABOVE, INQUIRIES RELATED TO THIS RFP ARE NOT TO BE DIRECTED TO ANY MEMBER OF THE COUNCIL OR OTHER TOWN OFFICIAL OR EMPLOYEE. SUCH ACTION MAY DISQUALIFY THE RESPONDENT FROM FURTHER CONSIDERATION. RESPONDENTS MAY NOT RELY UPON VERBAL RESPONSES TO ANY INQUIRY.

ADMINISTRATIVE ITEMS.

- 1) Lowell may enter into a contract or other agreement for services without further discussion.
- 2) Lowell creates no obligation, expressed or implied, of any kind or description in issuing this RFP or receiving a response. Neither this RFP nor the response shall be construed as a legal offer.
- 3) Lowell will not assume any responsibility or liability for any expenses incurred by a Respondent, or prospective respondent, in connection with the preparation or delivery of a response, requested interview or any action related to the process of completing and submitting a response to this RFP.
- 4) Respondent shall certify within the letter of transmittal that all information provided therein and in their response is accurate and complete, to the best of its knowledge, and that it understands that submission of any false or misleading information may result in disqualification of the proposing organization at Lowell's discretion.
- 5) Respondent shall disclose any information that may materially impair the organization's ability to provide the level of service required.
- 6) Lowell shall reserve the right to reject any and all submissions without cause; waive irregularities in all procedures related to this RFP; make inquiries of Respondents and their

references regarding qualifications or information submitted as part of their responses as deemed necessary, and request and receive additional information as Lowell deems necessary.

- 7) Provide details of any relevant criminal investigation or conviction, material pending litigation, or regulatory or civil enforcement action pending against your organization.
- 8) Responses shall be delivered in hard copy format via hand delivery, U.S. Mail or other delivery services to:

Craig Hendrix, PE Town Manager Town of Lowell 501 E. Main Street Lowell, IN 46356 phone: (219) 696-7794 chendrix@lowell.net

CALENDAR.


The following calendar will generally be followed. Lowell reserves the right to alter this calendar, as it deems necessary.

- 1) June 24, 2024: The RFP is publicly advertised and available for review.
- 2) July 12, 2024 (noon): Deadline to ask any clarifying questions of Lowell about this request.
- July 17, 2024: All responses to this RFP are due by 12:00 p.m. Central Time on this date. Responses received after the deadline will not be considered or reviewed. Lowell reserves the right to conduct interviews of any Respondent it deems necessary.
- 4) August 21, 2024: Anticipated project bid opening.
- 5) September 18, 2024: Anticipated loan closing.
- 6) September 23, 2024: Anticipated project bid Award.

ATTACHMENTS.

The following attachments are made part of this RFP.

- 1) Recorded Final Plat of Maintenance Facility Subdivision
- 2) Title work from closing with Keithley
- 3) Draft Facility plans for bidding
- 4) Current Engineer/Architect estimate of probable construction costs

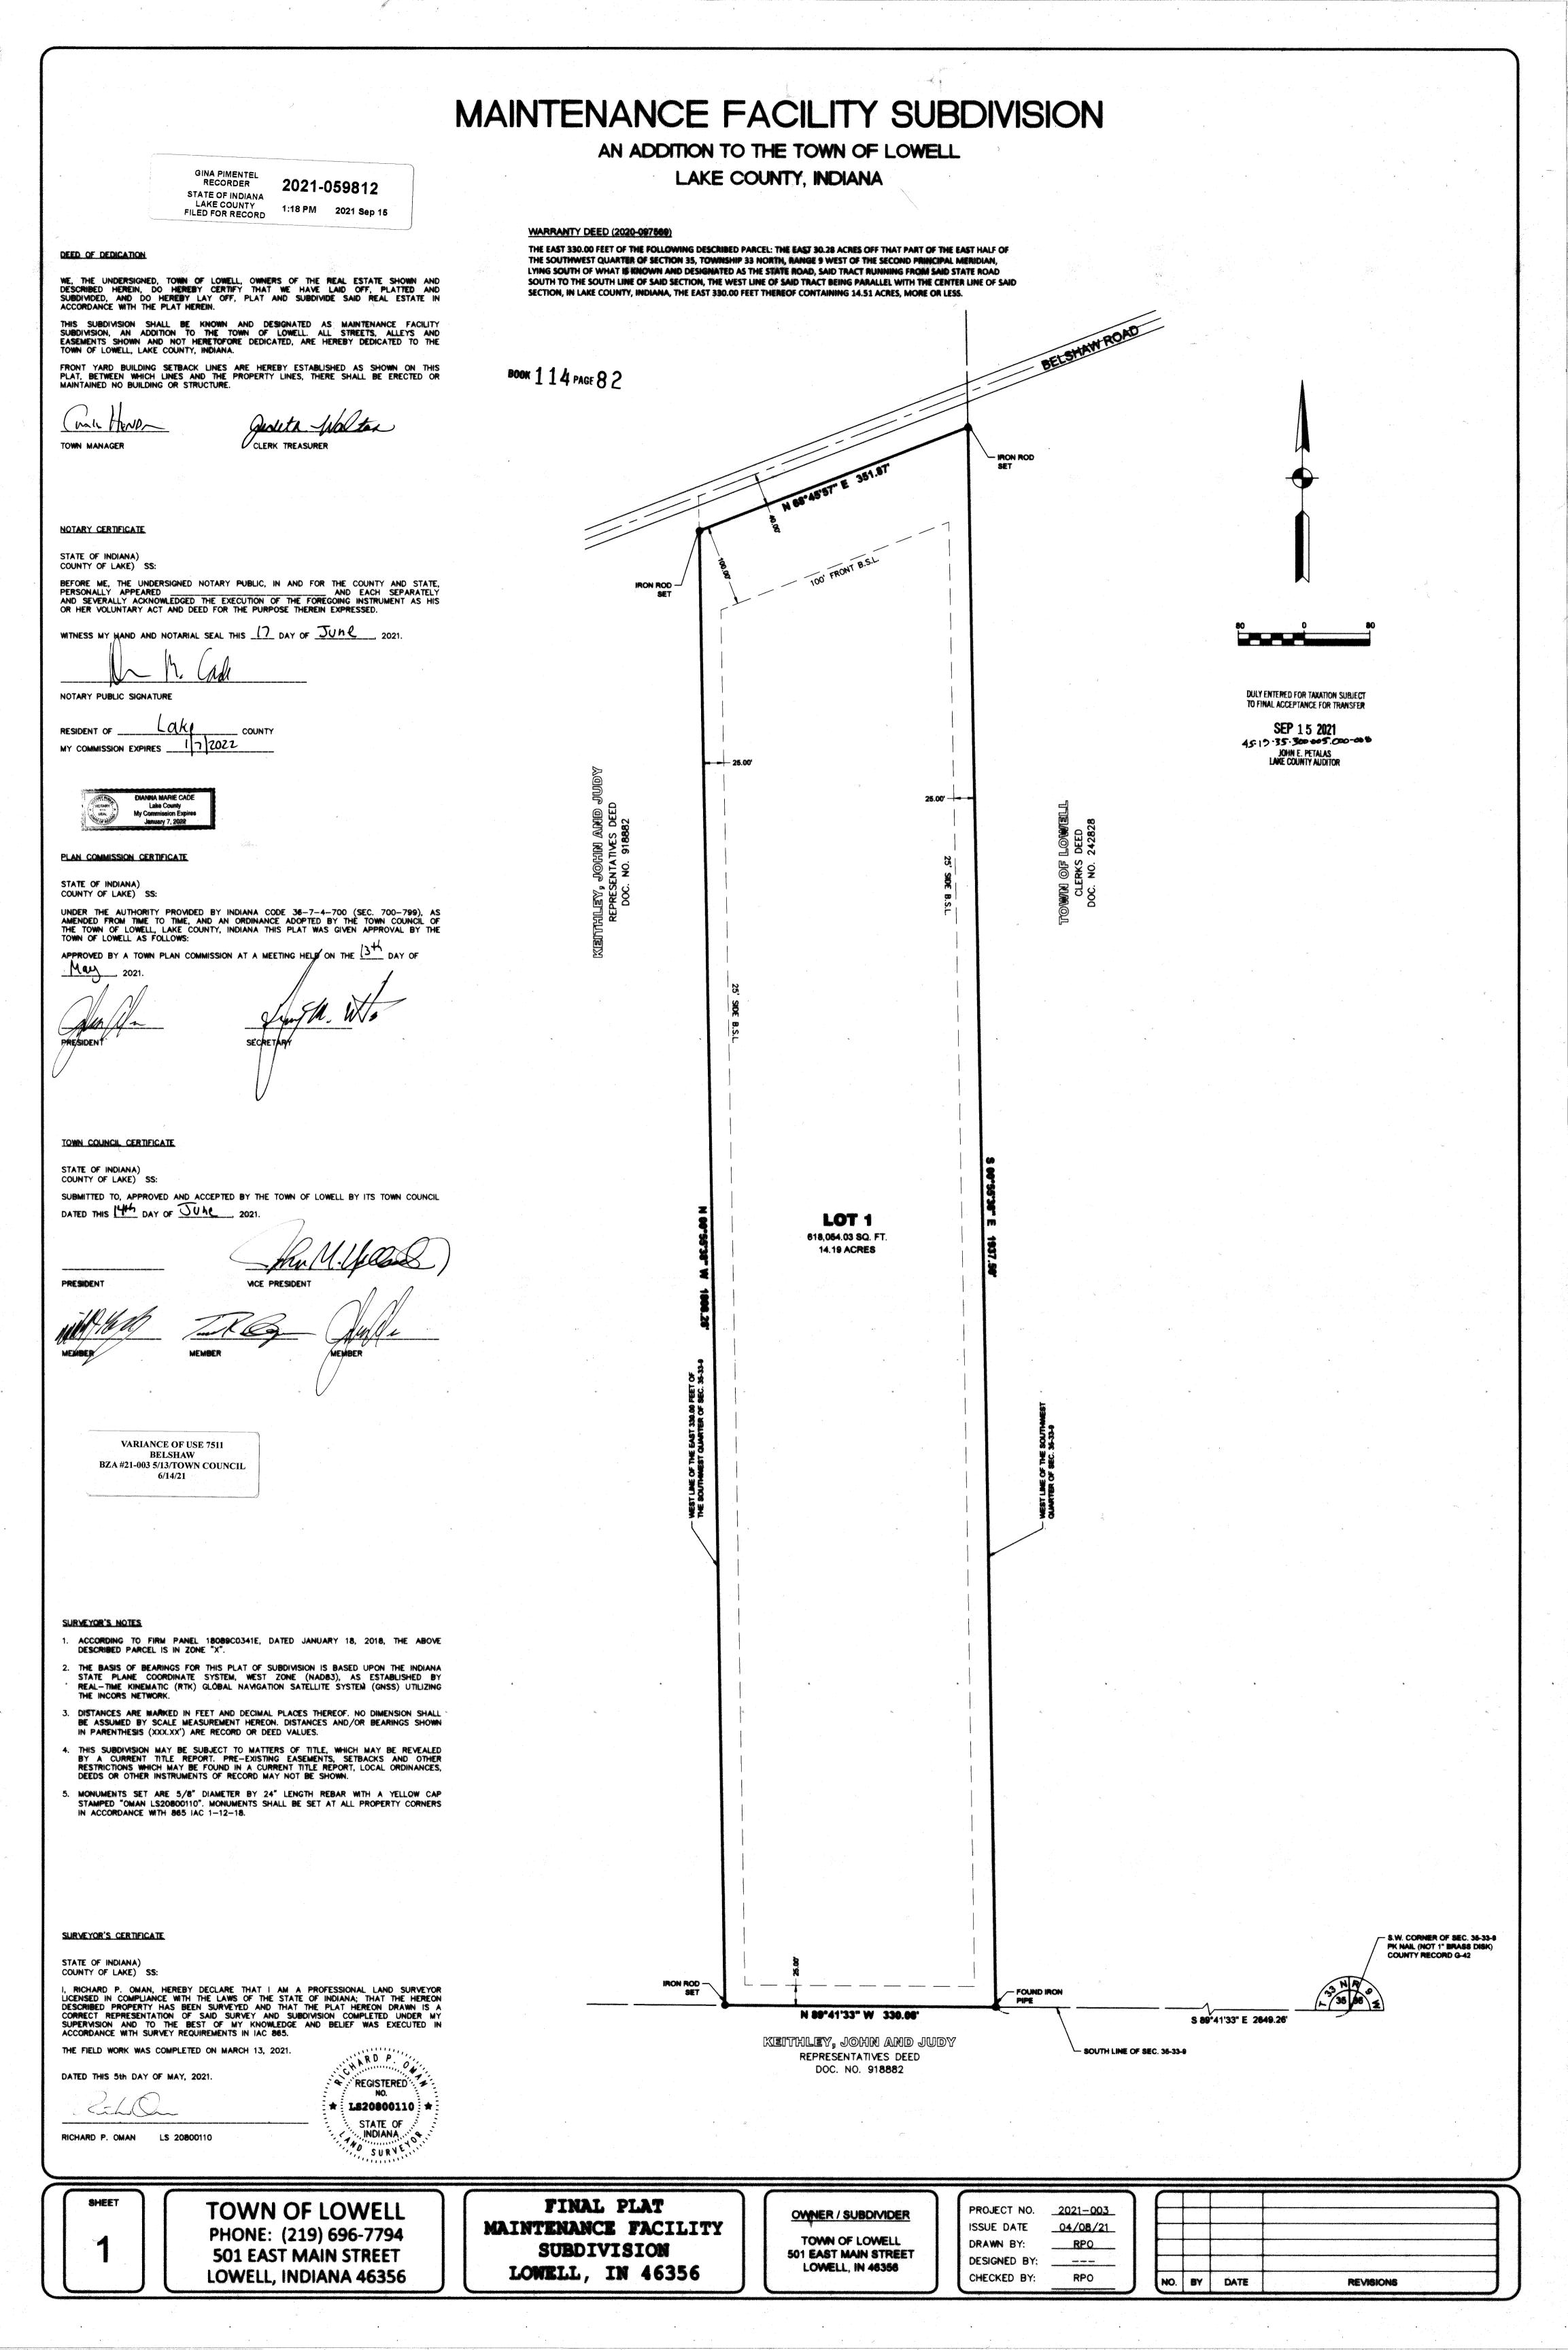

Fidelity National Title Company, LLC

11364 Broadway, Crown Point, IN 46307 Phone: (219)663-5160 | Fax: (219)662-0456

MASTER STATEMENT

Settlement Date: December 22, 2020 Disbursement Date: December 22, 2020 Escrow Number: FNW1905415 **Escrow Officer:** Renee Wells

Email: Renee.Wells@fnf.com

Borrower: Town of Lowell

501 E. Main St, P.O. Box 157

Lowell, IN 46356

Seller: John L. Keithley and Judy M. Keithley

P.O. Box 1133, 37270 NE

Greythorn Cir Carefree, AZ 85377

Property: 6808 Belshaw Road

Lowell, IN 46356

S pt E 1/2 SW 35-33-9

Lender:

SELLER					BORROWER					
\$ DEBITS	\$	CREDITS		\$	DEBITS	\$	CREDITS			
		164,369.28	FINANCIAL CONSIDERATION Sale Price of Property Deposit		164,369.28		10.00			
10.00			Excess Deposit	•						
379.24			PRORATIONS/ADJUSTMENTS Proration of RE Taxes at \$389.89 01/01/20-12/22/20				379.24			
			TITLE & ESCROW CHARGES Title - Closing Fee to Fidelity National Title Company, LLC		600.00					
			Title - Delivery Overnight and Service Fee to Fidelity National Title Company, LLC		25.00					
			Title - Later Date/Policy Issuance Fee to Fidelity National Title Company, LLC		225.00					
-			Title - Search and Exam Fee to Fidelity National Title Company, LLC		300.00					
			Title - Sold Search - Add'l Deeds search to Fidelity National Title Company, LLC		50.00					
			Title - TIEFF to Fidelity National Title Company, LLC		5.00					
			Title - updated search fee to Fidelity National Title Company, LLC		150.00					
			Title - Wire Service Fee to Fidelity National Title Company, LLC		35.00					
			Title - Owner's Title Insurance to Fidelity National Title Company, LLC		525.00					
			Policies to be issued: Owners Policy Coverage: \$164,369.28 Premium: \$525.00 Version: ALTA Owner's Policy 2006							

SELLER					VER		
\$	DEBITS	\$	CREDITS		\$	DEBITS S	CREDITS
				GOVERNMENT CHARGES Recording Fees to Fidelity National Title Company, LLC		25.00	
				Sales Disclosure/Transfer Fee to Fidelity National Title Company, LLC		20.00	
	0.00			MISCELLANEOUS CHARGES Deed Prep Fee to Austgen Kuiper Jasaitis P.C.		50.00	
				Signing Fee to BancServ		125.00	
	389.24		164,369.28	Subtotals	1	66,504.28	389.24
				Balance Due FROM Borrower			166,115.04
1	63,980.04			Balance Due TO Seller			
1	64,369.28		164,369.28	TOTALS	1	66,504.28	166,504.28

I have carefully reviewed the Settlement Statement and to the best of my knowledge and belief, it is a true and accurate statement of all receipts and disbursements made on my account or by me in this transaction. I further certify that I have received a copy of the Settlement Statement.

SELLER:

John L. Keithley

July M Kethy

BORROWER:

Town of Lowell

BY:

Craig Hendrix

Town Manager

To the best of my knowledge, the Settlement Statement which I have prepared is a true and accurate account of the funds which were received and have been or will be disbursed by the undersigned as part of the settlement of this transaction.

Fidelity National Title Company, LLC

Settlement Agerit

	SELLER					BORRO	OWER		
\$	DEBITS	\$	CREDITS		\$	DEBITS	\$	CREDITS	
				GOVERNMENT CHARGES Recording Fees to Fidelity National Title Company, LLC		25.00			
				Sales Disclosure/Transfer Fee to Fidelity National Title Company, LLC		20.00			
				MISCELLANEOUS CHARGES					
	0.00			Deed Prep Fee to Austgen Kuiper Jasaitis P.C.		50.00			
				Signing Fee to BancServ		125.00			
	389.24		164,369.28	Subtotals	1	66,504.28		389.24	
				Balance Due FROM Borrower				166,115.04	
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1	64,369.28		164,369.28	TOTALS	1	66,504.28		166,504.28	

I have carefully reviewed the Settlement Statement and to the best of my knowledge and belief, it is a true and accurate statement of all receipts and disbursements made on my account or by me in this transaction. I further certify that I have received a copy of the Settlement Statement.

SELLER:	BORROWER:
	Town of Lowell
John L. Keithley	Graig Hendrix Town Manager
ludy M. Keithley	

To the best of my knowledge, the Settlement Statement which I have prepared is a true and accurate account of the funds which were received and have been or will be dispursed by the undersigned as part of the settlement of this transaction.

Fidenty National Title Company, LLC

Settlement Agent

WARRANTY DEED

File No.: FNW1905415-RJW

THIS INDENTURE WITNESSETH, that John L. Keithley, II and Judy M. Keithley, husband and wife (Grantor) CONVEY(\$) AND WARRANT(\$) to Town of Lowell (Grantee) for the sum of Ten Dollars (\$10.00) and other valuable consideration, the receipt and sufficiency of which are hereby acknowledged, the following described real estate in Lake County in the State of Indiana, to wit:

SEE EXHIBIT "A" ATTACHED HERETO AND MADE A PART HEREOF

Property: 6808 Belshaw Road, Lowell, IN 46356

Tax ID No.: 45-19-35-300-004.000-007

Subject to all current real estate taxes and assessments and all subsequent taxes and assessments.

Subject to all easements, covenants, conditions, and restrictions of record.

IN WITNESS WHEREOF, Grantor has executed this deed this 21st day of December, 2020.

løhn I Keithlev

Judy M. Kenthley

COUNTY OF LAKE MUNICOPA CTW

Before me, a Noter T

Before me, a Notary Public in and for said County and State, personally appeared John L. Keithley, II and Judy M. Keithley who acknowledged the execution of the foregoing instrument, who acknowledged the foregoing instrument to be his/her free act and deed.

Witness my hand and Notarial Seal this 21st day of December, 2020

Signature:

Printed: ('of ne lius Resident of: Lake County

State of: INDIANA

My Commission expires: Jul

Prepared By: Timothy R. Kuiper

Austgen Kuiper Jasaitis P.C.

130 North Main Street, Crown Point, IN 46307

Grantee's Address and Tax Billing Address: 501 E. Main St, P.O. Box 157

CORNELIUS T WILLIAMS Notary Public - Arizona

Maricopa County Commission # 576532 My Comm. Exp. February 26, 2024

Lowell, IN 46356

I affirm, under the penalties for perjury, that I have taken reasonable care to redact each Social Security number in this document, unless required by law: Renee.

Return To:

Craig Hendrix Town of Lowell

501 E. Main St, P.O. Box 157

Lowell, IN 46356

EXHIBIT "A"

Legal Description

For APN/Parcel ID(s): 45-19-35-300-004.000-007

The East 330.00 feet of the following described parcel: The East 30.28 acres off of that part of the East Half of the Southwest Quarter of Section 35, Township 33 North, Range 9 West of the Second Principal Meridian, lying South of what is known and designated as the State Road, said tract running from said State Road South to the South line of said Section, the West line of said tract being parallel with the center line of said section; in Lake County, Indiana.

CERTIFICATE OF PROOF

WITNESS to the signature(s) on the foregoing instrument to which this Proof is attached.
Witness Signature
John Arthur Mattes
Witness Name
PROOF:
STATE OF Howard
100
Before me, a Notary Public in and for said County and State, on December $\frac{2!}{22}$, 2020, personally appeared the above
named WITNESS to the foregoing instrument, who, being by me duly sworn, did depose and say that (he/she knows John La Kaithlay and Judy M. Kaithlay to be the individual/o) deposited in and who executed the foregoing instruments that exists
L. Keithley and Judy M. Keithley to be the individual(s) described in and who executed the foregoing instrument; that said WITNESS was present and saw said John L. Keithley and Judy M. Keithley execute the same; and that said WITNESS a
the same time subscribed his her name as a witness thereto.
Com L. J. Walle Notor, Rubbie
NOTARY PUBLIC
Printed: Corne I w. T. Wallams Notary Public - Arizona Maricopa County
Resident of: Maricopa (T) Commission # 576532 My Comm. Exp. February 26, 2024
State of: Arizona CTW
My Commission expires: 2/24/2024
$\sigma r^{\prime \prime $

Certificate of Proof

IND1295.doc / Updated: 11.16.20

File No.: FNW1905415-RJW

Printed: 12.20.20 @ 05:29 PM by RJW IN-FT-FIDS-01040.246344-FNW1905415



SALES DISCLOSURE FORM

State Form 46021 (R11/12-11)

Prescribed by Department of Local Government Finance Pursuant to 1C 6-1.1-5.5

SDF ID	Lake		
	County	Year	Unique ID
	SDF Date:		

PRIVACY NOTICE: The telephone numbers and Social Security numbers of the parties on this form are confidential according to 1C 6-1.1-5.5-3(d).

1. Progrey Number		- To be completed by BUYER/GR PERTY TRANSFERRED - MUST BE				E DOCUMENT		
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10. Physical changes to property between March 1 and date of sale. (Describe in special circumstances in Table C Item 3.) 11. Partial interest. (Describe in special circumstances in Table C Item 3.) 12. Easement or right-of-way grants.			ded in transfer. (Provide the	value	YES	NO CONDITION		
11. Partial interest. (Describe in special circumstances in Table C Item 3.) 12. Easement or right-of-way grants.		10. Physical changes to pro	- •	l		•		ship existing between
12. Easement or right-of-way grants. Disclose actual value in money, property, a service, an agreement, or other consideration.						•		
13. Document for compulsory transactions as a result of foreclosure or express threat of foreclosure, divorce, court order, judgment, condemnation, or probate. 14. Documents involving the partition of land between tenants in common, joint tenants, or tenants by the entirety. 15. Transfer to a charity, not-for-profit organization, or government. 16. Sales price: \$164,369.28 7. Is the seller financing sale? If yes, answer questions (8-13). 9. Is this a mortgage loan? 10. Amount of loan: \$11. Interest rate: % 12. Amount in points: \$15. Transfer to a charity in points: \$15. Tr		12. Easement or right-of-w	ay grants.		Disclose ac	tual value in money, prop	erty, a service, an agreement	, or other consideration.
☐ 13. Document for compulsory transactions as a result of foreclosure or express threat of foreclosure, divorce, court order, judgment, condemnation, or probate. ☐ 14. Documents involving the partition of land between tenants in common, joint tenants, or tenants by the entirety. ☐ 15. Transfer to a charity, not-for-profit organization, or government. ☐ 10. Amount of loan: ☐ 11. Interest rate: ☐ 12. Amount in points: ☐ 13. Document for compulsory transactions as a result of foreclosure or express threat of foreclosure or express threat of foreclosure, divorce, court order, judgment, questions (8-13). ☐ 14. Documents involving the partition of land between tenants in common, joint tenants, or tenants by the entirety. ☐ 15. Transfer to a charity, not-for-profit organization, or government. ☐ 16. Amount of loan: ☐ 17. Is the seller financing sale? If yes, answer questions (8-13). ☐ 18. Is buyer/borrower personally liable for loan? ☐ 10. Amount of loan: ☐ 11. Interest rate: ☐ 12. Amount in points: ☐ 13. Document for compulsory transactions as a result of foreclosure, divorce, court order, judgment, questions (8-13).	If condition	ns 13-15 apply, filers are subject to disclosure,	but no disclosure filing fee.			-	rsonal property:	
result of foreclosure or express threat of foreclosure, divorce, court order, judgment, condemnation, or probate. 14. Documents involving the partition of land between tenants in common, joint tenants, or tenants by the entirety. 15. Transfer to a charity, not-for-profit organization, or government. 7. Is the seller financing sale? If yes, answer questions (8-13). 9. Is this a mortgage loan? 10. Amount of loan: 11. Interest rate: 9. Is this a mortgage loan?	YES	_/						\$164,369.28
14. Documents involving the partition of land between tenants in common, joint tenants, or tenants by the entirety. 15. Transfer to a charity, not-for-profit organization, or government. 10. Amount of loan: 11. Interest rate: 9. Is this a mortgage loan? 11. Interest rate: 9. Is this a mortgage loan?		result of foreclosure or foreclosure, divorce, co	express threat of urt order, judgment,	7. Is the seller financing sale? If yes, answer				
15. Transfer to a charity, not-for-profit organization, or government. 10. Amount of loan: 11. Interest rate: 12. Amount in points: \$ \$ \$ \$ \$ \$ \$ \$ \$ \$ \$ \$ \$ \$ \$ \$ \$ \$ \$		14. Documents involving the partition of land between tenants in common, joint tenants, or Setween tenants in common tenants in common tenants.						
12. Amount in points: \$		—/		on,	10. Am	ount of loan:		***
		or government.						
1 15. AHIOLUZAUOH DEHOU.							:	Ψ

INDIANA SALES DISCLOSURE FORM SDF ID:	Page 2
b) Properties	
Renee Wells	Closer
Preparer of the Sales Disclosure Form 11364 Broadway	Title
Address (Number and Street)	Fidelity National Title Company, LLC
Crown Point, IN 46307	(219)663-5160 Renee.Wells@fnf.com
City, State, and ZIP Code	Telephone Number E-mail
TE SHILL UR(S)/GRÄNDORIS)	
John L. Keithley, II	Judy M. Keithley
Seller 1 - Name as appears on conveyance document	Seller 2 - Name as appears on conveyance document
P.O. Box 1133, 37270 NE Greythorn Cir Address (Number and Street)	P.O. Box 1133, 37270 NE Greythorn Cir Address (Number and Street)
Carefree, AZ 85377	Carefree, AZ 85377
City, State, and ZIP Code	City, State, and ZIP Code
Telephone Number E-mail	Telephone Number E-mail
Under penalties of perjury I bereby certify that this Sales Disclo	sure, to the best of my knowledge and belief, is true, correct and
complete as required by law, and is prepared in accordance with I	Sure, to the best of my knowledge and bener, is true, correct and IC 6-1.1-5.5. "Real Property Sales Disclosure Act".
\otimes	(\checkmark)
Signature of Seiler	Signature of Seller
John L. Keithley 12-21-2020 Printed Name of Seller Sign Date (MM/DD/YYYY)	Judy M. Keithley 12-21-2020 Printed Name of Seller Sian Date (MM/DD/YYYY)
GAS-AND-SOLD STATE OF THE STATE	
E BUYER(S)YGBANTER(S). APPLICATION HOR PROPERTY LAY	DEBUCTIONS INCLUDENT ADMITTEMS THAT APPRICE
Town of Lowell Buyer 1 - Name as appears on conveyance document	
501 E MAIN ST, PO BOX 157	Buyer Z - Name as appears on conveyance document
Address (Number and Street)	Address (Number and Street)
LOWELL IN 46356 City, State, and ZIP Code	
219-696-7794	City, State, and ZIP Code
Telephone Number E-mail	Telephone Number E-mail
THE SALES DISCLOSURE FORM MAY BE USED TO APPLY FOR CERTAIN DEDUCTIONS FOR THIS PROP	PERTY, IDENTIFY ALL OF THOSE THAT APPLY,
YES NO CONDITION	YES NO CONDITION
1. Will this property be the buyer's primary residence? Provide complete address of primary	3. Homestead
residence, including county:	4. Solar Energy Heating/Cooling System
,	5. Wind Power Device
P.O. BOX 157	6. Hydroelectric Power Device
Address (Number and Street)	7. Geothermal Energy Heating/Cooling Device
LOWELL IN ACCE.	
LOWELL IN 46356 LAKE City, State, and ZIP Code County	or is this property a residential remain property.
	9. Would you like to receive tax statements for this
2. Does the buyer have a homestead in Indiana to be	property via e-mail? (Provide contact information below. Please see instructions for more information.
vacated for this residence? If yes, provide complete address of residence being vacated,	Not available in all counties.)
including county	
Address (Number and Street)	
City, State, and ZIP Code County	Primary property owner contact name E-mail
Under penalties of perjury, I hereby certify that this Sales Disclos	
complete as required by law, and is prepared in accordance with	IC 6-1.1-5.5, "Real Property Sales Disclosure Act". (Note: Spouse
information, Social Security and Driver's License/Other numbers a	re not necessary if no Homestead Deduction is being filed.)
Signoture of Buyer 1	6
Craig Hendrix, Town Manager 12-22-2020	Signature of Buyer 2/Spouse
Printed Legal Name of Buyer 1 Sign Date (MM/DD/YYYY)	Printed Legal Name of Buyer 2 Sign Date (MM/DD/YYYY)
FID 35-6661091	
Last 5 digits of Buyer 1 Driver's State Last 5 digits of Social Security Number License/ID/Other Number	Last 5 digits of Buyer 2/Spouse Driver's State Last 5 digits of Social Security Number License/ID/Other Number

A STATE OF THE PARTY OF THE PAR	CLENETY (1.53) S. 50				Control of the second		W.			
1. Property	2. AV Land	3. AV Improvement	ough 14 and stamp the sale 4. Value of Personal Property	s disclosure form befo	re sending to the au 6. Property Class Code	ditor: 7. Neighborho Code			8. Tax District	9. Acreage
)										
	Assessor Sta	mp	10. Identify physical cl			and	YES		CONDITION	
		• 	date of sale.						11. Is form com	-
							13.	Date	of sale (MM/DD/YYY	-
							14.	Date	form received (M	M/DD/YYYY):
ems 15 th	ough 18 are to be	completed by the	assessor when valida	ting this sale:						
15. if applic	able, identify any a	dditional circumst	ances relating to validat	ion of sale				NO	CONDITION	
									16. Sale valid fo 17. Validation o	
							18. 7	/alida	ted by:	
	olikeryyanojesoj:						1			
	Auditor Stan	np	1. Disclosure fee amou 2. Other Local Fee: \$					NO	6. Is form comp	leted?
			Total Fee: \$ Auditor receipt bool						7. Is state fee co 8. Attachments	
			5. Date of transfer (MM							,
WAYZONE WINDOW										
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IDF ID	,0 00 1.000-007		SDF Date (MM/DD/YY		as appears on conveya	nce docur	ment			
arcel Numbe		<u> </u>		·	erty (Number and Stre	et)				
Check all the Homeste Hydroeld	ead 🗆 Sola		Wind Power Rental Property	Lowell, IN City, State, and	46356 ZIP Code of Property					
-	ic Statement (e-ma		a Rental Property	Auditor Signat	ire			<u>.</u>	Dat	e (MM/DD/YYYY)
person wh	o knowingly and i	ntentionally falsifi its a Class C felony	es value of transferred	real property, or	omits or falsifies	any in	ıform	ation	required to be	provided in

SDF ID: ___

Fidelity National Title

DISCLOSURE AND ACKNOWLEDGMENT

File No.: FNW1905

FNW1905415-RJW

Property: 6808 Belshaw Road, Lowell, IN 46356

By signing this statement, I acknowledge the following:

- 1. That Fidelity National Title Company, LLC IS NOT ACTING AS MY AGENT, ATTORNEY, REPRESENTATIVE OR FIDUCIARY at this real estate closing.
- 2. That Fidelity National Title Company, LLC's employee who has conducted this closing represents only Fidelity National Title Company, LLC and, if he or she has said so, .
- 3. That Fidelity National Title Company, LLC's employee has identified certain documents to me as he or she has presented them to me for signing, but HAS NOT GIVEN ME LEGAL ADVICE AS TO THE MEANING OR EFFECT OF THE DOCUMENTS. I understand that any of his or her statements about the documents are not legal advice to me. If I have an attorney, that attorney is my only attorney in this transaction.
- 4. I UNDERSTAND THAT FIDELITY NATIONAL TITLE COMPANY, LLC IS NOT RESPONSIBLE FOR EXPLAINING TO ME THE EFFECT OF THE DOCUMENTS I HAVE SIGNED.
- 5. THAT I HAVE READ THIS STATEMENT AND UNDERSTAND IT.

IN WITNESS WHEREOF, the undersigned have executed this document on the date(s) set forth below.

BORROWER(S):

Town of Lowell

BY: Lowell

Craig Hendrix
Town Manager

Date

SELLER(S):

John L. Keithley

Date

Fidelity National Title

DISCLOSURE AND ACKNOWLEDGMENT

File No.:

FNW1905415-RJW

BORROWER(S):

Property: 6808 Belshaw Road, Lowell, IN 46356

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- 1. That Fidelity National Title Company, LLC IS NOT ACTING AS MY AGENT, ATTORNEY, REPRESENTATIVE OR FIDUCIARY at this real estate closing.
- 2. That Fidelity National Title Company, LLC's employee who has conducted this closing represents only Fidelity National Title Company, LLC and, if he or she has said so, .
- That Fidelity National Title Company, LLC's employee has identified certain documents to me as he or she has presented them to me for signing, but HAS NOT GIVEN ME LEGAL ADVICE AS TO THE MEANING OR EFFECT OF THE DOCUMENTS. I understand that any of his or her statements about the documents are not legal advice to me. If I have an attorney, that attorney is my only attorney in this transaction.
- 4. I UNDERSTAND THAT FIDELITY NATIONAL TITLE COMPANY, LLC IS NOT RESPONSIBLE FOR EXPLAINING TO ME THE EFFECT OF THE DOCUMENTS I HAVE SIGNED.
- 5. THAT I HAVE READ THIS STATEMENT AND UNDERSTAND IT.

IN WITNESS WHEREOF, the undersigned have executed this document on the date(s) set forth below.

Town of Lowell	
BY: Craig Hendrix Town Manager	Date
SELLER(S):	
2. Keathle	12/21/2020
John L. Keithley July W) Keelly	/ Date 12/2 4 /2020
Judy M. Keithley	Date



LIMITED POWER OF ATTORNEY FOR PREPARATION, COMPLETION AND SIGNATURE OF THE INDIANA SALES DISCLOSURE FORM

File No.: FNW1905415

Know all men by these presents that the undersigned Buyer(s) and Seller(s) do hereby make, constitute and appoint Fidelity National Title Company, LLC or its designated agent to be my/our true and lawful attorney, for me/us and in my/our name, place and stead to do any and all of the following:

 To prepare, complete and, if necessary, sign the Indiana Sales Disclosure Form from the property located at: 6808 Belshaw Road, Lowell, IN 46356

This power shall not be affected by my/our later disability or incompetence.

I/We give and grant to my/our said Attorney-in-Fact full power and authority to do and perform all and every act and thing requisite or proper to be done in the exercise of the rights and powers herein granted, as full, to all intents and purposes, as I/we might or could do if personally present, with full power and substitution and revocation and with full authority to deal with the property as authorized above hereby ratifying and confirming all that my/our said Attorney-in-Fact, or his/her substitute, or substitutes, lawfully do or cause to be done by virtue of the authority herein.

IN WITNESS WHEREOF, the undersigned have executed this document on the date(s) set forth below.

BUYER(S):

Town of Lowell

BY: ()

Town Manager

STATE OF INDIANA

COUNTY OF LAKE

Before me, a Notary Public in and for said County and State, personally appeared Craig Hendrix, as Town Manager of Town of Lowell, who acknowledged the execution of the foregoing instrument, and who, having been duly sworn, stated that the representations therein contained are true.

Witness my hand and Notarial Seal this 22nd day of December, 2020

Printed: Rence-J. Wells

Printed: Rence-J. Wells (

Resident of: Lake County Jasper State of: INDIANA

My Commission expires: July 8

NOTARY BEAL

MICHELE SCHMIDT Jasper County My Commission Expires May 16, 2025

LIMITED POWER OF ATTORNEY FOR PREPARATION, COMPLETION AND SIGNATURE OF THE INDIANA SALES DISCLOSURE FORM

(continued)

SELLER(S):	
2 Lottle	
John L. Keithley	
Quely MKetthe	4
Judy M. Keithley	T
STATE OF INDIANA ARZING	e Tr
COUNTY OF LAKE MARCOPA	CTW

Before me, a Notary Public in and for said County and State, personally appeared John L. Keithley and Judy M. Keithley who acknowledged the execution of the foregoing instrument, who acknowledged the foregoing instrument to be his/her free act and deed.

Witness my hand and Notarial Seal this 21st day of December, 2020

Signature: Buch I Walk Notar fub / co

Printed: Reviee J. Wells Cornellus T. Williams CThe Resident of: Lake Gounty Maricopa LTW

State of: ANDIANA Arrana CTW
My Commission expires: July 8, 2025

2/24/2024 CTW



Fidelity National Title

FINAL AGREEMENT FOR TAX PRORATION

We, Buyer(s) and Seller(s), hereby agree to the following:

- 1. We understand and agree that the tax valuation and/or special assessment (if any) used as a basis to determine the tax proration is subject to change due to an increase or decrease in the rate, reassessments, improvements, exemptions and tax credits in the current year.
- With full knowledge of the above, we will not, at any time after the settlement date, assert any right or obligation to make any adjustment of the tax proration between ourselves in the event of ANY increase or decrease in the rate, reassessments, improvements, exemptions and tax credits in the current year.
- 3. We accept the adjustments for the tax proration shown on the Settlement Statement as final.

IN WITNESS WHEREOF, the undersigned have executed this document on the date(s) set forth below.

BUYER(S):

Town of Lowell

Craig Hendrix

Town Manager

STATE OF INDIANA

COUNTY OF LAKE

Before me, a Notary Public in and for said County and State, personally appeared Craig Hendrix, as Town Manager of Town of Lowell, who acknowledged the execution of the foregoing instrument, and who, having been duly sworn, stated that the representations therein contained are true.

Witness my hand and Notarial Seal this 22nd day of December, 2020

Signature MUM

Printed: Rence J. Wells Michele Schmidt

Resident of: Lake County tasper county

State of: INDIANA

My Commission expires: July 8, 2025

NOTARY

SEAL

OF HOS

MICHELE SCHMIDT Jasper County My Commission Expires May 16, 2025

FINAL AGREEMENT FOR TAX PRORATION

(continued)

SELLER(S):

Forwarding Address: P.O. Box 1133, 37270 NE Greythorn Cir, Carefree, AZ 85377

Phone No.:

219 333 1247

STATE OF INDIANA ANZONA CTW

COUNTY OF LAKE Maricopa CT W

Before me, a Notary Public in and for said County and State, personally appeared John L. Keithley and Judy M. Keithley who acknowledged the execution of the foregoing instrument, who acknowledged the foregoing instrument to be his/her free act and deed.

Witness my hand and Notarial Seal this 21st day of December, 2020

Signature: Printed: Rense J. Wells Corne is T. W. Minns

Resident of: Lake County

muricopa Arizoda CTW

State of: INDIANA My Commission expires: July 8, 2025

CORNELIUS T WILLIAMS Notary Public - Arizona Maricopa County Commission # 576532 My Comm. Exp. February 26, 2024



The undersigned parties have employed Escrow Agent Fidelity National Title Company, LLC to act on their behalf as stated below in the closing of an escrow transaction. The escrow fee charged shall be paid as follows unless specified otherwise by written instruction from all parties: (A) Purchase/Sale Transaction — one-half (1/2) by Buyer and one-half (1/2) by Seller. The Seller shall pay for the overnight courier or messenger fee(s) or wire fee(s) for any proceeds or payoffs that are sent by overnight courier or messenger or wire. The Buyer shall pay any charge(s) for the overnight courier or messenger fee(s) for any loan documents that are returned to the lender by overnight courier or messenger. (B) Refinance Transaction — all by Borrower.

- 1. Escrow Agent is hereby authorized to pay from funds deposited into escrow for said purpose all amounts necessary to procure documents and all other charges and obligations necessary to consummate this transaction. The parties acknowledge that any fund deposited into escrow will be deposited into the escrow account of the Escrow Agent. Any funds deposited in an amount that exceeds Two Hundred Fifty Thousand And No/100 Dollars (\$250,000.00) may not qualify for FDIC insurance. Seller/Buyer/Borrower grant Escrow Agent a lien on all property and funds deposited in escrow. Seller/Buyer/Borrower hereby authorizes Escrow Agent to reimburse itself for its charges and for all damages or expenses it may incur in connection with the escrow and the performance of Escrow Agent's duties, including costs, damages and attorneys' fees.
- 2. Escrow Agent is hereby authorized to act upon any statement furnished to Escrow Agent by a lien holder or his agent, without liability or responsibility for the accuracy of such statement. In the event the lender or lien holder demands additional funds after the close of escrow, Seller/Borrower agrees to deposit with Escrow Agent any additional funds necessary to comply with the lender/lien holder's instructions upon receipt of same from Escrow Agent. Seller/Borrower acknowledges that any payment in full to a lender must be received by the lender on or before a specific date to avoid further interest accrual; and Seller/Borrower hereby instructs Escrow Agent to forward payoff funds to the lender by express service of Escrow Agent's choice and to charge Seller/Borrower any fees for express delivery at close of escrow.
- Possession of the property, transfer of utilities, and collection of cancellation premiums from the Seller's fire or hazard insurance policy shall be handled by the parties direct and outside of escrow, and Escrow Agent shall have no responsibility with regard thereto.
- 4. Any litigation, arbitration or mediation arising out of this transaction in which Escrow Agent is named as a party shall be filed and maintained in the county in which the office of the Escrow Agent handling this transaction is located. In the event of any litigation or arbitration which relates to the duties or actions of Escrow Agent, including any action seeking a declaration of the rights or obligations of any party to this Escrow, the prevailing party or parties in such litigation or arbitration proceeding shall be awarded, in addition to any other available remedy, all expenses, fees and costs including expert witness fees, and all reasonable attorney's fees incurred by said prevailing party. The award of costs, fees, expenses, and attorneys' fees shall be determined by the court or arbitrator, and not by a jury, in a separate proceeding.
- 5. All of the terms and conditions of the Real Estate Purchase Contract remain the same. However, Seller and Buyer hereby agree that all notices required to be delivered to any party to the contract or to Escrow Agent pursuant to the parties' contract shall be mailed or delivered to all parties and to Escrow Agent in order to constitute notice under the contract.
- 6. If any document is lost, misplaced, misstated, or inaccurately reflects the true and correct terms and conditions of the Loan, upon request of Agent, Seller/Buyer/Borrower will comply with Agent's request to execute, acknowledge, initial, and deliver to Agent any documentation Agent deems necessary to replace or correct the lost, misplaced, misstated, or inaccurate document(s). Buyer/Borrower also agrees that, upon request, Buyer/Borrower will supply additional amounts and/or pay to Agent any additional sum previously and properly disclosed to Buyer/Borrower as a cost or fee associated with the loan which for whatever reason was not collected at closing.
- 7. Seller/Buyer/Borrower hereby agree that at such time as Seller/Buyer/Borrower deposit into escrow the executed documents, an executed copy of the Settlement Statement and the funds sufficient to close the transaction, Escrow Agent is authorized to close the escrow.

(continued)

- 8. By depositing the above referenced documentation, the following matters shall be deemed to be satisfied, waived, met or agreed to without further instruction from Seller and Buyer and Seller and Buyer further agree to indemnify, defend, and hold Escrow Agent harmless from, for, and against any and all claims by any persons, including Seller and Buyer, as to the following matters:
 - A. All items to be prorated have been submitted to Escrow Agent.
 - B. All repairs, inspections, contingencies, and/or conditions have been completed, met, waived or satisfied.
 - C. Buyer has received and reviewed the Commitment for Title Insurance issued by Fidelity National Title Company, LLC and Buyer approves and accepts all matters as set forth therein.
 - D. Escrow Agent shall not record before the closing date as set forth in the contract.
- 9. Proration of real property taxes shall be based upon the last available tax statement from the taxing authority.
- 10. The disclosures required by I.C. 32-21-5 et seq and any other disclosures that may be required under Indiana law from time to time from the Seller and lead paint disclosure, if applicable, have been given to the Buyer.
- 11. Fidelity National Title Company, LLC is hereby granted an irrevocable power of attorney by the parties for the sole purpose of executing and recording any necessary documents to correct the terms and conditions of the deposited documents to conform with the agreement of the Parties, including but not limited to correcting any errors in the legal description.
- 12. A dormancy fee of Twenty-Five And No/100 Dollars (\$25.00) per month shall accrue for each month or fraction thereof that any undisbursed funds remain in an escrow for more than one hundred eighty (180) days after the close of escrow. The fee will be deducted from any funds held. However, the dormancy fee will not apply to any funds held in an Escrow Holdback account.
- 13. This Agreement shall survive the closing of the Loan and inure to the benefit of the Agent, it's successors and assigns, and be binding upon the heirs, devisees, personal representatives successors, and assigns of the parties.

IN WITNESS WHEREOF, the undersigned have executed this document on the date(s) set forth below.

BUYER:

Y: Craig Hendrix

Town of Lowell

Town Manager

(continued)

STATE OF INDIANA

COUNTY OF LAKE

Before me, a Notary Public in and for said County and State, personally appeared Craig Hendrix, as Town Manager of Town of Lowell, who acknowledged the execution of the foregoing instrument, and who, having been duly sworn, stated that the representations therein contained are true.

Witness my hand and Notarial Seal this 22nd day of December, 2020

Printed: Ronce J. Wells Michele Resident of: Lake County Jasper

State of: INDIANA

My Commission expires: duly 8, 2025

May 16,2025

MICHELE SCHMIDT Jasper County My Commission Expires May 16, 2025

SELLER:

John L. Keithley Judy M. Keithley

STATE OF INDIANA

COUNTY OF LAKE

Before me, a Notary Public in and for said County and State, personally appeared John L. Keithley and Judy M. Keithley who acknowledged the execution of the foregoing instrument, who acknowledged the foregoing instrument to be his/her free act and deed.

Witness my hand and Notarial Seal this 21st day of December, 2020

Signature:

Printed: Renee J. Wells Resident of: Lake County

State of: INDIANA

My Commission expires: July 8, 2025

(continued)

STATE OF INDIANA

COUNTY OF LAKE

Before me, a Notary Public in and for said County and State, personally appeared Craig Hendrix, as Town Manager of Town of Lowell, who acknowledged the execution of the foregoing instrument, and who, having been duly sworn, stated that the representations therein contained are true.

Witness my hand and Notarial Seal this 22nd day of December, 2020

Signature: Printed: Renee J. Wells

Resident of: Lake County State of: INDIANA

My Commission expires: July 8, 2025

SELLER:

John L. Keithlev

STATE OF INDIANA

COUNTY OF LAKE

Mariopa CTW

Before me, a Notary Public in and for said County and State, personally appeared John L. Keithley and Judy M. Keithley who acknowledged the execution of the foregoing instrument, who acknowledged the foregoing instrument to be his/her free act and deed.

Witness my hand and Notarial Seal this 21st day of December, 2020

Signature:

Printed: Renée J. Wells

Cornelius Resident of: Lake County March Resident of: Lake County

CORNELIUS T WILLIAMS Notary Public - Arizona Maricopa County Commission # 576532 My Comm. Exp. February 26, 2024

VENDOR'S AFFIDAVIT

STATE OF INDIANA

COUNTY OF LAKE

File No.: FNW1905415M

The undersigned, being first duly sworn states that John L. Keithley and Judy M. Keithley (hereinafter referred to, jointly and severally, as "Vendor") is this day conveying to Town of Lowell (hereinafter referred to, jointly and severally, as "Purchaser"), by Warranty Deed, the following described Real Estate located in Lake County, Indiana:

SEE EXHIBIT "A" ATTACHED HERETO AND MADE A PART HEREOF

and commonly known as 6808 Belshaw Road, Lowell, IN 46356 (hereinafter referred to as "Real Estate").

In connection with the sale of Real Estate, Vendor has furnished Purchaser with a commitment for an owner's policy of title insurance for the Real Estate with an Effective date of November 3, 2020 issued by Fidelity National Title Insurance Company as Commitment No. FNW1905415.

Vendor has an indefeasible estate in fee simple in the Real Estate; and the Real Estate is free and clear of every kind of description lien, lease or encumbrance except the following:

- 1. Easements, agreements and restrictions of record disclosed in said commitment.
- 2. Current taxes not delinquent.
- 3. Whatever matters affecting the Real Estate, if any, disclosed in the above deed.

Vendor has not executed, or permitted anyone in Vendor's behalf to execute, any conveyance, mortgage, lien, lease, security agreement, financing statement or encumbrance of or upon Real Estate or any fixtures attached thereto, except as stated above, which is now outstanding or enforceable against the Real Estate. Vendor has made no contract to sell all or a part of the Real Estate to any person other than the Purchaser, and Vendor has not given to any person an option to purchase all or any part of the Real Estate, which is enforceable or exercisable now or at any time in the future. There are no unpaid claims for labor done upon or material furnished for the Real Estate in respect of which liens have been or may be filed. The improvements upon the Real Estate are all located entirely within the bounds of the Real Estate, and there are no encroachments thereon. There are no existing violations of zoning ordinances or other covenants, conditions and restrictions applicable to the Real Estate.

There is no judgment of any court of the State of Indiana or of any court of the United States that is or may become a lien on the Real Estate. No petition for bankruptcy has been filed by or against Vendor within the last six (6) months, nor is any petition now pending with respect to Vendor for bankruptcy, insolvency or incompetency. Vendor is neither principal nor surety on any bond payable to the State of Indiana.

The Real Estate is now in possession of Vendor and no other person has a right to possession or claims possession of all or any part of the Real Estate. Vendor will deliver possession of Real Estate to Purchaser as stated in the Purchase Agreement, free and clear of any right or claim of any person to the possession of the Real Estate.

Vendor has not received any notices under the Indiana Unsafe Building Law (IC 36-7-9, et seq) regarding an order to board, order to repair, order to demolish, or order to demolish a part of an improvement located on the Real Estate or any modifications of such orders.

Vendor intends that each of the statements made in this affidavit shall be construed as a representation; each of the representations is made for the purpose of inducing Purchaser to purchase the Real Estate; and each of the representations, whether construed jointly or severally, is true, correct and complete. Vendor expressly authorizes Purchaser, Fidelity National Title Insurance Company and all other persons to rely on such representations.

Affidavit (Vendor - Legal) IND1073.doc / Updated: 01.02.20 Printed: 12.20.20 @ 05:25 PM by RJW IN-FT-FIDS-01040.246344-FNW1905415

VENDOR'S AFFIDAVIT

(continued)

Vendor hereby requests Fidelity National Title Insurance Company to issue its policy or policies of title insurance upon said real estate without exception therein as to any pending litigation, and in consideration thereof, and as an inducement therefore, said Vendor does hereby, jointly and severally, agree to indemnify and hold said Fidelity National Title Insurance Company harmless of and from any and all loss, cost, damage and expense of every kind, including attorneys' fees, which said Fidelity National Title Insurance Company shall or may suffer or incur or become liable for under its said policy or policies now to be issued, or any reissue, renewal or extension thereof, or new policy at any time issued upon said real estate, part thereof or interest therein, arising, directly or indirectly, out of or on account of any such pending litigation or in connection with its enforcement of its rights under this agreement. All representations, agreements of indemnity, and waivers herein contained shall inure also to the benefit of any party insured under any policy issued by Fidelity National Title Insurance Company and any action brought hereon may be instituted in the name of Fidelity National Title Insurance Company or said insured or both.

Vendor is not acting, directly or indirectly, in any capacity whatsoever for any foreign country or national thereof, and Vendor is more than eighteen (18) years of age and a citizen of the United States.

If Fidelity National Title Company, LLC issues an ALTA Homeowner's Policy of Title Insurance, then the Vendor certifies the following as true and correct:

- 1. There have been no improvements added to the land or construction on the land within the last year.
- 2. There are no pending repairs or improvements to the street(s) adjacent to the land.
- 3. The land has a single family house/condominium and does not have a separate building, garage or apartment used as a second residence.
- 4. Any improvements we added to the land were authorized by a building permit.
- 5. None of the improvements on the land violate any building permits, zoning, restrictions or covenants.
- 6. None of the improvements on the land encroach over any building lines, easements or property lines.
- 7. No improvements by our neighbors encroach over our property lines.
- 8. The land has actual pedestrian and vehicular access based on the legal right of access to the land.

Vendor has not received any notification concerning the removal of any deduction or exemption that may affect the real estate taxes pertaining to the Real Estate.

Vendor intends that each of the statements made herein shall be construed as a representation; each of the representations is made for the purpose of inducing Purchaser to purchase the Real Estate; and to induce Fidelity National Title Company, LLC to issue its title insurance policy insuring the Purchaser in accordance with the commitment and its terms and conditions thereof; and each of the representations whether construed jointly or severally, is true. Vendor expressly authorizes Purchaser, Fidelity National Title Company, LLC and all other persons to rely on such representations.

IN WITNESS WHEREOF, the undersigned have executed this document on December 22, 2020.

John L. Keithley

Judy M. Keithley

VENDOR'S AFFIDAVIT

(continued)

STATE OF HADIANA Anzona

COUNTY OF LAKE

Maricopa

Before me, a Notary Public in and for said County and State, personally appeared John L. Keithley and Judy M. Keithley who acknowledged the execution of the foregoing instrument, who acknowledged the foregoing instrument to be his/her free act and deed.

Witness my hand and Notarial Seal this 21st day of December, 2020

Signature: Printed: Rence J. Wells

Resident of: Lake County

State of: HNDIANA ACCOUNTS
My Commission expires: July 8, 2025

Maricopa eta

2/26/2021/

THE Notary

pa County Commission # 576532 My Comm. Exp. February 26, 2024

CORNELIUS T WILLIAMS Notary Public - Arizona Maricopa County
Commission # 576532
My Comm. Exp. February 26, 2024

EXHIBIT "A"

Legal Description

For APN/Parcel ID(s): 45-19-35-300-004.000-007

The East 330.00 feet of the following described parcel: The East 30.28 acres off of that part of the East Half of the Southwest Quarter of Section 35, Township 33 North, Range 9 West of the Second Principal Meridian, lying South of what is known and designated as the State Road, said tract running from said State Road South to the South line of said Section, the West line of said tract being parallel with the center line of said section; in Lake County, Indiana.

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Fidelity National Title

PERSONAL UNDERTAKING (GAP)

WHEREAS, the Fidelity National Title Insurance Company, hereinafter referred to as the "Company", is about to issue its title insurance policy or policies or commitments thereof, all hereinafter referred to as the "Title Insurance Policy", No. FNW1905415, in respect to the land described therein.

AND WHEREAS, the Company has raised as title exceptions on the Title Insurance Policy certain defects, liens, encumbrances, adverse claims or other matters, all hereinafter referred to as "Exceptions to Title", described as follows:

Any and all matters affecting title to the subject property arising on or after November 3, 2020 (the last effective date of the subject commitment) and on or before the date and time of the recording of documents to be insured.

AND WHEREAS, the Company has been requested to issue the Title Insurance Policy, and may hereafter, in the ordinary course of its business, issue title insurance policy or policies or date down endorsements or commitments thereof in the form or forms now or then commonly used by the Company, or issue hold harmless or indemnity letters to induce other title insurance companies to issue title insurance policies or commitments therefor, in respect to the land or to some part or parts thereof, or interests therein, all of the foregoing being hereafter referred to as "Future Policies or Date Down Endorsements or Commitments", either omitting all mention of the aforesaid Exceptions to Title, or insuring against loss or damage by reason thereof;

NOW THEREFORE, in consideration of the issuance of the Title Insurance Policy and the payment of One And No/100 Dollar (\$1.00) to the undersigned by the Company, the sufficiency and receipt of which are hereby acknowledged, the undersigned, jointly and severally, for themselves, heirs, personal representatives, and assigns do hereby covenant and agree with the Company: 1) to forever fully protect, defend, and save the Company harmless from and against all the Exceptions to Title, in and from any and all loss, costs, damages, attorneys' fees, and expenses of every kind and nature which it may suffer, expend or incur under, or by reason, or in consequence of the Title Insurance Policy on account, or in consequence, or growing out of the Exceptions to Title or on account of the assertion or enforcement or attempted assertion or enforcement thereof or of any rights existing or hereafter arising, or which may be claimed to exist under, or by reason, or in consequence, or growing out of the Exceptions to Title or any of them; 2) to provide for the defense, at their own expense, on behalf and for the protection of the Company and the parties insured or who may become insured, against loss or damage under the Title Insurance Policy (but without prejudice to the right of the Company to defend if it so elects) in all litigation consisting of actions or proceedings based on any Exceptions to Title which may be asserted or attempted to be asserted, established or enforced in, to, upon, against or in respect to the land or any part thereof, or interest therein; 3) to pay, discharge, satisfy or remove all or any of the items referred to above, when called upon by the Company after thirty (30) days notice in writing and mailed to the undersigned at the address set out below; and 4) that each and every provision herein shall extend and be in force concerning Future Policies or Date Down **Endorsements or Commitments.**

THE FOREGOING NOTWITHSTANDING, it is hereby covenanted and agreed, and expressly made a part of this agreement, that the liability of the undersigned hereunder shall cease and determine at such time as the Company shall have completed all of its various title searches and examination thereof covering the date of recording, required for the issuance of the above policy; provided, however that (1) no rights, interests, liens, claims, encumbrances, or defects in title or any of them, or any rights existing by reason or in consequence thereof or growing out thereof are disclosed by the various title searches and examination thereof; (2) there is then pending no suit, action, or proceedings, either direct or collateral, to assert, establish, or enforce the said mentioned rights, interests, liens, claims, encumbrances, or defects in title, or in any of them, or any rights existing or arising by reason or in consequence thereof or growing out thereof; (3) that no judgment, order, or decree rendered in any such proceeding remains unsatisfied; and (4) that the undersigned is not in default in the performance of any of the terms, covenants, and conditions hereof.

PERSONAL UNDERTAKING (GAP)

(continued)

Nothing contained herein shall be construed so as to obligate the Company to issue Title Insurance Policy, in the form requested herein. However, should the Company issue any such Title Insurance Policy, it will do so in reliance upon the undertaking of the undersigned and the issuance of such Title Insurance Policy shall be the consideration for the above undertaking by the undersigned.

The Company shall have the right at any time hereinafter, after notice to the undersigned below, when it shall deem necessary, expedient, desirable or of interest to do so, in its sole discretion, to pay, discharge, satisfy or remove from the title to said real estate all or any of the items set out above. The undersigned covenants and agree to pay the Company all amounts so expended on demand.

IN WITNESS WHEREOF, the undersigned have executed this document on the date(s) set forth below.

BY: ML Community Craig Hendrix Town Manager	/2・22 とう Date
SELLER(S):	
John L. Keithley	Date
Judy M. Keithley	Date
FIDELITY NATIONAL TITLE Brint Company Name	12 22-20M)
Signature	$\frac{2-22-2020}{\text{Date}}$
By: RENEE J. WELLS, CLOSER Print Name	
Its:	
Print Title	

BORROWER(S).

PERSONAL UNDERTAKING (GAP)

(continued)

Nothing contained herein shall be construed so as to obligate the Company to issue Title Insurance Policy, in the form requested herein. However, should the Company issue any such Title Insurance Policy, it will do so in reliance upon the undertaking of the undersigned and the issuance of such Title Insurance Policy shall be the consideration for the above undertaking by the undersigned.

The Company shall have the right at any time hereinafter, after notice to the undersigned below, when it shall deem necessary, expedient, desirable or of interest to do so, in its sole discretion, to pay, discharge, satisfy or remove from the title to said real estate all or any of the items set out above. The undersigned covenants and agree to pay the Company all amounts so expended on demand.

IN WITNESS WHEREOF, the undersigned have executed this document on the date(s) set forth below.

Town of Lowell	
BY:	
Craig Hendrix Town Manager	Date
SELLER(S):	
John 2 Kentell	12/21/2020
Jenn L. Keithley	Date
July 187 Kerekley	12/21/2020
Judy M. Keithley	Date
FIDELITY NATIONAL TITLE	
Print Company Name	
Signature	Date
By: RENEE J. WELLS, CLOSER Print Name	
Fint Name	
Its:	
Print Title	

BORROWER(S):



NOTICE OF SETTLEMENT AGENT RESPONSIBILITY

Renee Wells, Closer Fidelity National Title Company, LLC 11364 Broadway

Crown Point, IN 46307

Phone: (219)663-5160 Fax: (219)662-0456

Date:

December 20, 2020 Escrow No.: FNW1905415-RJW

Seller(s):

John L. Keithley and Judy M. Keithley

Borrower(s): Town of Lowell Property:

6808 Belshaw Road

Lowell, IN 46356

The Foreign Investment in Real Property Tax Act (FIRPTA), Title 26 U.S.C., Section 1445, and the regulations there under, provide in part, that a transferee (buyer) of a U.S. real property interest from a foreign person must withhold a statutory percentage of the amount realized on the disposition, report the transaction and remit the withholding to the Internal Revenue Service (IRS) within twenty (20) days after the transfer. Fidelity National Title Company, LLC will not determine nor aid in the determination of whether the FIRPTA withholding provisions are applicable to the subject transaction, nor act as a Qualified Substitute under state or federal law, nor furnish tax advice to any party to the transaction. Fidelity National Title Company, LLC will not determine nor aid in the determination of whether the transaction will qualify for an exception or an exemption and is not responsible for the filing of any tax forms with the IRS as they relate to FIRPTA, nor responsible for collecting and holding of any documentation from the buyer or seller on the buyer's behalf for the purpose of supporting a claim of an exception or exemption. Fidelity National Title Company, LLC is not an agent for the buyer for the purposes of receiving and analyzing any evidence or documentation that the seller in the subject transaction is a U.S. citizen or resident alien. Fidelity National Title Company, LLC is not responsible for the payment of this tax and/or penalty and/or interest incurred in connection therewith and such taxes are not a matter covered by the Owner's Policy of Title Insurance to be issued to the buyer. Fidelity National Title Company, LLC is not responsible for the completion of any IRS documents or related forms related to the referenced statute. The buyer is advised: they must independently make a determination of whether the contemplated transaction is subject to the withholding requirement; bear full responsibility for compliance with the withholding requirement if applicable and/or for payment of any tax, interest, penalties and/or other expenses that may be due on the subject transaction; and they are responsible for the completion of any and all forms, including but not limited to applicable IRS documentation. and the mailing of those forms. The Buyer is advised any forms, documents, or information received from Fidelity National Title Company, LLC is not tax or legal advice and should not be construed as such nor treated as a complete representation of FIRPTA requirements. Buyer should seek outside counsel from a qualified individual to determine any and all implications of the referenced statute.

IN WITNESS WHEREOF, the undersigned have executed this document on the date(s) set forth below.

PURCHASER(S):

Town of Lowell

Craig Hendrix

Town Manager

22.20

Date

5 11 156



ACKNOWLEDGMENT AND RECEIPT OF PROPERTY TAX BENEFITS FORM

File No: FNW1905415-RJW

The undersigned, Town of Lowell (Borrower(s)) hereby acknowledge that Fidelity National Title Company, LLC has provided us/me with a copy of the Indiana Property Tax Benefits Form 51781 (R12 / 1-16) setting forth the deductions and credits available for property taxes on real property in Indiana in connection with the purchase/refinance transaction on the property located at the following address:

6808 Belshaw Road, Lowell, IN 46356

Executed this 22nd day of December, 2020.

Town of Lowell

Craig Hendrix

Town Manager

12.22.20

Date



Fidelity National Title Company, LLC Renee Wells 11364 Broadway, Crown Point, IN 46307 Phone: (219)663-5160 Fax: (219)662-0456

WIRE FRAUD ALERT **IMPORTANT! YOUR FUNDS MAY BE AT RISK**

This Notice is not intended to provide legal or professional advice. If you have any questions, please consult with a lawyer.

Realtors®, Real Estate Brokers, Closing Attorneys, Buyers and Sellers are targets for wire fraud and many have lost hundreds of thousands of dollars because they simply relied on the wire instructions received via email, without further verification.

A fraudster will hack into a participant's email account to obtain information about upcoming real estate transactions. After monitoring the account to determine the likely timing of a closing, the fraudster will send an email to the Buyer purporting to be the escrow agent or another party to the transaction. The fraudulent email will contain new wiring instructions or routing information, and will request that the Buyer send funds to a fraudulent account.

Please be advised that the wire instructions listed below are the only wire instructions we will send you. This is the only form that should be used to wire funds to us in this transaction. If you receive another email or unsolicited call purporting to alter these instructions, please immediately call us at: (219)663-5160.

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BMO HARRIS BANK N.A.

ABA NO.:

071000288

ACCOUNT NO.: 2547305

ACCOUNT HOLDER: Fidelity National Title Company, LLC REFERENCE: FNW1905415 / 6808 Belshaw Road, Lowell

Closing funds in the form of ACH Electronic Transfers will NOT be accepted.

In addition, the following non-exclusive self-protection strategies are recommended to minimize exposure to possible wire fraud.



NEVER RELY on emails or other communications purporting to change wire instructions. Parties to a transaction rarely change wire instructions in the course of a transaction.



DO NOT FORWARD wire instructions to other parties without first verbally verifying the instructions from the sending party.

ALWAYS VERIFY WIRE INSTRUCTIONS, specifically the ABA routing number and account number, by calling the party who is receiving the funds. DO NOT RELY on other parties calling you.



Obtain the number of your Realtor®, Real Estate Broker and your escrow officer as soon as an escrow account is opened.

DO NOT use the phone number provided in the email containing the instructions, use phone numbers you have called before or can otherwise verify. DO NOT send an email to verify as the email address may be incorrect or the email may be intercepted by the fraudster.

For more information on wire-fraud scams or to report an incident, please refer to the following links:

Federal Bureau of Investigation: http://www.fbi.gov

Internet Crime Complaint Center: http://www.ic3.gov

ACKNOWLEDGEMENT OF RECEIPT

Your signature below acknowledges receipt of this Wire Fraud Alert. Buyer **Buyer 2** Signature Signature Craig Hendrix **Printed Name Printed Name** 501 E MAIN **Address Address** Date **Phone Number**

Wire Fraud Alert

Original Effective Date: 7/5/2017 Current Version Date: 3/01/2018

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Page 1 of 1

FNW1905415-RJW



COMPANIES

6400 N. Northwest Highway, Suite 4 Chicago, IL 60631

PROJECT NAME: Lowell - Public Works Facility

JOB #: 2101 SUB JOB #: ADDRESS: ESTIMATED BY: TDR
CHECKED BY: GCN

ESTIMATE DATE: 6/10/2024 PLAN DATED: 7/15/2023

START DATE: TBD

NUMBER OF UNITS: Garage

GROUND FLOOR: 16,057

Main: 847-825-9400

1

SECOND FLOOR:

BASEMENT

TOTAL GROSS AREA: 16,057

CODE	DESCRIPTION	COST/SF	TOTAL COST	NOTES
10000	GENERAL REQUIREMENTS	12.89	206,900.00	
20000	EXISTING CONDITIONS	0.31	5,000.00	
30000	CONCRETE	51.02	819,198.00	
40000	MASONRY	43.78	702,900.00	
50000	METALS	35.98	577,700.00	
60000	WOOD, PLASTICS, COMPOSITES	13.01	208,900.00	
70000	THERMAL PROTECTION	14.13	226,855.00	
80000	OPENINGS	17.36	278,673.00	
90000	FINISHES	23.70	380,500.00	
100000	SPECIALTIES	3.31	53,200.00	
110000	EQUIPMENT	0.00	0.00	
120000	FURNISHINGS	1.56	25,000.00	
130000	SPECIAL CONSTRUCTION	0.00	0.00	
140000	ELEVATORS	0.00	0.00	
210000	FIRE SUPPRESSION	0.00	0.00	
220000	PLUMBING	37.12	596,000.00	
230000	HVAC	13.24	212,550.00	
260000	ELECTRICAL	43.27	694,745.00	
270000	COMMUNICATIONS	0.00	0.00	
280000	ELECTRONIC SAFETY & SECURITY	0.00	0.00	
310000	EARTHWORK	14.65	235,250.00	
320000	EXTERIOR IMPORVEMENTS	49.15	789,133.00	
330000	UTILITIES	1.24	19,900.00	

	SUBTOTAL COSTS:	6,032,404.00	
SITE SUPERVISION		0.00	
CONTINGENCIES		904,860.60	
SUBCONTRACTOR BONDS		0.00	
BUILDERS RISK INSURANCE		0.00	
GENERAL LIABILITY INSURANCE		0.00	
GC OVERHEAD & PROFIT		693,726.46	
PERFORMANCE BOND		0.00	
SALES TAX		0.00	
	TOTAL COSTS:	7,630,991.06	
	COST/SF	475.24	

DIV	DESCRIPTION	Qty.	Units Unit Cost	Total Cost	Cost/Unit	Cost/GSF	% of Hard	% of Total	Notes
DIV	DESCRIPTION	city.	One Sost	10ta 003t	303001111	0031/001	70 OI IIdi'd	70 OI 1 Otal	Notes
010000	GENERAL REQUIREMENTS - TOTAL			206,900.00	206,900.00	12.89	3.43%	2.71%	
012000 012100	General Conditions Construction & Silt Fence			78,000.00 10,000.00	78,000.00 10,000.00	4.86 0.62	1.29% 0.17%		On-Site Supervision. Allowance.
012200	Toilet Facilities (12 Months)			1,800.00	1,800.00	0.02	0.03%	0.02%	Allowance.
012300	Temporary Utilities, Electricity & Gas Heat			0.00	0.00	0.00	0.00%	0.00%	
012400 012500	Waste & Trash Removal Misc Labor (Clean Up)			9,600.00 7,500.00	9,600.00 7,500.00	0.60	0.16% 0.12%		Dumpsters. Labor Only.
012600	Post Construction Cleaning			5,000.00	5,000.00	0.47	0.12%	0.10%	
	Misc Tool Rental			2,000.00	2,000.00	0.12	0.03%		Allowance.
012800 013000	Street Sweeper Mobilization			2,000.00 80,000.00	2,000.00 80,000.00	0.12 4.98	0.03% 1.33%	0.03% 1.05%	Estimate.
014000	Hoisting			0.00	0.00	0.00	0.00%	0.00%	
015000	Temporary Facilities (Construction Trailer)			6,000.00	6,000.00	0.37	0.10%	0.08%	12 Months.
016000	Product Requirements Execution and Closeout Requirements			0.00	0.00	0.00	0.00%	0.00%	Fatimata
017000 018000	Performance Requirements			5,000.00	5,000.00	0.00	0.00%	0.07%	Estimate.
019000	Life Cycle Activities			0.00	0.00	0.00	0.00%	0.00%	
020000	EXISTING CONDITIONS - TOTAL			5,000.00	5,000.00	0.31	0.08%	0.07%	
023000	Subsurface Investigations (Soil Testing)			5,000.00	5,000.00	0.31	0.08%	0.07%	Allowance.
024000	Demolition and Structure Moving			0.00	0.00	0.00	0.00%	0.00%	
025000 025100	Site Remediation Site Clearing			0.00	0.00	0.00	0.00%	0.00%	
026000	Contaminated Site Material Removal			0.00	0.00	0.00	0.00%	0.00%	
027000	Water Remediation			0.00	0.00	0.00	0.00%	0.00%	
028000	Facility Remediation			0.00	0.00	0.00	0.00%	0.00%	
030000	CONCRETE - TOTAL			819,198.00	819,198.00	51.02	13.58%	10.74%	
031000	Concrete Forming and Accessories			0.00	0.00	0.00	0.00%	0.00%	
032000	Concrete Reinforcing			0.00	0.00	0.00	0.00%	0.00%	Lohor & Motoriolo
033000 033100	Cast-in-Place Concrete Foundation Concrete Curbing			404,000.00 45,400.00	404,000.00 45,400.00	25.16 2.83	6.70% 0.75%		Labor & Materials. Labor & Materials.
033200	8" Reinforced Concree Pavement			139,800.00	139,800.00	8.71	2.32%	1.83%	
033300	Public Sidewalks			0.00	0.00	0.00	0.00%	0.00%	
033400 034000	Private Sidewalks Indoor Concrete Slab			5,200.00 224,798.00	5,200.00 224,798.00	0.32 14.00	0.09% 3.73%	0.07%	Labor & Materials. Labor & Materials.
035000	Cast Decks and Underlayment			0.00	0.00	0.00	0.00%	0.00%	Labor & Materials.
036000	Grouting			0.00	0.00	0.00	0.00%	0.00%	
037000	Mass Concrete			0.00	0.00	0.00	0.00%	0.00%	
038000	Concrete Cutting			0.00	0.00	0.00	0.00%	0.00%	
040000	MASONRY - TOTAL			702,900.00	702,900.00	43.78	11.65%	9.21%	
042000	Precast Concrete Panels			520,500.00	520,500.00	32.42	8.63%		AVAN Precast Concrete
044000 045000	Stone Assemblies Masonry & Stone			0.00	0.00 182,400.00	0.00	0.00% 3.02%	0.00%	Labor & Materials.
046000	Corrosion-Resistant Masonry			0.00	0.00	0.00	0.00%	0.00%	Edbor & Materials.
047000	Manufactured Masonry			0.00	0.00	0.00	0.00%	0.00%	
050000	METALS - TOTAL			577.700.00	577,700.00	35.98	9.58%	7.57%	
051000	Structural Metal Framing			0.00	0.00	0.00	0.00%	0.00%	Hugget-Betten Corp
052000	Metal Joists			537,700.00	537,700.00	33.49	8.91%		De Pasquale Steel
053000	Metal Decking			0.00	0.00	0.00	0.00%	0.00%	Included in 052000
054000 055000	Cold Formed Metal Framing Metal Fabrications (Railings)			40,000.00	40.000.00	2.49	0.00%	0.00%	Labor & Materials.
057000	Decorative Metal (Wrought Iron Fence)			0.00	0.00	0.00	0.00%	0.00%	
000000	WOOD BLASTICS COMPOSITES TOTAL			202.000.00	200 000 00	40.01	0.4001	0.740	
060000 061000	WOOD, PLASTICS, COMPOSITES - TOTAL Metal Stud Framing & Drywall			208,900.00 84,900.00	208,900.00 84,900.00	13.01 5.29	3.46% 1.41%	2.74% 1.11%	Hugget-Betten Corp
	Finish Carpentry			44,000.00	44,000.00	2.74	0.73%		Labor Only
064000	Architectural Woodwork (Trim & Doors)			50,000.00	50,000.00	3.11	0.83%	0.66%	Estimate.
065000 066000	Structural Plastics Plastic Entrications			0.00	0.00	0.00	0.00%	0.00%	
066000	Plastic Fabrications Structural Composites (Lumber Supplies)			30,000.00	30,000.00	1.87	0.00%		Allowance for Miscellaneous Lumber.
068000	Composite Fabrications			0.00	0.00	0.00	0.00%	0.00%	
070000	THERMAL PROTECTION - TOTAL			226 855 22	200 055 00	4440	2.760/	2.070/	
070000	Dampproofing and Waterproofing			226,855.00	226,855.00	14.13	3.76%	2.97% 0.00%	
	Thermal Protection (Thermal & sound Insulation)			11,440.00	11,440.00	0.71	0.19%		Labor & Materials
072500	Weather Barriers			0.00	0.00	0.00	0.00%	0.00%	
073000 074000	Steep Slope Roofing Roofing and Siding Panels			0.00	0.00	0.00	0.00%	0.00%	
075000	Membrane Roofing			215,415.00	215,415.00	13.42	3.57%		Labor & Materials
076000	Flashing and Sheet Metal			0.00	0.00	0.00	0.00%	0.00%	
077000	Roof and Wall Specialties and Accessories			0.00	0.00	0.00	0.00%	0.00%	
078000 079000	Fire and Smoke Protection Joint Protection (Exterior Caulking)			0.00	0.00	0.00	0.00%	0.00%	
	OPENINGS - TOTAL			278,673.00	278,673.00	17.36	4.62%	3.65%	
081000 083000	Doors and Frames Specialty Doors Overhead Doors			0.00 176,673.00	0.00 176,673.00	0.00	0.00% 2.93%	0.00% 2.32%	Materials & Installation.
084000	Entrances, Storefronts, and Curtain Walls			12,000.00	12,000.00	0.75	0.20%		Front Entrance Door Allowance
085000	Windows			80,000.00	80,000.00	4.98	1.33%	1.05%	Materials & Installation.
086000	Roof Windows and Skylights			0.00	0.00	0.00	0.00% 0.17%	0.00%	Allowance
087000 088000	Hardware Glazing (Mirrors & Shower Doors)			10,000.00	10,000.00	0.62	0.17%	0.13%	Allowance Included in 085000
089000	Louvers and Vents			0.00	0.00	0.00	0.00%	0.00%	

DIV	DESCRIPTION	Qty.	Units	Unit Cost	Total Cost	Cost/Unit	Cost/GSF	% of Hard	% of Total	Notes
DIV	DESCRIPTION	Qty.	Units	Unit Cost	Total Cost	Cost/Unit	Cost/GSF	% of Hard	% of Total	Notes
090000	FINISHES - TOTAL				380,500.00	380,500.00	23.70	6.31%	4.99%	
092000	Plaster and Gypsum Board				0.00	0.00	0.00	0.00%	0.00%	Included in Hugget-Betten quote - 051000
	Tiling				140,000.00	140,000.00	8.72	2.32%		Labor & Materials.
095000	Ceilings				0.00	0.00	0.00	0.00%	0.00%	Included in Hugget-Betten quote - 051000
096000	Flooring Finishes				0.00	0.00	0.00	0.00%	0.00%	
097000 098000	Carpeting & Rugs Acoustic Treatment (Ceiling)				0.00	0.00	0.00	0.00%	0.00%	Included in 061000
	Painting and Coatings				240,500.00	240,500.00	14.98	3.99%		Estimate
000000	Talking and Coddings				210,000.00	210,000.00	11.00	0.0070	0.1070	Zourrate .
100000	SPECIALTIES - TOTAL				53,200.00	53,200.00	3.31	0.88%	0.70%	
	Information Specialties (Signage)				15,000.00	15,000.00	0.93	0.25%	0.20%	Allowance
	Interior Specialties (Toilet Accessories & Grab Bars)				8,000.00	8,000.00	0.50	0.13%		Allowance
103000	Fireplaces and Stoves Safety Specialties				0.00	0.00	0.00	0.00%	0.00%	
104000 105000	Storage Specialties (Storage Lockers)				20,000.00	20,000.00	1.25	0.00%		Allowance
	Exterior Specialties (Closet Shelving)				10,000.00	10,000.00	0.62	0.33%		Allowance
	Other Specialties (Mailboxes)				200.00	200.00	0.01	0.00%		Allowance.
	EQUIPMENT - TOTAL				0.00	0.00	0.00	0.00%	0.00%	
	Vehicle and Pedestrian Equipment				0.00	0.00	0.00	0.00%	0.00%	
	Security, Detention, and Baking Equipment				0.00	0.00	0.00	0.00%	0.00%	
	Commercial Equipment (Wash Tunnel) Residential Equipment (Appliances)				0.00	0.00	0.00	0.00%	0.00%	
	Foodservice Equipment (Appliances)				0.00	0.00	0.00	0.00%	0.00%	
	Education and Scientific Equipment				0.00	0.00	0.00	0.00%	0.00%	
	Entertainment Equipment				0.00	0.00	0.00	0.00%	0.00%	
116500	Athletic and Recreational Equipment				0.00	0.00	0.00	0.00%	0.00%	
	Healthcare Equipment				0.00	0.00	0.00	0.00%	0.00%	
118000	Collection and Disposal Equipment				0.00	0.00	0.00	0.00%	0.00%	
120000	FURNISHINGS - TOTAL				25 000 00	25 000 00	4 50	0.440/	U 330/	
120000 121000	Art				25,000.00	25,000.00	1.56	0.41% 0.00%	0.33% 0.00%	
122000	Window Treatments				0.00	0.00	0.00	0.00%	0.00%	
	Casework (Kitchen Cabinets & Bathroom Vanities)				20,000.00	20,000.00	1.25	0.33%		Allowance
124000	Granite / Marble / Stone Countertops				5,000.00	5,000.00	0.31	0.08%	0.07%	Allowance
125000	Furniture				0.00	0.00	0.00	0.00%	0.00%	
126000	Multiple Seating				0.00	0.00	0.00	0.00%	0.00%	
129000	Other Furnishings				0.00	0.00	0.00	0.00%	0.00%	
130000	SPECIAL CONSTRUCTION - TOTAL				0.00	0.00	0.00	0.00%	0.00%	
131000	Special Facility Components				0.00	0.00	0.00	0.00%	0.00%	
131100	Swimming Pools				0.00	0.00	0.00	0.00%	0.00%	
131700	Hot Tubs				0.00	0.00	0.00	0.00%	0.00%	
132000	Special Purpose Rooms				0.00	0.00	0.00	0.00%	0.00%	
133000	Special Structures				0.00	0.00	0.00	0.00%	0.00%	
134000	Integrated Construction				0.00	0.00	0.00	0.00%	0.00%	
135000	Special Instrumentation				0.00	0.00	0.00	0.00%	0.00%	
140000	ELEVATORS - TOTAL				0.00	0.00	0.00	0.00%	0.00%	
	Dumbwaiters				0.00	0.00	0.00	0.00%	0.00%	
142000	Elevators				0.00	0.00	0.00	0.00%	0.00%	
143000	Escalators and Moving Walks				0.00	0.00	0.00	0.00%	0.00%	
144000	Lifts				0.00	0.00	0.00	0.00%	0.00%	
147000	Turntables				0.00	0.00	0.00	0.00%	0.00%	
148000	Scaffolding Wash Tunnel Conveying Equipment				0.00	0.00	0.00	0.00%	0.00%	
149000	wash fullier Conveying Equipment				0.00	0.00	0.00	0.0076	0.00%	
210000	FIRE SUPPRESSION - TOTAL				0.00	0.00	0.00	0.00%	0.00%	
	Water-Based Fire-Suppression Systems				0.00	0.00	0.00	0.00%	0.00%	
	Fire-Extinguishing Systems (Extinguishers)				0.00	0.00	0.00	0.00%	0.00%	
	Fire Pumps				0.00	0.00	0.00	0.00%	0.00%	
214000	Fire Suppression Water Storage				0.00	0.00	0.00	0.00%	0.00%	
220000	PLUMBING - TOTAL				596,000.00	596,000.00	37.12	9.88%	7.81%	
	Plumbing Piping				388,000.00	388,000.00	24.16	6.43%		Reichelt Plumbing, Inc.
	Gas Piping & Compressed Air Piping				208,000.00	208,000.00	12.95	3.45%		Labor & Materials
	Plumbing Fixtures				0.00	0.00	0.00	0.00%	0.00%	
225000	Pool and Fountain Plumbing Systems				0.00	0.00	0.00	0.00%	0.00%	
	HVAC - TOTAL				212,550.00	212,550.00	13.24	3.52%	2.79%	
	Facility Fuel Systems HVAC Piping and Pumps				0.00	0.00	0.00	0.00%	0.00%	
	HVAC Piping and Pumps HVAC Air Distribution				212,550.00	212,550.00	13.24	3.52%		Circle 'R' Mechanical Inc.
	HVAC Testing				0.00	0.00	0.00	0.00%	0.00%	TIM
234000	HVAC Air Cleaning Devices				0.00	0.00	0.00	0.00%	0.00%	
	Central Heating Equipment				0.00	0.00	0.00	0.00%	0.00%	
	Central Cooling Equipment				0.00	0.00	0.00	0.00%	0.00%	
	Central HVAC Equipment				0.00	0.00	0.00	0.00%	0.00%	
238000	Decentralized HVAC Equipment				0.00	0.00	0.00	0.00%	0.00%	
260000	ELECTRICAL - TOTAL				694,745.00	694,745.00	43.27	11.52%	9.10%	
	Medium-Voltage Electrical Distribution				650,700.00	650,700.00	40.52	10.79%		Sargent Electric Company
	Low-Voltage Electrical Transmission				0.00	0.00	0.00	0.00%	0.00%	
	Electrical Power Generating & Storage Equipment				0.00	0.00	0.00	0.00%	0.00%	
					0.00	0.00	0.00	0.00%	0.00%	
263000 264000	Electrical and Cathodic Protection							1		
263000 264000 265000	Electrical and Cathodic Protection Light Fixtures				20,000.00	20,000.00	1.25	0.33%	0.26%	Allowance
263000 264000 265000 265100	Electrical and Cathodic Protection							1	0.26% 0.06%	Allowance Estimate for outdoor poles & light fixtures.

DIV	DESCRIPTION	Qty.	Units	Unit Cost	Total Cost	Cost/Unit	Cost/GSF	% of Hard	% of Total	Notes
270000	COMMUNICATIONS - TOTAL				0.00	0.00	0.00	0.00%	0.00%	
271000	Structured Cabling				0.00	0.00	0.00	0.00%	0.00%)
	Data Communications				0.00	0.00		0.00%	0.00%	
					0.00	0.00	0.00	0.00%	0.00%	
274000	Audio-Voice Communications (Intercomm)				0.00	0.00	0.00	0.00%	0.00%	
275000	Distributed Communications and Monitoring Systems				0.00	0.00	0.00	0.00%	0.00%	
280000	ELECTRONIC SAFETY & SECURITY - TOTAL				0.00	0.00	0.00	0.00%	0.00%	
281000	Electronic Access Control & Intrusion Detection				0.00	0.00	0.00	0.00%	0.00%	
282000	Electronic Surveillance				0.00	0.00	0.00	0.00%	0.00%	
282100	Fire Alarm				0.00	0.00	0.00	0.00%	0.00%	
283000	Electronic Detection and Alarm				0.00	0.00	0.00	0.00%	0.00%	
284000	Electronic Monitoring and Control				0.00	0.00	0.00	0.00%	0.00%	
								0.00,0	0.00,	
310000	EARTHWORK - TOTAL				235,250.00	235,250.00	14.65	3.90%	3.08%	
311000	Site Clearing				12,000.00	12,000.00	0.75	0.20%		Machinery & Trucking.
312000	Earth Moving				19,950.00	19,950.00	1.24	0.33%	0.26%	Machinery & Trucking.
312100	Excavation For Parking Lots & Driveways				42,500.00	42,500.00	2.65	0.70%	0.56%	Machinery & Trucking.
313000	Site Grading				100,000.00	100,000.00	6.23	1.66%	1.31%	Machinery & Trucking.
314000	Erosion control				20,000.00	20,000.00	1.25	0.33%	0.26%	,
314100	Geofabric				20,400.00	20,400.00	1.27	0.34%	0.27%	
314200	Geotextile				20,400.00	20,400.00	1.27	0.34%	0.27%	
315000	Excavation Support and Protection				0.00	0.00	0.00	0.00%	0.00%	
316000	Special Foundations & Load-Bearing Elements				0.00	0.00	0.00	0.00%	0.00%	
317000	Tunneling and Mining				0.00	0.00	0.00	0.00%	0.00%	
								40.000/	40.040/	
320000	EXTERIOR IMPROVEMENTS - TOTAL				789,133.00	789,133.00	49.15	13.08%	10.34%	
321000	Bases &Brick Paving				0.00	0.00	0.00	0.00%	0.00%	
321100	Trash Enclosure				3,000.00	3,000.00	0.19	0.05% 3.53%		Allowance, not shown on site plan.
321200	Salt Shed				212,760.00	212,760.00	13.25			1,100 ton capacity.
321300 322000	Fueling Station Surveying, Site Layout & Location				30,000.00 4,000.00	30,000.00 4,000.00	1.87 0.25	0.50% 0.07%	0.39%	Allowance
323000	Security Fence & Gates				89,700.00	89,700.00	5.59	1.49%	1.18%	
323100	Water Service & Hydrant				19,800.00	19,800.00	1.23	0.33%		Add \$16,000-\$25,000 if Meter vault is required.
323200	Sanitary Sewer				24,000.00	24,000.00	1.49	0.40%		Labor & Materials.
323300	Storm & Sanitary Manholes				3,600.00	3,600.00	0.22	0.06%	0.05%	
323400	Storm Sewer				31,000.00	31,000.00	1.93	0.51%	0.41%	
323500	Asphalt Paving & Striping				97,849.00	97,849.00	6.09	1.62%		Includes machinery & materials.
327000					215,424.00	215,424.00	13.42	3.57%		Includes machinery & materials.
328000	Irrigation				18,000.00	18,000.00	1.12	0.30%		Allowance including labor & equipment.
329000	Planting (Landscaping)				40,000.00	40,000.00	2.49	0.66%	0.52%	Allowance including labor & plantings
330000	UTILITIES - TOTAL				19,900.00	19,900.00	1.24	0.33%	0.26%	
331000	Water Utilities				0.00	0.00	0.00	0.00%	0.00%	
331100	Utility Services Cut-Offs & Fees				0.00	0.00	0.00	0.00%	0.00%	
332000	Wells				0.00	0.00	0.00	0.00%	0.00%	
333000	Sanitary Sewage Utilities				0.00	0.00	0.00	0.00%	0.00%)
334000	Storm Drainage Utilities				0.00	0.00	0.00	0.00%	0.00%	
335000	Fuel Distribution Utilities (Gas Service)				8,900.00	8,900.00	0.55	0.15%	0.12%	Labor & Materials.
336000	Hydraulic and Steam Energy Utilities				0.00	0.00	0.00	0.00%	0.00%	1
	Electrical Utilities (ComEd/Transformer & Pad)				8,000.00	8,000.00	0.50	0.13%		Allowance.
338000	Communications Utilities (AT&T/ComCast)				3,000.00	3,000.00	0.19	0.05%	0.04%	Allowance
	SUPTOTAL (Hard Costs)		+	-	6.022.404.02	6 022 404 22	275.60		70.050/	
	SUBTOTAL (Hard Costs)				6,032,404.00 0.00	6,032,404.00 0.00	375.69 0.00		79.05%	
	Site Supervision	 	+	 	904,860.60	904,860.60	56.35		11.86%	
	Contingencies (15%) Subcontractor Bonds				904,860.60	904,860.60	0.00		0.00%	
	Builders Risk Insurance				0.00	0.00				By Owner
	General Liability Insurance		1		0.00	0.00	0.00			Included in GC Fee.
	GC Overhead & Profit				693,726.46	693,726.46	43.20		9.09%	
	Performance Bond	1	1		0.00	0.00	0.00		0.00%	
	Sales Tax		1		0.00	0.00			0.00%	
	Total		1		7,630,991.06	7,630,991.06			100.00%	

SITE PLAN ARCHITECT SHEET INDEX

NERI ARCHITECTS 6400 N. NORTHWEST HWY. SUITE 4

CHICAGO, IL 60631 P. 847.825.9400 LICENSE # AR12100139 EXPIRATION DATE: OCTOBER, 2023

CODE SUMMARY

PROJECT DATA

SCOPE OF WORK:

NEW PUBLIC WORKS FACILITY

APPLICABLE CODES:

2014 Indiana Building Code based on: 2012 International Building Code (1st printing), with Indiana

2014 Indiana Fire Prevention Code based on: 2012 International Fire Code

Indiana Supplementary Fire Safety Rules

2010 Indiana Energy Conservation Code Indiana Plumbing Code (675 IAC 16, IPC), based on: 1997 Uniform Plumbing Code, with Indiana Amendments Indiana Electrical Code (675 IAC 17, IEC), based on: 2008 National Electrical Code (1st printing), with Indiana **Amendments**

2014 Indiana Mechanical Code (675 IAC 18, IMC), based on: 2012 International Mechanical Code with 2008

Indiana Amendments 2014 Indiana Fuel Gas Code (675 IAC 25, IFGC), based on: 2012 International Fuel Gas Code (1st printing), with

Indiana Amendments **Indiana Handicapped Accessibility Code**

EXISTING USE:

VACANT

BUILDING DESCRIPTION

USE GROUP: WHAREHOUSE S-1 Moderate-hazard storage

CONSTRUCTION TYPE: II-B

BULDING AREA: 16,0333.0 s.f. ARCHITECTURAL SALT SHED STRUCTURE A-0.0 SITE PLAN & PROJECT INFO

CIVIL

C-1 SITE DIMENSION PLAN

SITE GRADING PLAN C-3 SITE LIGHTING PLAN

ARCHITECTURAL

A-1.0 GENERAL NOTES A-2.0 FOUNDATION PLAN

A-2.1 FLOOR PLAN(S)

A-2.2 FLOOR PLAN BLOW UP A-2.3 REFLECTED CLG'S - OFFICES

A-2.4 ROOF PLAN

A-3.0 INTERIOR ELEVATIONS

A-3.1 INTERIOR ELEVs WOMEN'S BATH A-3.2 INTERIOR ELEVs MEN'S BATH

A-4.1 LIFE SAFETY AND WALL TYPES

A-5.0 BUILDING SECTIONS

A-8.0 ACCESSORY STRUCTURE

A-4.0 ELEVATIONS

A-7.0 FIRESTOPPING DETAILS

A-6.0 DOOR / WINDOW SCHEDULE

ELECTRICAL

S-101 GENERAL NOTES, SEC. & DETAILS

S-201 FOUNDATION PLAN

STRUCTURE

S-101 GENERAL NOTES S-201 FOUNDATION PLAN

S-202 FLOOR PLAN S-203 ROOF PLAN

S-301 SECTIONS & DETAILS

S-302 SECTIONS & DETAILS

MECHANICAL

MECHANICAL PLANS

M-2 MECHANICAL ROOF PLAN

MECH SCHEDULES, NOTES & DETAILS M-4 MECH SCHEDULES, NOTES & DETAILS

MECH DETAILS & SCHEDULES

M-6 MECH DETAILS & SCHEDULES

E-1 ELECTRIC FLOOR PLAN

E-2 ELECTRIC ROOF PLAN

E-3 ELECTRICAL LIGHTING PLAN

ELECTRICAL POWER & LIGHTING PLAN ELECTRIC SCHEDULES, NOTES, & DETAILS

ELECTRIC SCHEDULES, NOTES, & DETAILS

E-7 ELECTRIC SCHEDULES, NOTES, & DETAILS E-8 ELECTRIC SCHEDULES, NOTES, & DETAILS

ELECTRIC SCHEDULES, NOTES, & DETAILS

PLUMBING

P-1 PLUMBING FLOOR PLAN

P-2 PLUMBING ROOF PLAN


PLUMBING MISC. PLANS

PLUMBING SCHEDULES, NOTES, & DETAILS

PLUMBING SCHEDULES, NOTES, & DETAILS

P-6 PLUMBING SCHEDULES, NOTES, & DETAILS



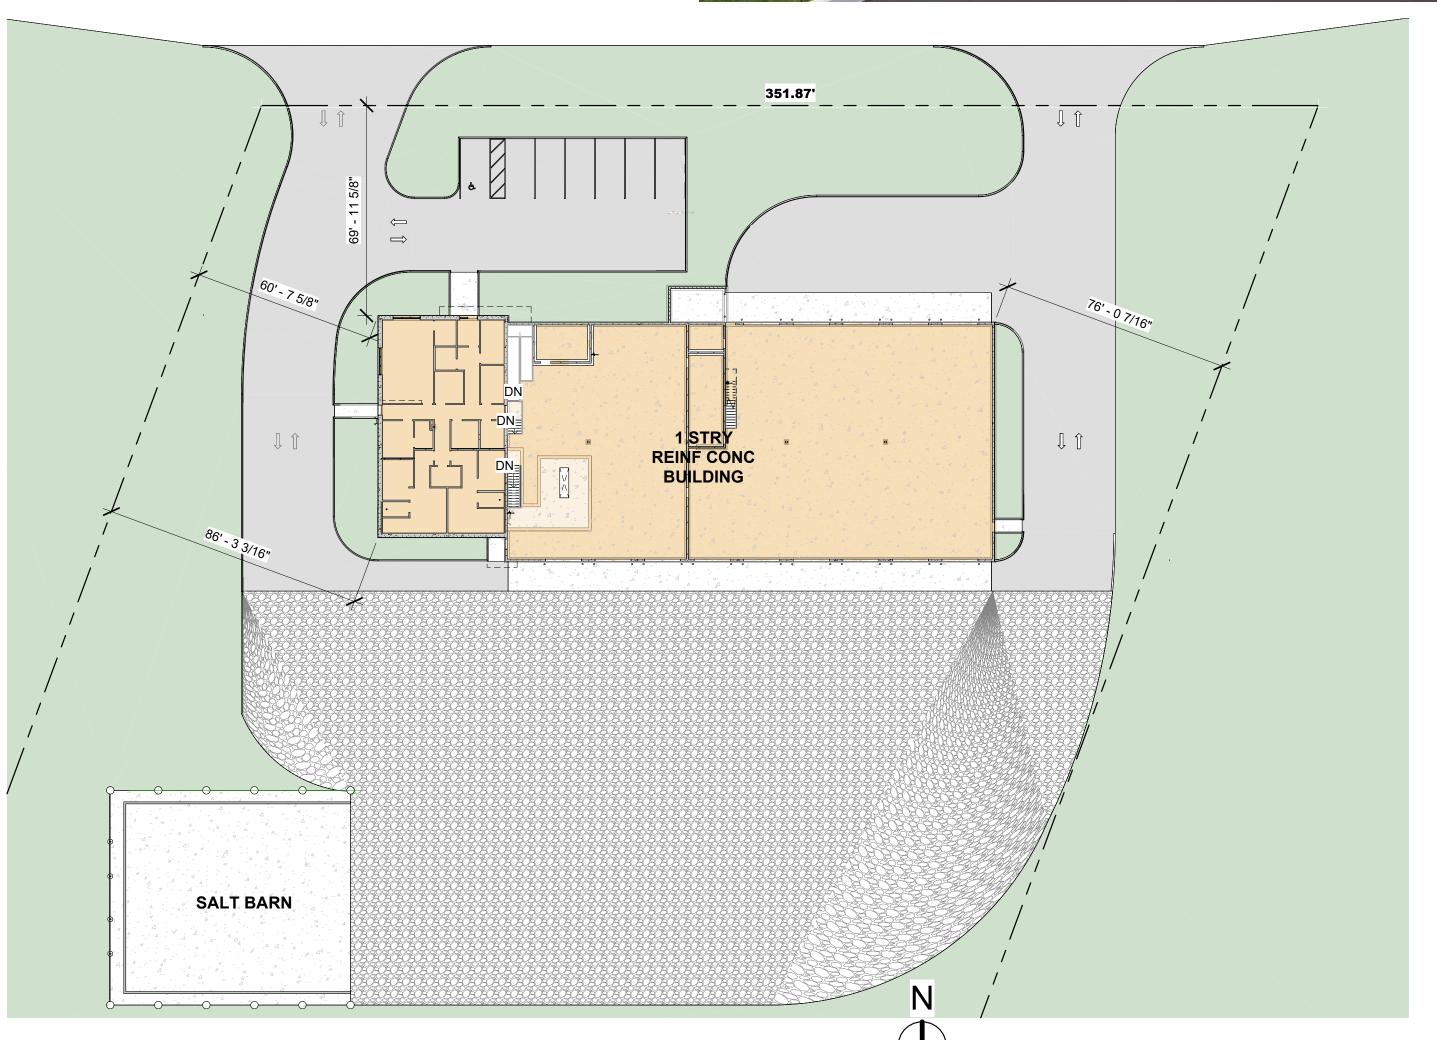




A-8.0

SALT

BARN

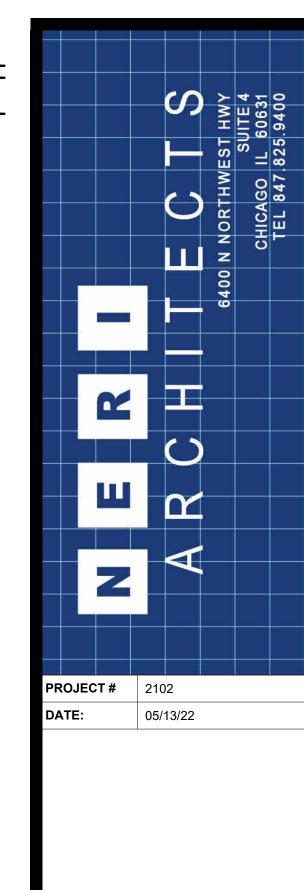

1 STRY

REINF CONC

BUILDING


WORKS

PUBLIC 07.15.23 | ISSUED FOR BID **REVISIONS** DRAWN BY: Author APPROVED BY: Checker AS NOTED DESCRIPTION: SITE PLAN &

PROJECT INFO

SHEET NO.

2 SITE PLAN (Blow-Up)
SCALE: 1/32" = 1'-0"

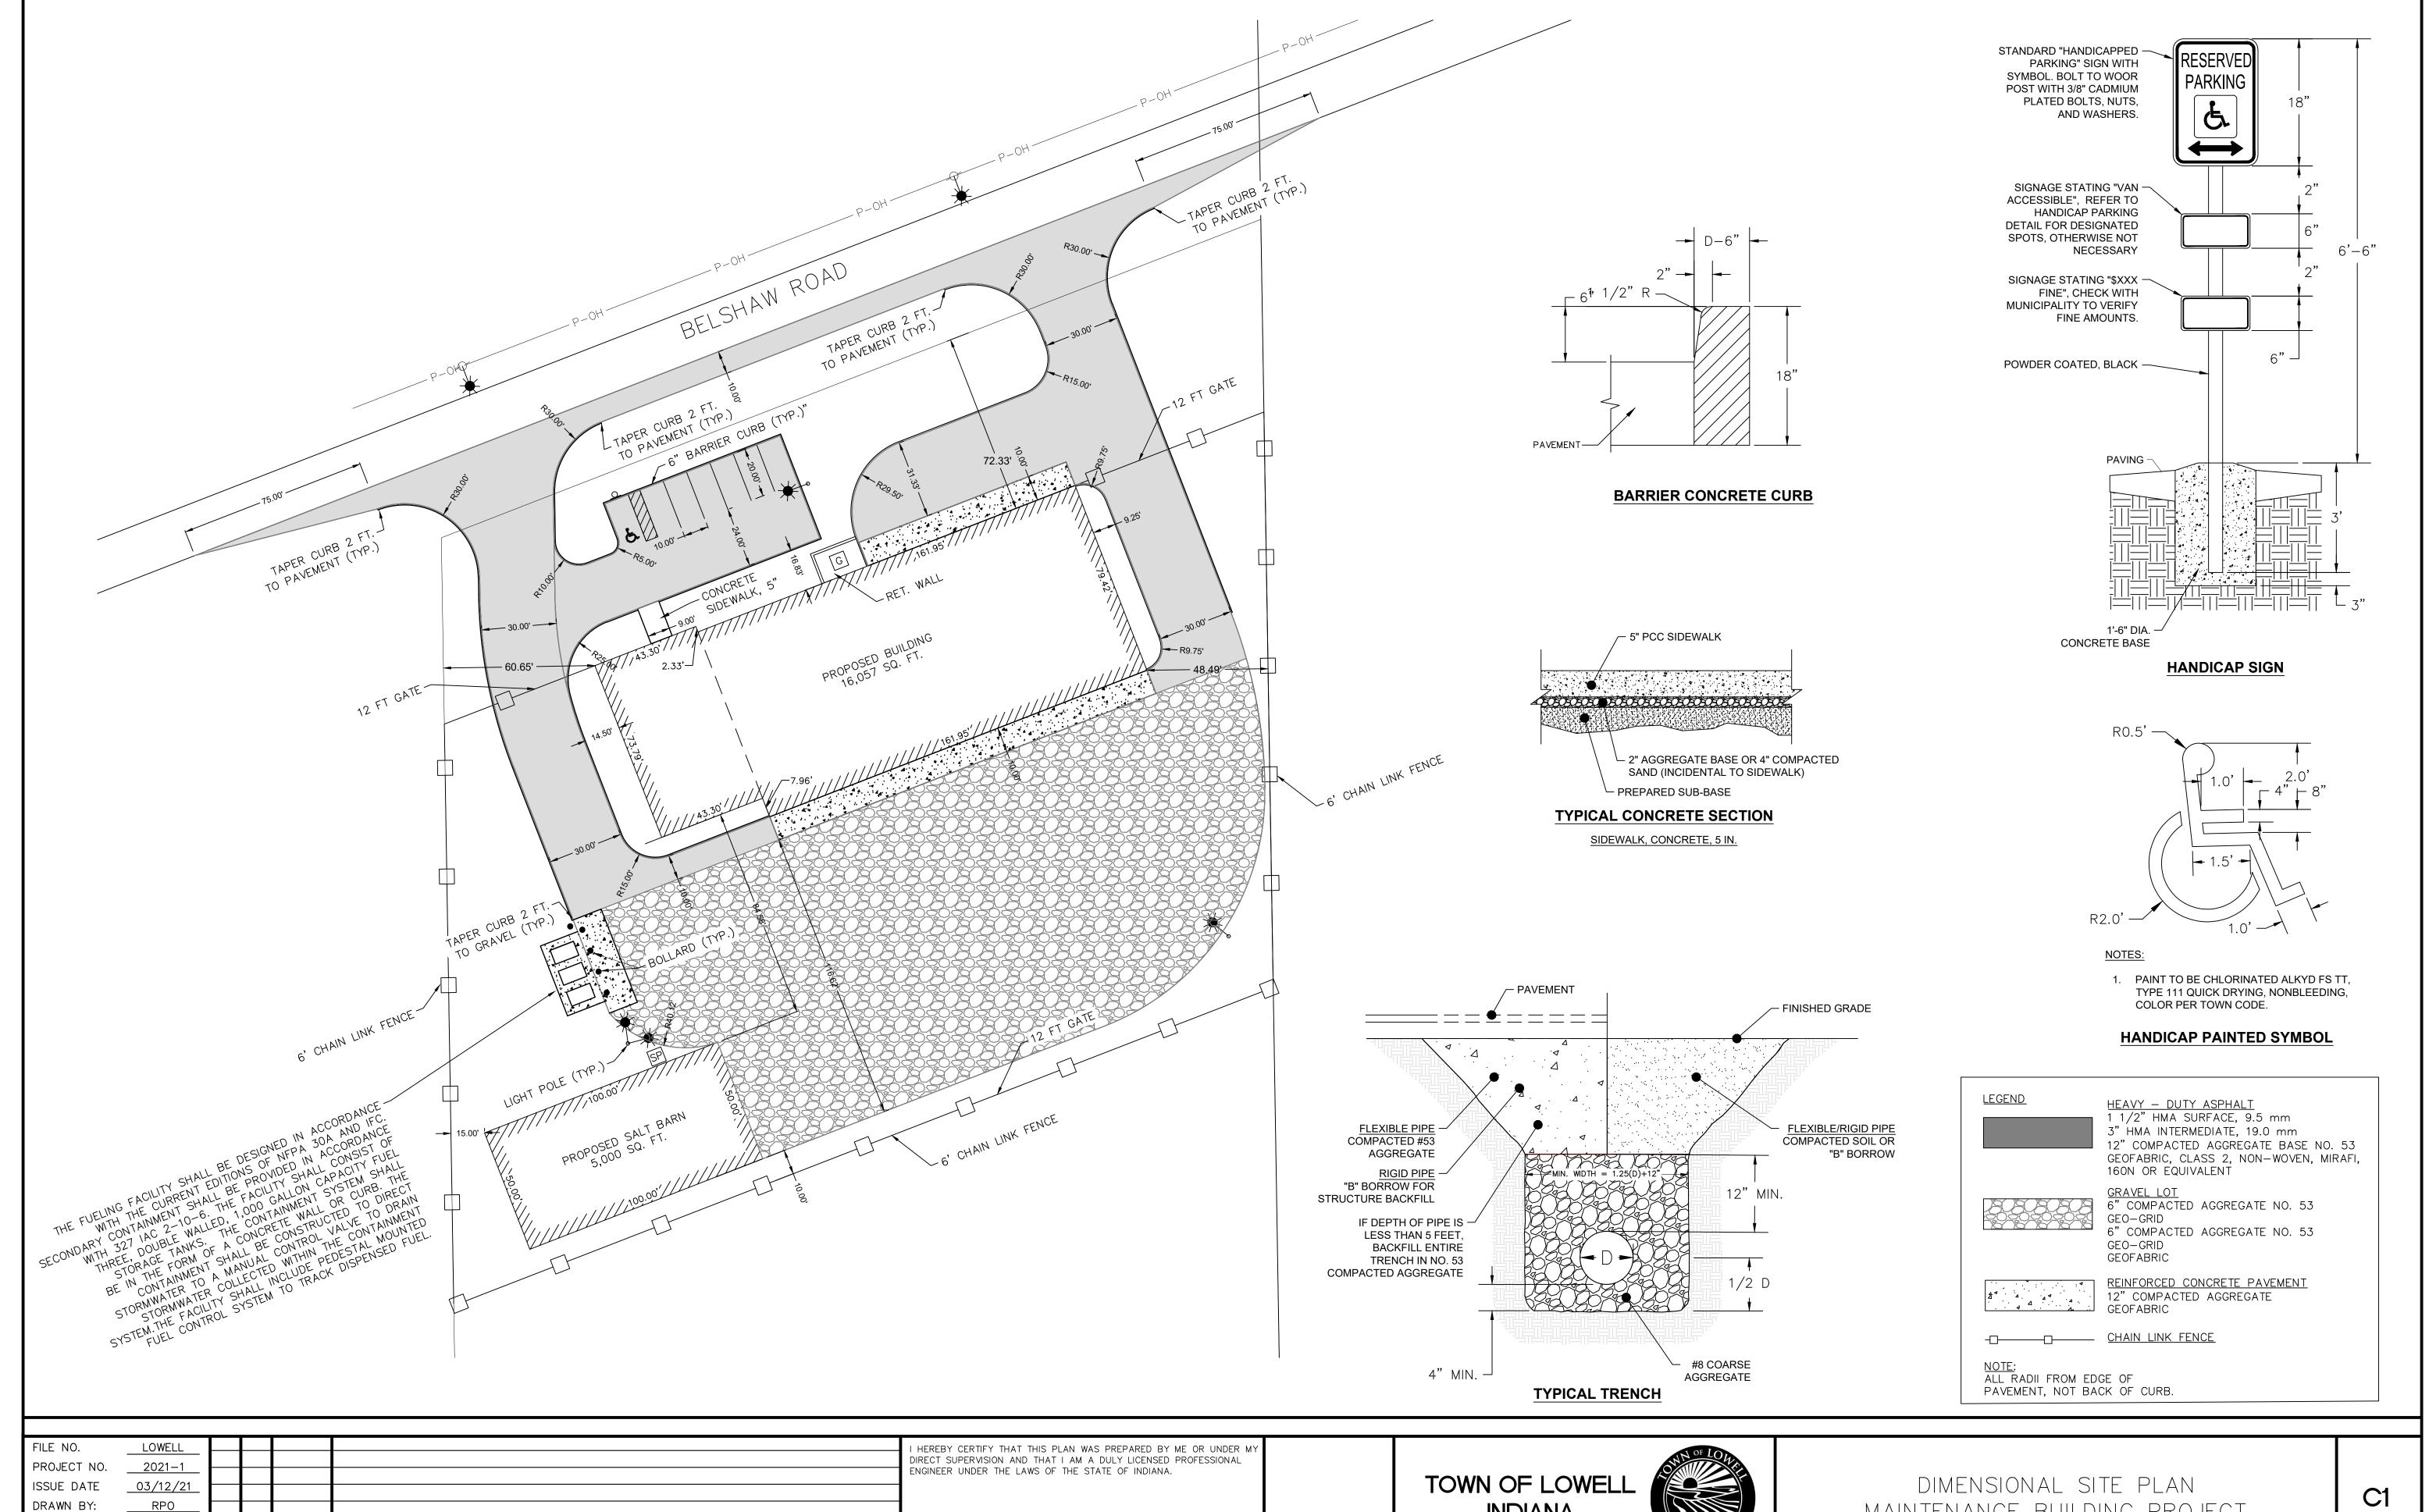

CRAIG HENDRIX, P.E.

03/12/21

___ Lic. No. P<u>E1950032</u>6

DESIGNED BY:


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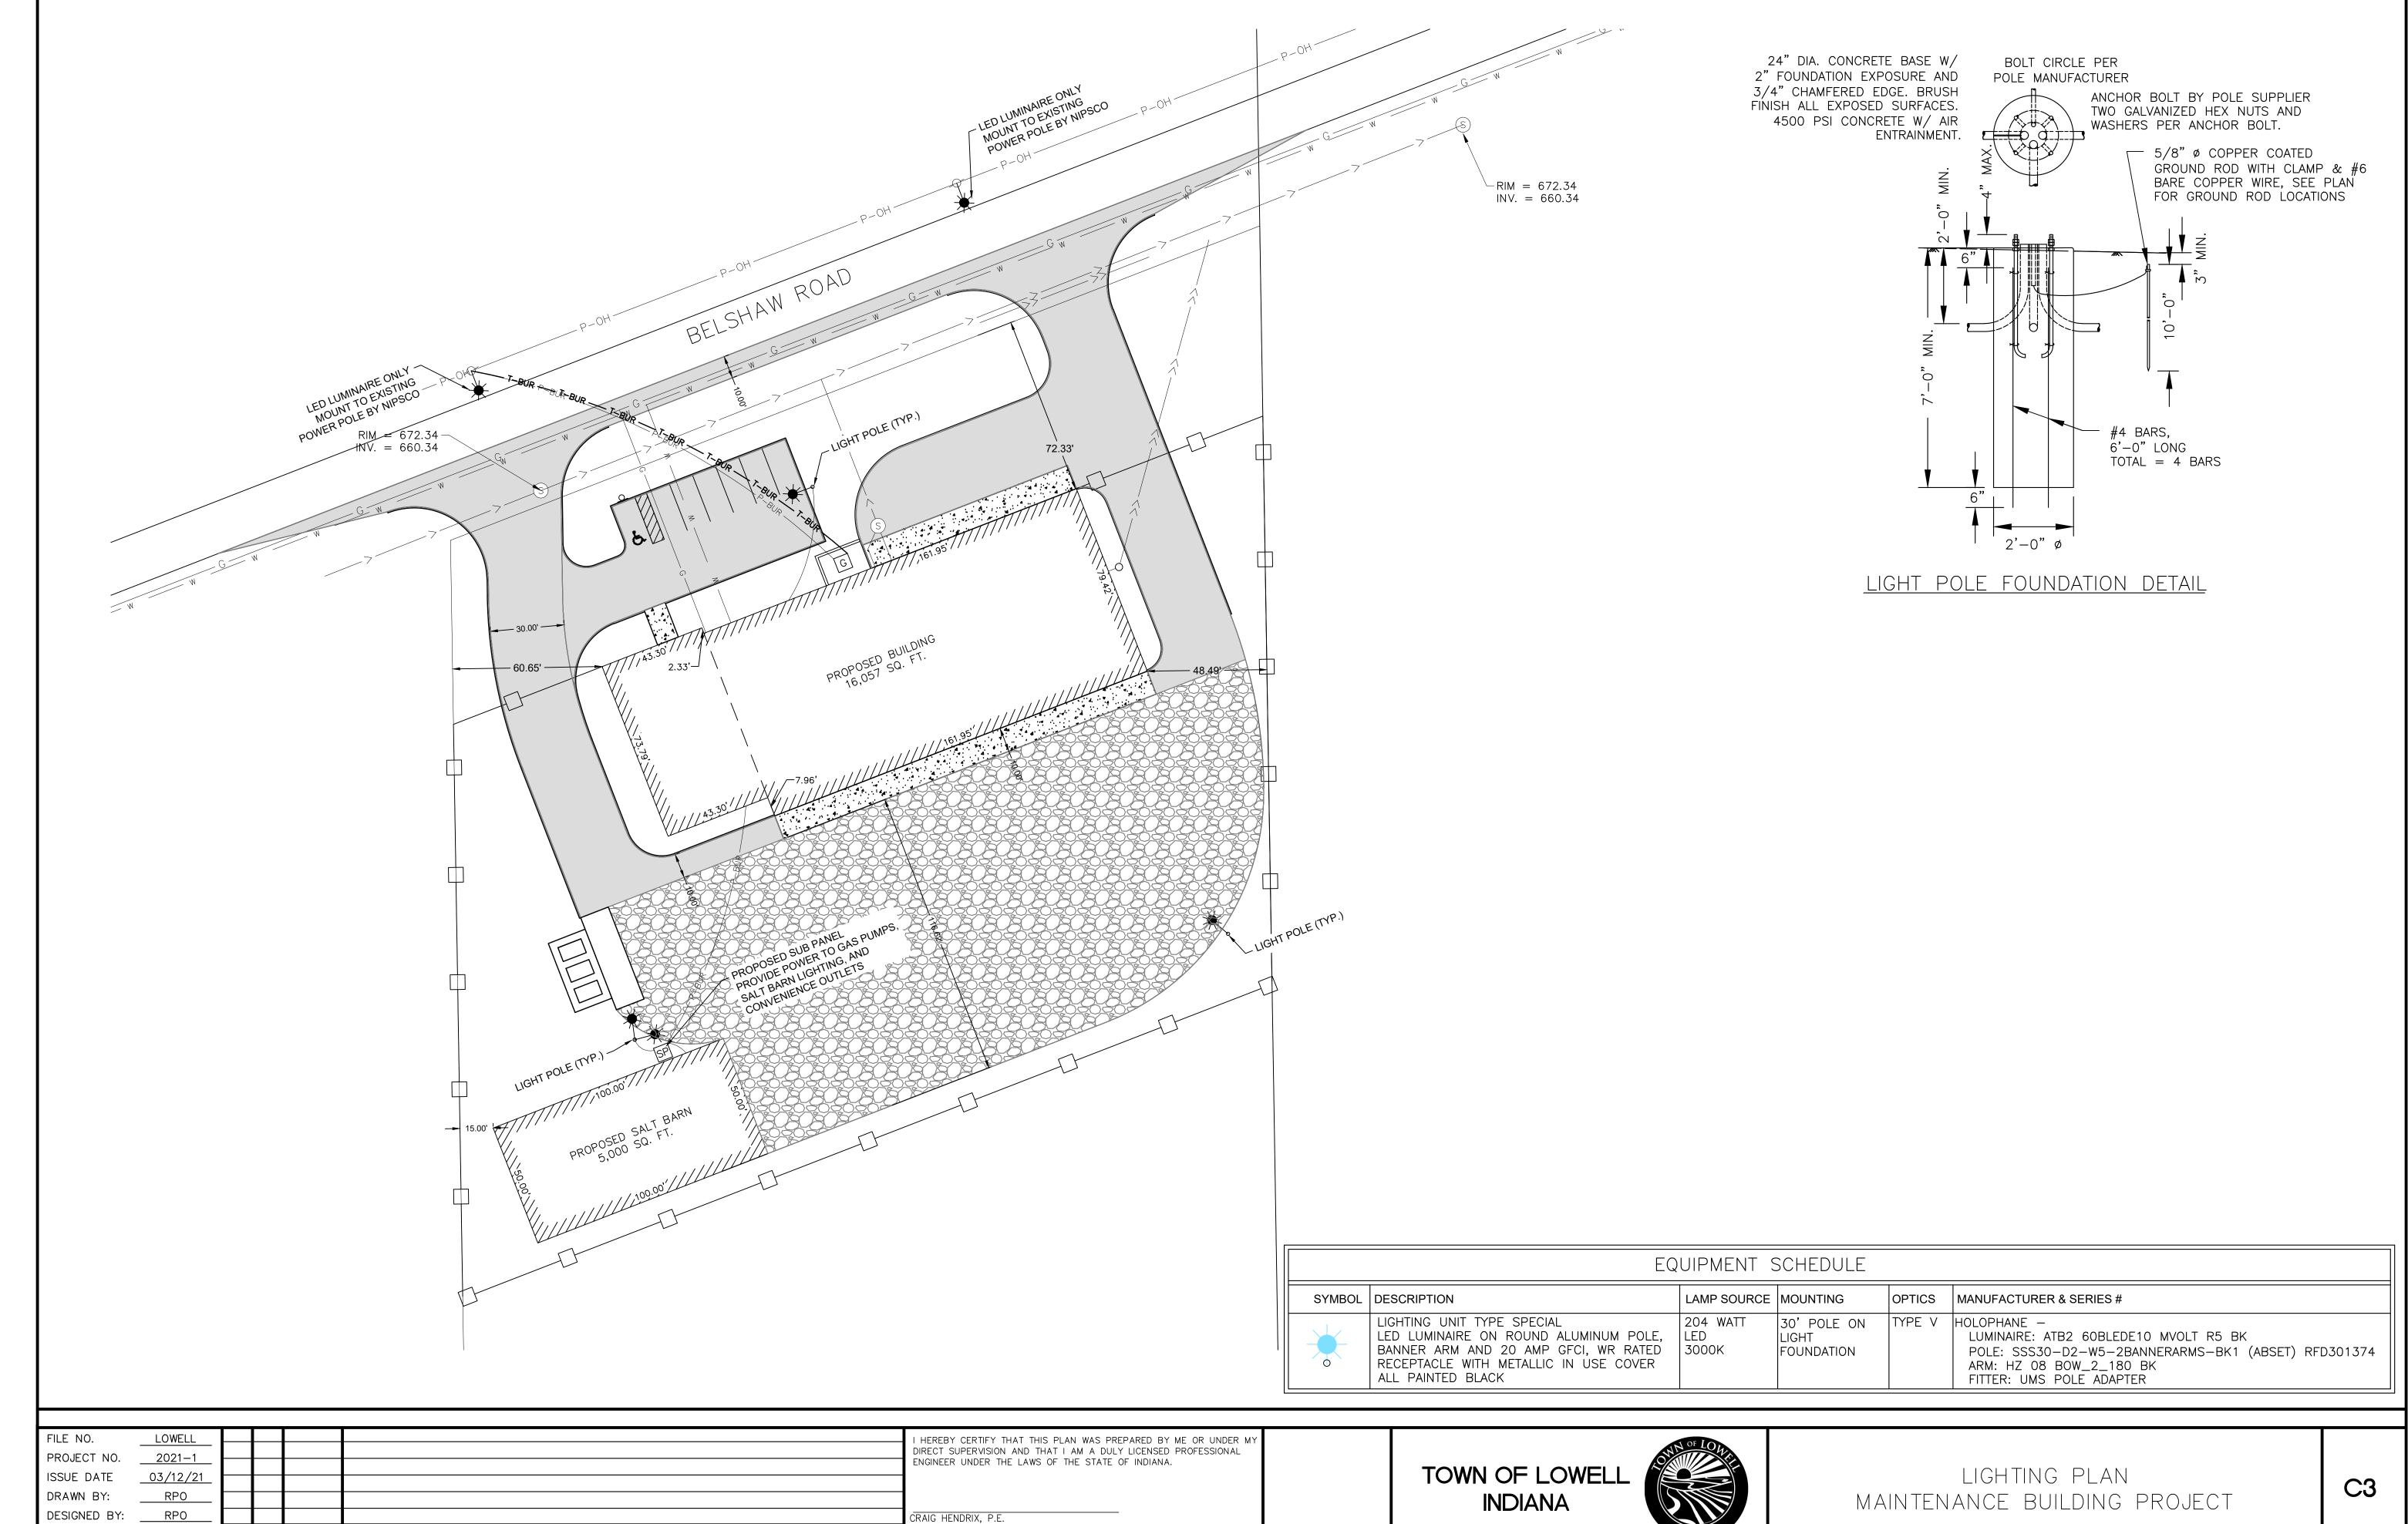
____CLH

DATE

REVISIONS

INDIANA



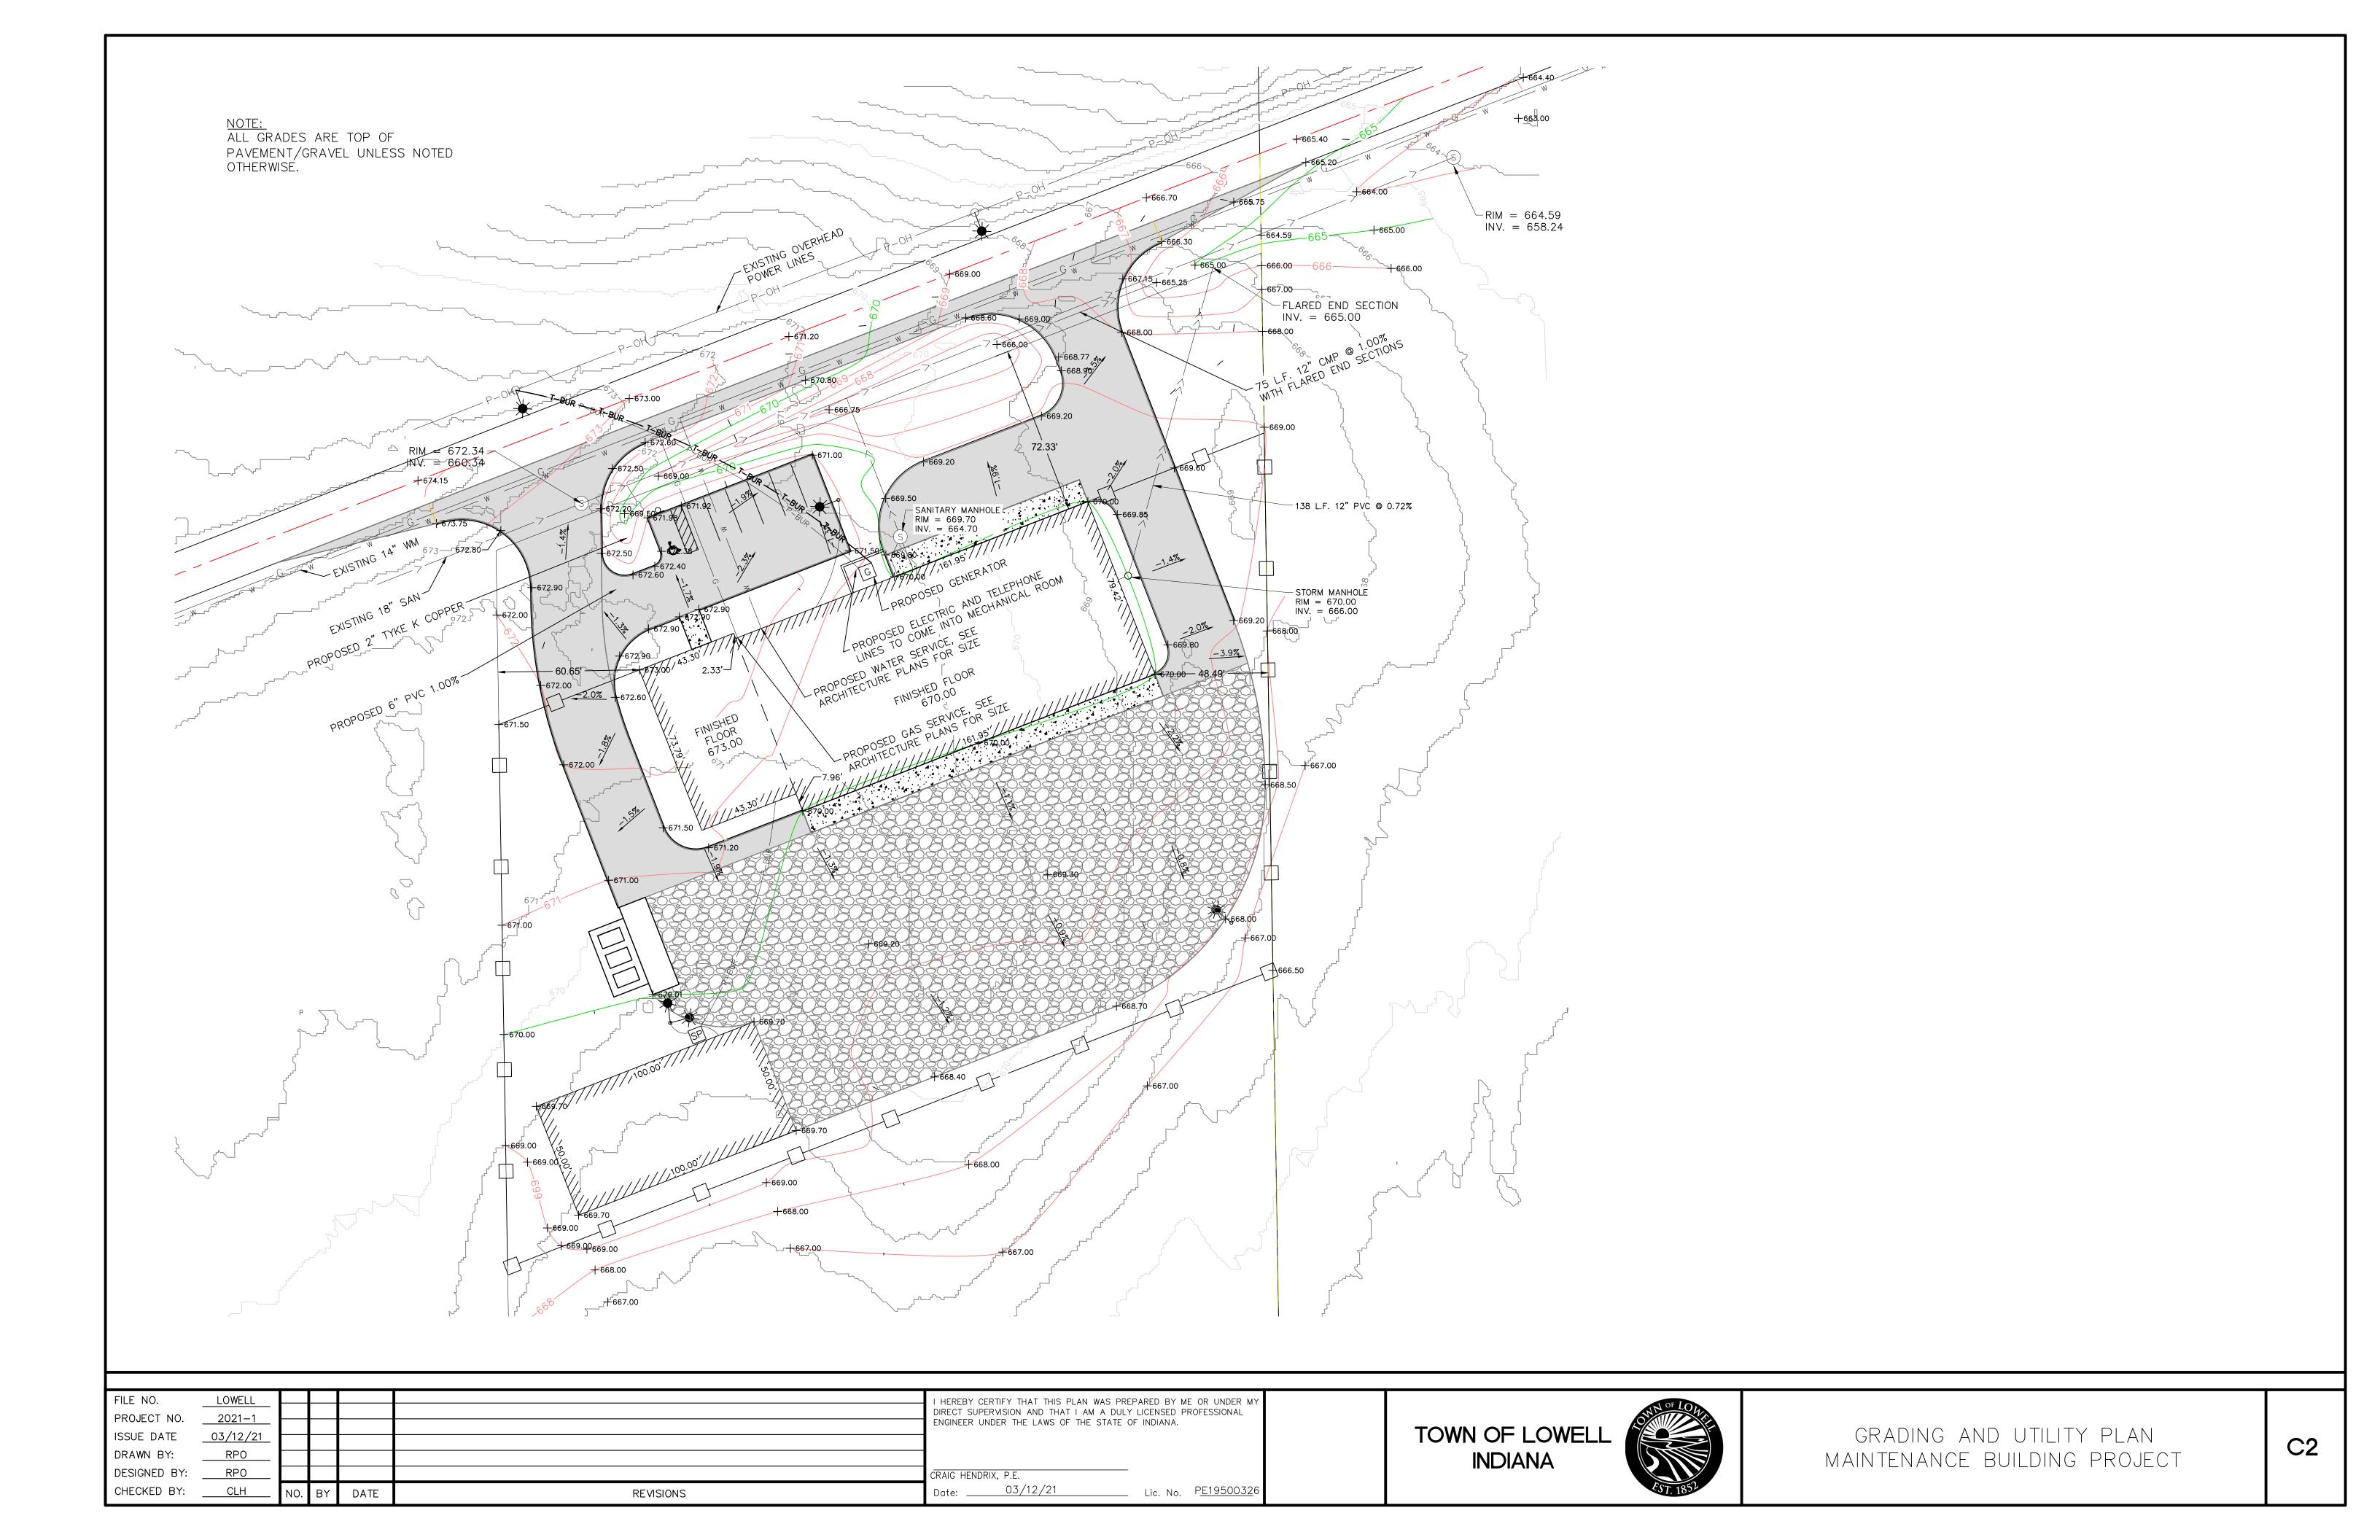

____ Lic. No. P<u>E1950032</u>6

Date: _____03/12/21

REVISIONS

____CLH

DATE

CHECKED BY:

INDIANA

FRAMING NOTES

- 1. ALL BEAMS, LINTELS OR STRUCTURAL MEMBERS TO BE NO. 2 SOUTHERN PINE (KILN DRIED) W/ "E" = 1,600,000 AND Fb = 1,300 (OR EQUAL).
- ALL FLOOR JOISTS SHALL BE 11-7/8" TJI-560 BY "TRUS-JOIST" CORP. @ 16" O.C. (UNLESS NOTED OTHERWISE) AND SHALL BE COVERED ON THE UNDERSIDE WITH A MINIMUM 5/8" TYPE X DRYWALL THROUGHHOUT. STAIR HEADERS TO BE 11-7/8" DEEP TJI (GIRDER TRUSS) AND TRIMMERS TO BE 2 1 3/4" x 11 7/8" "MICRO-LAM" (UNLESS NOTED OTHERWISE). FURNISH ONE (1) SET OF SEPIA SHOP DRAWINGS TO THE GENERAL CONTRACTOR TWO (2) WEEKS PRIOR TO FABRICATION FOR REVIEW AND COMMENT, AND SHALL BE SIGNED AND SEALED BY A REGISTERED STRUCTURAL ENGINEER LICENSED IN THE STATE OF INDIANA. ANY MATERIALS DELIVERED TO THE JOB SITE WITHOUT APPROVED SHOP DRAWINGS WILL BE REJECTED. ALSO THE TRUSS MANUFACTURER SHALL SUPPLY THE GENERAL CONTRACTOR WITH A COPY OF HIS CERTIFICATE OF INSURANCE. SEE 06190 AND 06195 FOR PRODUCT SPECIFICATIONS AND INFORMATION.
- 3. ALL WOOD LINTELS OVER DOORS AND WINDOWS SHALL BE 2 2 x 12's (UNLESS NOTED OTHERWISE).
- ALL WOOD PLATES AND SILLS BEARING DIRECTLY ON CONCRETE SHALL BE PRESSURE TREATED FOR ROT AND TERMITES.
- 5. ALL EXTERIOR CORNERS SHALL BE LET-IN METAL DIAGONAL WIND BRACING BY "SIMPSON" #CWB-126, OR 5/8" CDX PLYWOOD.
- ROOF: (LIVE LOAD = 20 P.S.F., DEAD LOAD = 10 P.S.F.)
- 7. FLOOR: (LIVE LOAD = 40 P.S.F., DEAD LOAD = 15 P.S.F.)
- 8. PARTITIONS: ASSUMED WALL LOAD = 20 lb/LF.
- 9. SNOW LOAD: 30 lb P.S.F.
- 10. ULTIMATE WIND DESIGN SPEEDS: 115 MPH
- 11. WIND EXPOSURE CATEGORY B. URBAN AND SUBURBAN AREAS, WOODED AREAS OR OTHER TERRAIN WITH NUMEROUS CLOSELY SPACED OBSTRUCTIONS HAVING THE SIZE OF SINGLE FAMILY *DWELLINGS* OR LARGER. EXPOSURE B SHALL BE ASSUMED UNLESS THE SITE MEETS THE DEFINITION OF ANOTHER TYPE OF EXPOSURE.
- 12. ROOF SHEATHING SHALL BE 5/8" DOUGLAS FIR CDX PLYWOOD W/ IDENTIFICATION INDEX NO. 32/16. ALL TYPICAL FLOORS AND WALK ON DECKS SHALL BE 3/4" CDX PLYWOOD INDEX NO. 24/48. ALL TO BE GLUED AND NAILED.
- 13. 2 x 4 TOP PLATES TO BE DOUBLED BELOW FLOOR TRUSS BEARING.

SPECIFICALLY ADDRESSED. (SECTION: R502.8.2)

- 14. ALL DOUBLE TRUSSES OR "MICRO-LAM" BEAMS BEARING ON FRAME WALLS TO BE CARRIED DOWN TO FOUNDATION ON TRIPLE STUDS GLUED AND SPIKED AS INDICATED.
- 15. REFLECTED FRAMING SHOWN ON PLAN.
- 16. EXTERIOR OR LOAD BEARING WALLS WITH PLATES CUT, DRILLED OR NOTCHED MORE THAN 50% OF THE WIDTH OF THE STUD SHALL HAVE A GALVANIZED METAL TIE 16 GAGE AND 11/2 INCHES (11/2") WIDE FASTENED TO EACH PLATE.
- 17. EXTERIOR OR LOAD BEARING WALLS WITH STUDS DRILLED WITHIN 5/8" OF THE FACE OF THE STUD SHALL BE REINFORCED WITH A STRUCTURAL STUD SHOE.
- 18. TYPE 1A-FIRECODE INTUMESCENT ACRYLIC FIRESTOP SEALANT- TO BE USED AS FIRESTOP AND DRAFTSTOP AT ALL REQUIRED LOCATIONS AS DESCRIBED IN IRC R602.8
- 19. CUTS, NOTCHES AND HOLES BORED IN TRUSSES, LAMINATED VENEER LUMBER, GLUE-LAMINATED MEMBERS OR I-JOISTS ARE NOT PERMITTED UNLESS THE EFFECTS OF SUCH ARE
- 20. MANUFACTURER'S INSTALLATION INSTRUCTIONS FOR THE PRE-ENGINEERED TJI FLOOR JOISTS SHALL BE ON THE JOBSITE AT THE TIME OF INSPECTIONS.

MASONRY NOTES

- 1. STONE AND BRICK SHALL BE AS APPROVED BY THE OWNER. ALLOW \$380/M FOR BRICK ONLY.
- CONCRETE MASONRY UNITS (CMU) SHALL BE AS INDICATED ON THE PROJECT DRAWINGS.
- ANCHORS AND TIES SHALL BE ZINC-COATED STEEL AND SHALL MEET "ASTM" A-525, CLASS G-60.
- . JOINT REINFORCING SHALL BE PREFABRICATED TRUSS-TYPE, SIMILAR TO "DUR-O-WALL" AND SHALL MEET "ASTM" A-153, CLASS B-2.
- 5. MORTAR SHALL CONSIST OF PORTLAND CEMENT, HYDRATED LIME AND SAND IN A PROPORTION OF 1:1:6 IN ACCORDANCE WITH "ASTM" C-270 FOR TYPE "N" MORTAR.
- 5. LIMESTONE SILLS AND CAPS WHERE REQUIRED SHALL BE "INDIANA" LIMESTONE, BUFF COLOR,
- 7. EXPANSION AND CONTROL JOINT FILLERS SHALL BE PRE-FORMED RUBBER. THE EXTENT AND LOCATION SHALL BE AS INDICATED ON THE PLANS.
- 8. FLASHING @ ALL MASONRY LINTEL OPENINGS AND WEEP HOLES SHALL BE OF THE TYPE AS INDICATED ON THE PROJECT DRAWINGS. WEEPS SHALL BE WICK TYPE, INSTALLED IN EXTERIOR WALLS AT TWENTY FOUR (24) INCH CENTERS (MAX) SPACING.
- PROTECT ALL MASONRY MATERIAL AGAINST MOISTURE. DO NOT USE REINFORCING OR TIES HAVING LOOSE RUST OR OTHER COATING WHICH AFFECT BONDING.
- 10. LAY UP WALLS PLUMB AND TRUE WITH COURSES LEVEL, ACCURATELY SPACED AND COORDINATED WITH OTHER WORK. ALL BOND SHALL MATCH EXISTING UNLESS INDICATED OTHERWISE. ALL HORIZONTAL JOINTS SHALL BE LEVEL AND ALL VERTICAL JOINTS SHALL BE PLUMB, WITH A TOLERANCE OF PLUS OR MINUS ONE QUARTER (1/4) INCH FOR THE HEIGHT (TOP AND BOTTOM OF THE WALL.
- 11. BRICK WORK SHALL BE REINFORCED WITH CORROSION RESISTANT TIES, SPACED AT SIXTEEN (16) INCHES VERTICAL CENTERS AND THIRTY TWO (32) INCHES HORIZONTAL CENTERS.
- 12. EXPOSED JOINTS SHALL BE TOOLED AND BRUSHED.

VARIEGATED STONE SHALL NOT BE PERMITTED.

- 13. CLEAN ALL MASONRY WORK INCLUDED IN THIS SECTION. PROTECT ADJOINING WORK FROM DAMAGE FROM ALL CLEANING OPERATIONS.
- 14. GROUT ALL VOIDS AT JAMBS, HEADERS, FOUNDATIONS AND SILLS. POINT JOINTS AS NECESSARY INCLUDING POCKETS AND VOIDS.
- 15. PROTECT ALL WORK FROM FREEZING.
- 16. SET STEEL LINTELS AND MISC. STEEL IN MASONRY AS INDICATED ON PLANS. PROVIDE 4" MIN. BEARING @ EACH END OF BEARING.

GENERAL CONCRETE NOTES

- 1. WHERE AND WHEN CALLED FOR ALL CLEAN GRANULAR FILL MATERIAL SHALL BE COMPACTED TO A MINIMUM OF 95% OF "ASTM" D-1557-70 (MINIMUM PROCTOR DENSITY).
- 2. EXCAVATIONS DEEPER THAN THE ELEVATION OF FOOTING MUST BE CLEARED THROUGH THE ENGINEERING OFFICE.
- 3. WALL FOOTINGS TO HAVE 6" PROTECTIONS FROM EACH FACE OF WALL AND BE 1'-0" DEEP (UNLESS NOTED OTHERWISE).
- 4. CONTRACTOR SHALL PROTECT FOUNDATION AGAINST LATERAL DISPLACEMENT, HEAT OR FREEZING CONDITIONS.
- 5. PROVIDE 2-#5 BARS (TOP AND BOTTOM) CONTINUOUS IN CONCRETE WALL UNLESS NOTED OTHERWISE. LAP AND TIE BARS 3'-0" AT SPLICES AND PROVIDE 4'-0" LONG CORNER BARS (UNLESS NOTED OTHERWISE).
- 6. ALL REINFORCED CONCRETE WORK SHALL BE IN ACCORDANCE WITH THE LATEST EDITION OF "BUILDING CODE REQUIREMENTS FOR REINFORCED CONCRETE" AS PUBLISHED BY "THE AMERICAN CONCRETE INSTITUTE" (A.C.I. STANDARD 318-83).
- 7. ALL CONCRETE TO HAVE A MINIMUM ULTIMATE STRENGTH OF 3000 P.S.I. AT THE END OF 28 DAYS UNLESS NOTED OTHERWISE).
- 8. ALL REINFORCING STEEL SHALL CONFORM TO "ASTM" A-615, GRADE 60 SPEC. FOR NEW BILLET STEEL.
- 9. ALL WELDED WIRE MESH SHALL BE LAPPED (2) TWO FULL MESH PANELS AND TIED
- SECURELY. WELDED WIRE MESH SHALL CONFORM TO "ASTM" A-185 SPEC.

 10. CONCRETE COVER SHALL BE 1" TOP AND BOTTOM FOR SLABS; 1-1/2" FOR BEAMS, COLUMNS AND WALLS; 3" FOR FOOTINGS, MATS AND GRADE BEAMSALL CONSTRUCTION JOINTS SHALL BE THOROUGHLY CLEANED OF LAITANCE WITH A WIRE BRUSH AND
- 11. POUR ALL SLABS-ON-GRADE IN CHECKERBOARD FASHION BETWEEN.CONSTRUCTION JOINTS IN AREAS NOT TO EXCEED 600 SQ. FT. WITH A MINIMUM OF 24 HOURS BETWEEN

WATER IMMEDIATELY PRIOR TO POURING OF SUBSEQUENT OR NEW CONCRETE.

- 12. NO CALCIUM CHLORIDE SHALL BE USED IN ANY CONCRETE OR MORTAR.
- 13. ALL STRUCTURAL STEEL SHALL CONFORM TO "ASTM" A-36 SPEC. (UNLESS NOTED OTHERWISE).
- 14. SPADE OR VIBRATE CONCRETE FOUNDATIONS AS NECESSARY TO AVOID HONEYCOMBING
- 15. INSTALL ALL THRU-WALL SLEEVES OR CHASES AS REQUIRED BY THE ELEC./PLUMBING/OR HVAC CONTRACTOR, LOCATE AS DIRECTED.
- 16. CONCRETE CONTRACTOR TO SUBMIT ALTERNATIVE PRICE FOR REPLACING DAMAGED SECTIONS OF PUBLIC SIDEWALK
- 17. KEYNOTE SHOWN BY:

ADJACENT POURS.

- 4" CONCRETE SLAB ON GRADE WITH ONE LAYER WWF 66-1010 AT 1-12" CLEAR @ TOP.
- SEE DETAILS FOR BRICK LEDGE REINFORCEMENT.
 DEPRESS TOP OF WALL 8" AT ENTRY (UNLESS NOTED OTHERWISE)- SEE
- ARCHITECTURAL FOR LOCATION.
- 4. 5" CONCRETE SLAB ON GRADE WITH ONE LAYER WWF 66-1010 AT 1-1/2" CLEAR @ TOP. (GARAGE)
- 5. ALL SECTIONS OF DRIVEWAY INCLUDING THE APRON SECTIONS OF THE DRIVE (FROM THE SIDEWALK TO THE HOUSE) TO BE CONSTRUCTED OF:

 A. A MINIMUM 4" COMPACTED GRADE C.A. 6 STONE BASE, WITH 6"

 CONCRETE;
- B. AN 8" COMPACTED GRADE C.A. 6 STONE BASE, WITH 2" CLASS I
 BITUMINOUS SURFACE. NO WIRE MESH ALLOWED UNDER PUBLIC WALK
 & PARKWAY. MESH REQUIRED ON PRIVATE SECTIONS OR ENTIRE POUR
- TO BE FIBER MESH. NO PEA GRAVEL ALLOWED

 PRIVATE SIDEWALKS ARE TO BE 4" THICK WITH A MINIMUM OF 4" GRADE CA-6
 STONE BASE. PUBLIC SIDEWALKS ARE TO BE 5" THICK WITH A MINIMUM OF 4"
- GRADE CA-6 STONE BASE.

 7. BRICK PAVER PATIO TO BE CONSTRUCTED OF A MINIMUM 4" COMPACTED GRADE C.A. 6 STONE BASE AND 1-1½" SAND. A CONCRETE BASE IN LIEU OF THE MINIMUM OF CA-6 STONE IS ACCEPTABLE.

NOTE CONCRETE

CONCRETE CONTRACTOR SHALL COORDINATE ALL CHASES AND SLEEVES IN FOUNDATION WALLS WITH PLUMBING AND HEATING CONTRACTORS.


PLUMBING CONTRACTOR TO VERIFY SIZE AND LOCATION OF ALL SLEEVES AND CHASES NECESSARY TO INSTALL A COMPLETE SYSTEM AS REQUIRED PER THE PROJECT DRAWINGS. THE PLUMBING CONTRACTOR SHALL COORDINATE ANY CHANGES OR ADDITIONAL INFORMATION WITH THE CONCRETE AND GENERAL CONTRACTORS PRIOR TO ANY POURING OF FOOTINGS AND FOUNDATIONS. THE PLUMBING CONTRACTOR SHALL BE RESPONSIBLE FOR SEALING OFF AND MAKING WATERTIGHT ALL PENETRATIONS MADE BELOW GRADE.


SYMBOLS LIST

GENERAL NOTES

- 1. INCLUDED AS PART OF THESE DOCUMENTS IS THE "GENERAL CONDITIONS FOR CONSTRUCTION", AIA DOCUMENT A-201, ARTICLE 1 THROUGH 14 INCLUSIVE.
- 2. THESE DRAWINGS INDICATE THE GENERAL SCOPE OF THE PROJECT IN TERMS OF THE ARCHITECTURAL DESIGN CONCEPT, DIMENSIONS, MAJOR ELEMENTS AND MATERIALS. THESE DRAWINGS DO NOT NECESSARILY INDICATE OR DESCRIBE ALL WORK REQUIRED FOR THE FULL COMPLETION OF THE PROJECT.
- 3. THE GENERAL CONTRACTOR AND HIS SUBCONTRACTORS SHALL FURNISH ALL OF THOSE ITEMS AND LABOR REQUIRED FOR THE FULL COMPLETION OF THIS PROJECT IN A FIRST CLASS WORKMANSHIP LIKE MANNER.
- 4. ALL INTERIOR BEARING WALLS AND SHAFTS SHALL BE (1) ONE HOUR RATED CONSTRUCTION USING 5/8" TYPE-X U.L. RATED DRY WALL (BOTH SIDES)
- . THIS CONTRACTOR SHALL INSTALL SMOKE DETECTORS AS REQUIRED BY THE CITY OF LOWELL CODE
- 6. INTERIOR FINISHES SHALL NOT EXCEED CLASS 1, 0-25 FLAME SPREAD, 200 SMOKE.
- 7. INSULATION MATERIALS, INCLUDING FACINGS, SUCH AS VAPOR RETARDERS AND VAPOR-PERMEABLE MEMBRANES INSTALLED WITHIN FLOOR-CEILING ASSEMBLIES, ROOF-CEILING ASSEMBLIES, WALL ASSEMBLIES, CRAWL SPACES AND ATTICS SHALL HAVE A FLAME SPREAD INDEX NOT TO EXCEED 25 WITH AN ACCOMPANYING SMOKE-DEVELOPED INDEX NOT TO EXCEED 450 WHERE TESTED IN ACCORDANCE WITH ASTM E 84 OR UL 723.
- THE CONTRACTOR SHALL BE HELD RESPONSIBLE FOR FIELD VERIFICATION OF ALL DIMENSIONS AND CONDITIONS BEFORE EXECUTION OF ANY WORK AND SHALL REPORT ANY DISCREPANCIES TO THE ARCHITECT IN WRITING.
- THE CONTRACTOR SHALL BE HELD RESPONSIBLE FOR THE ADHERENCE TO COMPLY WITH ALL APPLICABLE CITY, STATE, AND NATIONAL CODES AND ORDINANCES.
- 10. THE CONTRACTOR SHALL VERIFY ALL PARTITION LAYOUTS WITH THE ARCHITECT BEFORE PROCEEDING WITH ANY FRAMING.
- 1. THE CONTRACTOR SHALL BE RESPONSIBLE FOR THE COORDINATION OF ALL INCOMING UTILITIES.
- WRITTEN DIMENSIONS HOLD PREFERENCE OVER SCALED DIMENSIONS. DO NOT SCALE DRAWINGS.
- A. THE GENERAL CONTRACTOR AND SUBCONTRACTORS SHALL:
- COMPLY WITH ALL LOCAL, STATE AND NATIONAL CODES AND ORDINANCES.
- B. PERFORM ALL WORK IN A FIRST CLASS WORKMANSHIP LIKE MANNER AND IN NO WAY DAMAGE OR WEAKEN THE STRUCTURAL STRENGTH OF THE BUILDING.
- C. REMAIN RESPONSIBLE FOR COMPLIANCE WITH THE PROVISIONS OF THE OCCUPATIONAL SAFETY AND HEALTH ACT, (OSHA) LATEST ADDITION.
- D. ALL WORK SHALL BE GUARANTEED FOR ONE YEAR AFTER SUBMITTAL OF COMPLETION OF WORK.
- E. MAINTAIN THROUGHOUT THE CONSTRUCTION PERIOD, A CERTIFICATE OF INSURANCE FOR ALL LIABILITIES, WITH A HOLD
- HARMLESS CLAUSE, PROTECTING THE OWNER AND ARCHITECT.

 13. THE GENERAL CONTRACTOR'S SUBCONTRACTORS SHALL COMPLETELY HOOKUP AND CONNECT ALL EQUIPMENT AND FURNISH ALL NECESSARY APPENDAGES.
- 14. ALL WINDOW GLASS, MIRRORS, FLOORS AND WALL TILE SHALL BE CLEANED AND WASHED UPON COMPLETION OF THE PROJECT BY THE GENERAL CONTRACTOR.
- THE PREMISES SHALL BE KEPT IN A BROOM SWEPT FINISH CONDITION DURING ALL PHASES OF THE CONSTRUCTION. (ALL CONTRACTORS AND SUBCONTRACTORS SHALL BE RESPONSIBLE FOR CLEANING UP AND DISPOSING OF THEIR LITTER AND LEFT OVER MATERIALS ON A REGULAR BASIS AND LEAVE THE PROJECT IN A BROOM SWEPT FINISH CONDITION UPON COMPLETION OF THEIR PORTION OF THIS PROJECT).
- 16. THE ENTIRE INSTALLATION SHALL BE PERFORMED IN FIRST CLASS WORKMANSHIP LIKE MANNER. THE COMPLETED SYSTEMS SHALL BE FULLY OPERATIONAL. ACCEPTANCE BY THE OWNER SHALL BE A CONDITION OF THE CONTRACT.
- 17. ALL WORK SHALL BE COORDINATED WITH ALL OTHER TRADES IN ORDER TO AVOID INTERFERENCE, PRESERVE MAXIMUM HEAD ROOM AND AVOID OMISSIONS.
- 3. ALL WORK PERFORMED MUST COMPLY WITH THE CITY OF LOWELL BUILDING CODE.
- THE EXCAVATOR SHALL REMOVE ALL EXCESS MATERIAL DOWN TO 6" (SIX INCHES) BELOW FINISH GRADE, INCLUDING PARKWAYS.
- THE ELECTRICAL CONTRACTOR SHALL PROVIDE AND INSTALL ONE (1) 4 x 4 WOOD POST WITH A TEMPORARY METER HEAD AND TWO (2) 110 V. AND ONE (1) 220 V.OUTLET TO BE USED BY ALL OTHER TRADES DURING THE COURSE OF CONSTRUCTION OR UNTIL EACH UNIT IS ELECTRIFIED AND SHALL BE BILLED TO THE GENERAL CONTRACTOR.
- 21. THE GENERAL CONTRACTOR TO PROVIDE TEMPORARY FENCING AND BARRICADES AROUND THE ENTIRE SITE TO BE PROTECTED AND AT ANY INTERIOR FLOOR OPENINGS THAT MIGHT CAUSE A HAZARD TO ALL.
- 2. APPROVED PLANS SHALL BE ON SITE FOR ALL INSPECTIONS.
- ALL CONTRACTORS AND THEIR REPRESENTATIVES WORKING ON THIS PROJECT SHALL AT ALL TIMES PRIOR AND DURING THE COURSE OF THEIR ACTIVITY BE RESPONSIBLE FOR THE SAFETY OF THEIR EMPLOYEES, AS WELL AS OTHERS AND IN THE CARE OF THE PROPERTY. EACH AS REPRESENTATIVES OF THEIR EMPLOYEES SHALL ASCERTAIN THAT THE CONDITIONS UNDER WHICH THEY WILL BE REQUIRED TO ACCOMPLISH THEIR WORK ARE SAFE WITHIN GOOD SAFETY PRACTICES AND MEET ALL CONCERNED REGULATIONS OF THE OCCUPATIONAL SAFETY AND HAZARD ACT OR OTHER GOVERNING REGULATIONS. THE BEGINNING OF WORK BY A CONTRACTOR SHALL INDICATE SATISFACTION CONCERNING SAFETY AND FULL RESPONSIBILITY FOR ACCIDENTS OR DAMAGE. IF UNSATISFIED, THE CONTRACTOR SHALL INDICATE WHAT SO EVER ACTION OR DEVICES NECESSARY TO RENDER SAFETY CONDITIONS FOR LIFE AND PROPERTY AS ARE RELATED TO HIS ACTIVITY. IF THE WORK OF OTHER PARTIES OUTSIDE OF THEIR ORGANIZATION IS UPON INSPECTION FOUND AT ANY TIME TO BE UNSAFE, HE SHALL STOP WORK IMMEDIATELY AND NOTIFY THE GENERAL CONTRACTOR, ARCHITECT AND OWNER. THE BEGINNING OF WORK SHALL INDICATE SATISFACTION. ACCEPTANCE OF A CONTRACT SHALL INDICATE ACCEPTANCE OF THESE REQUIREMENTS.
- THE ARCHITECT ASSUMES NO RESPONSIBILITY FOR CONSTRUCTION OTHER THAN SHOWN ON THESE DRAWINGS.
- THIS SET OF PLANS IS PROTECTED UNDER UNITED STATES GOVERNMENT COPYRIGHT LAWS AND MAY NOT BE REPRODUCED, REPRINTED OR COPIED IN ANY MANNER, EXCEPT BY APPROVAL OF ARCHITECT IN WRITING. ANY PERSON OR FIRM KNOWINGLY REPRODUCING, REPRINTING, OR PHOTOCOYPING ANY OF THIS WORK WILL BE SUBJECT TO LAWSUITS AND SUCH PENALTIES AS THE LAW ALLOWS.
- 26. THESE DRAWINGS WERE PREPARED UNDER MY DIRECTION AND ARE CORRECT TO THE BEST OF MY KNOWLEDGE IN ACCORDANCE WITH THE BUILDING LAWS OF CITY OF LOWELL.

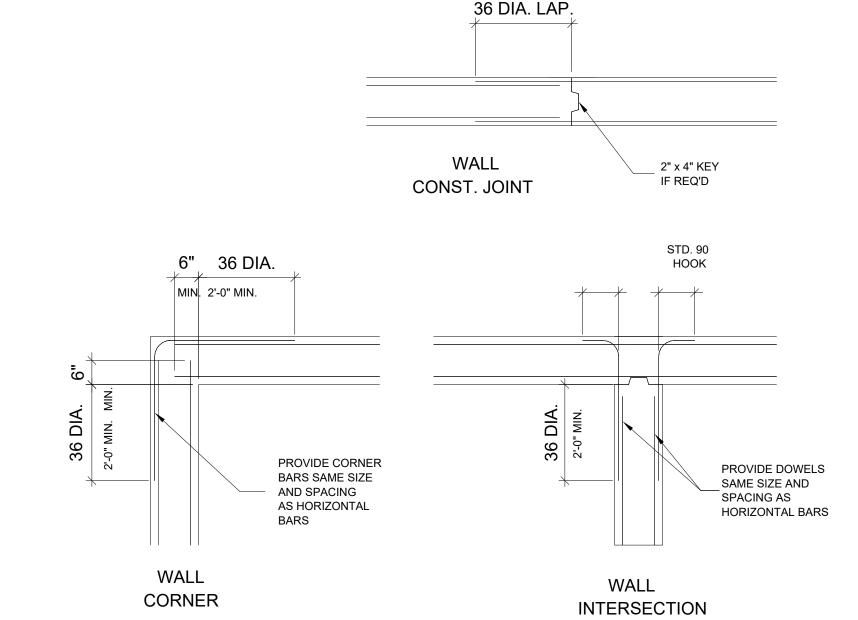

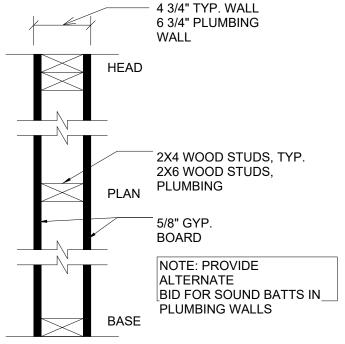

PROVIDE NATE OF SOUND BATTS IN BING WALLS

FULL BUILDING SECTION

PARTIAL BUILDING SECTION

A-1

A-1

EXTERIOR BUILDING ELEVATION


PARTITION TAG

A

A

NORTH ARROW

TYPICAL FOUNDATION WALL DETAILS
VERTICAL REINFORCING NOT SHOWN

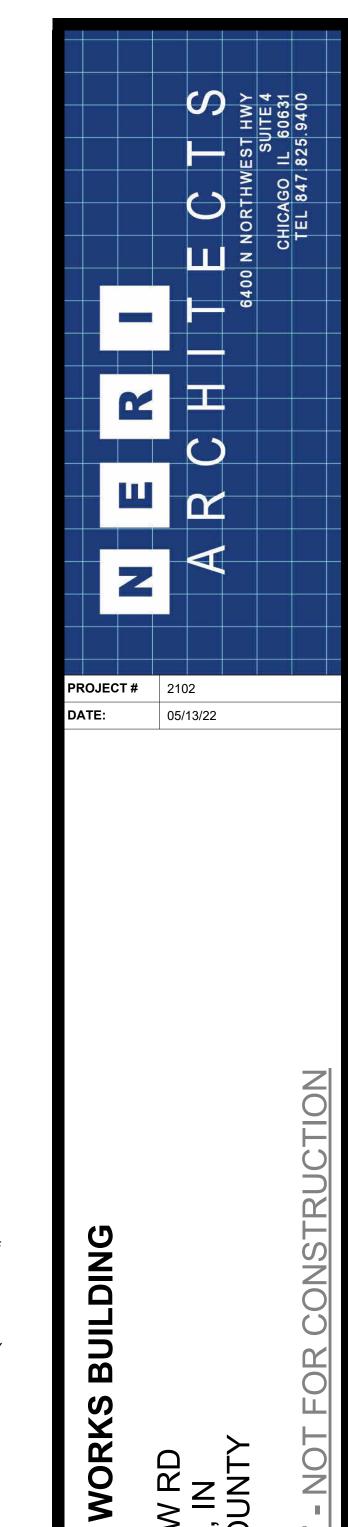

UBLIC

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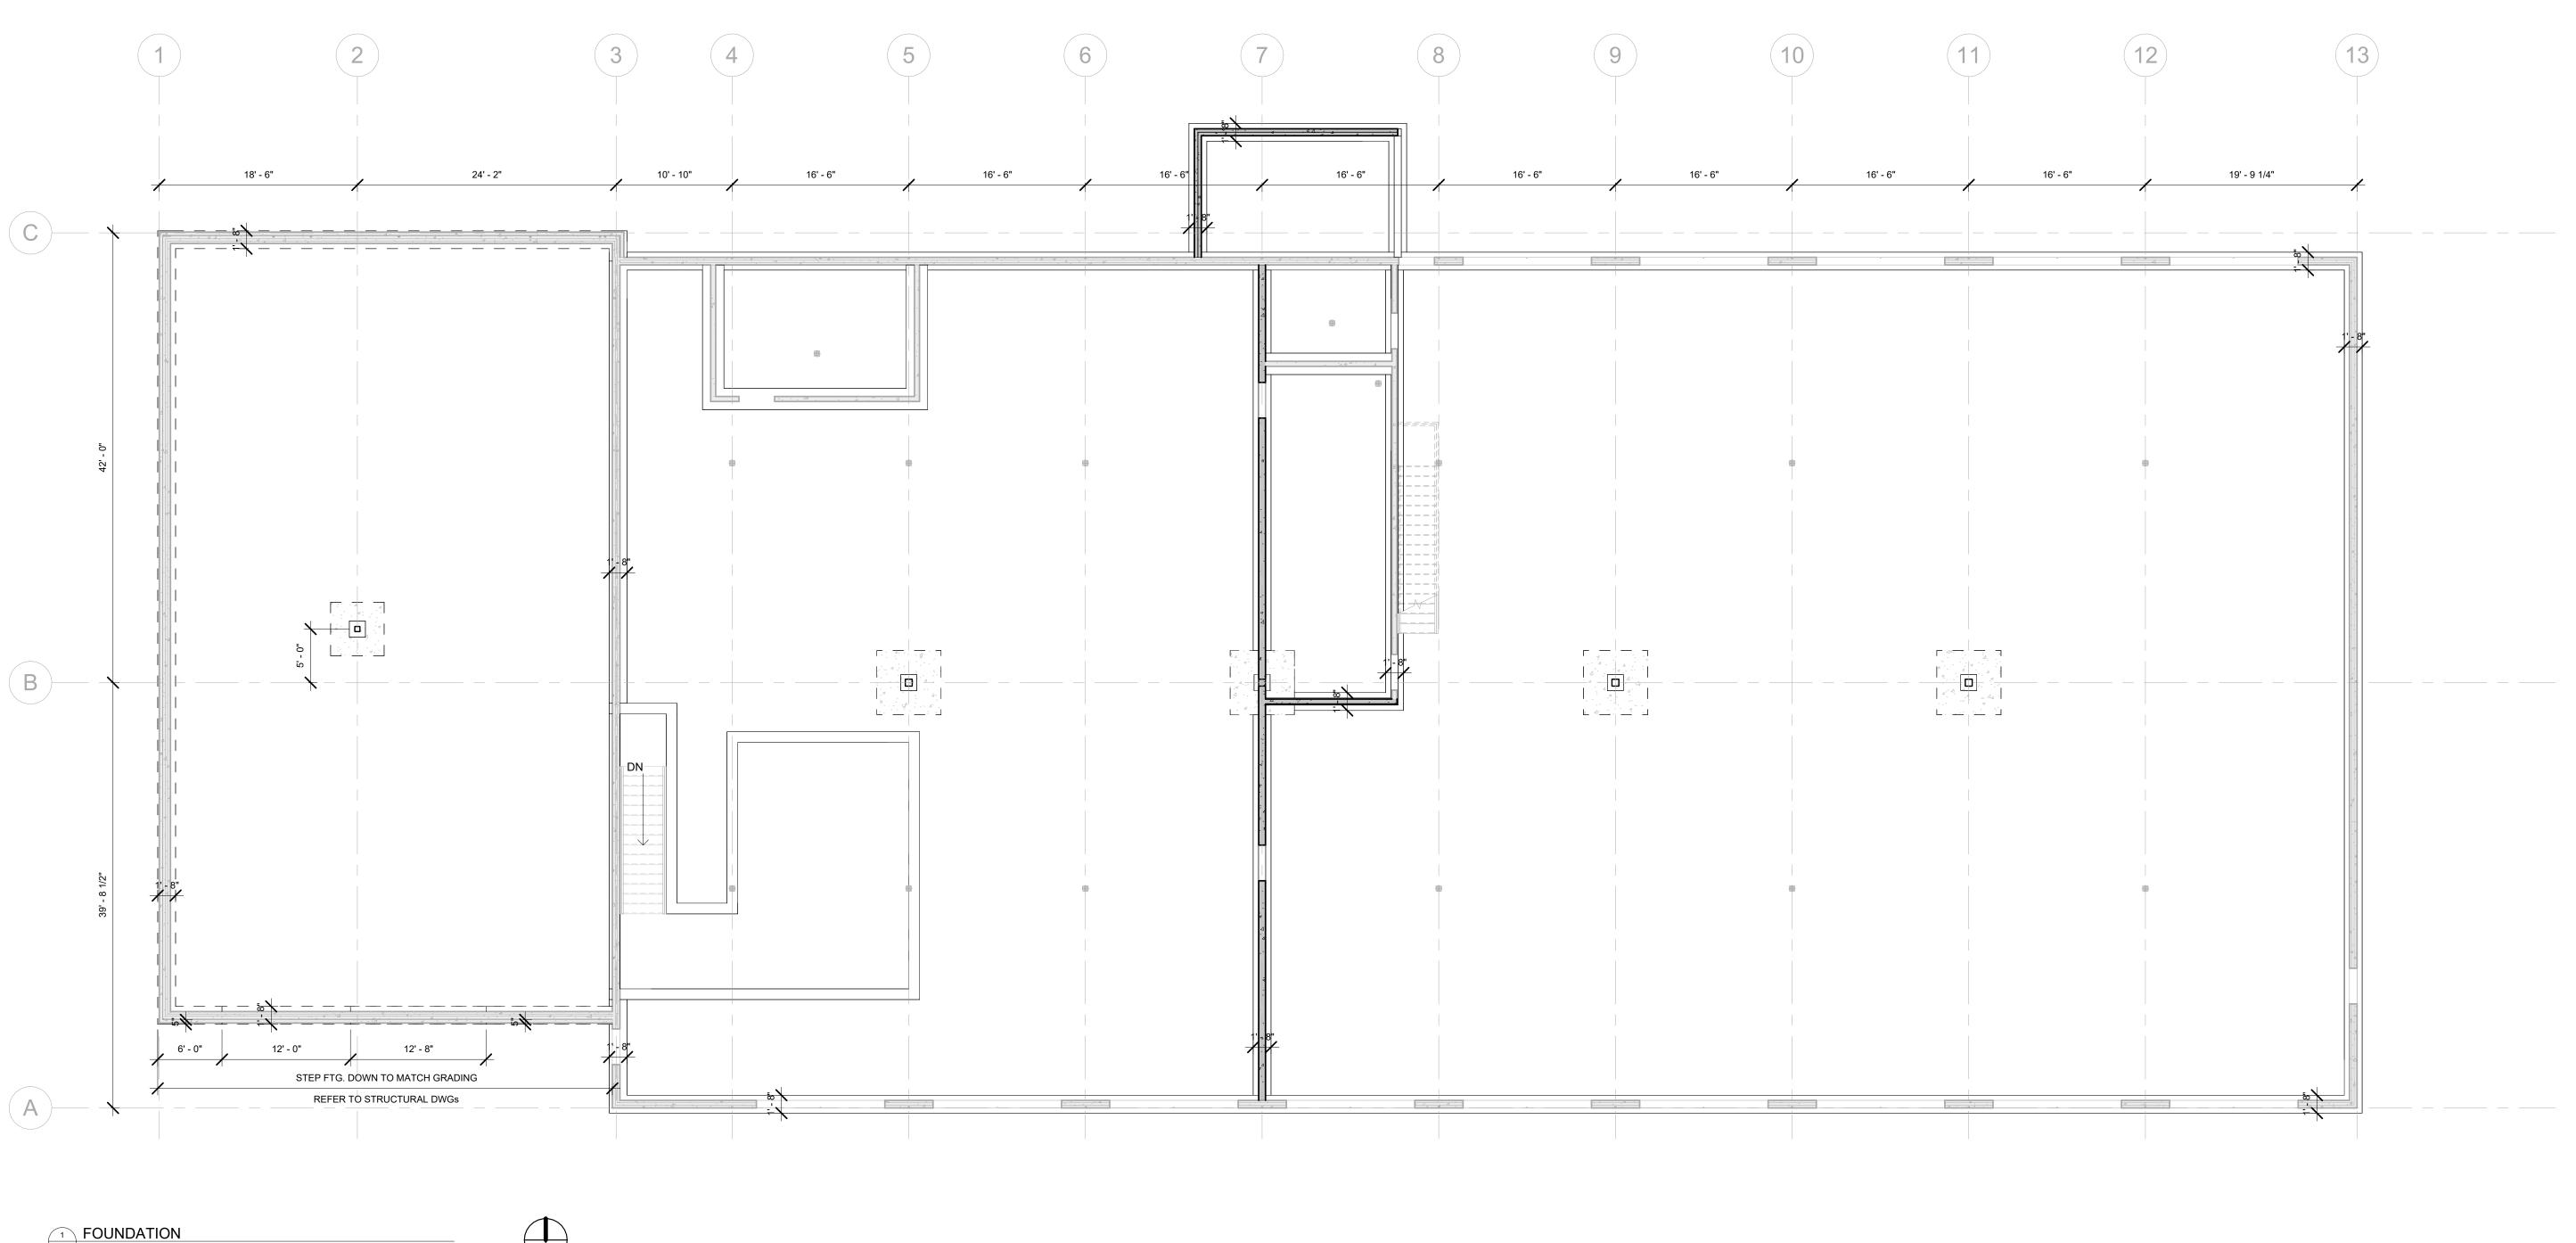
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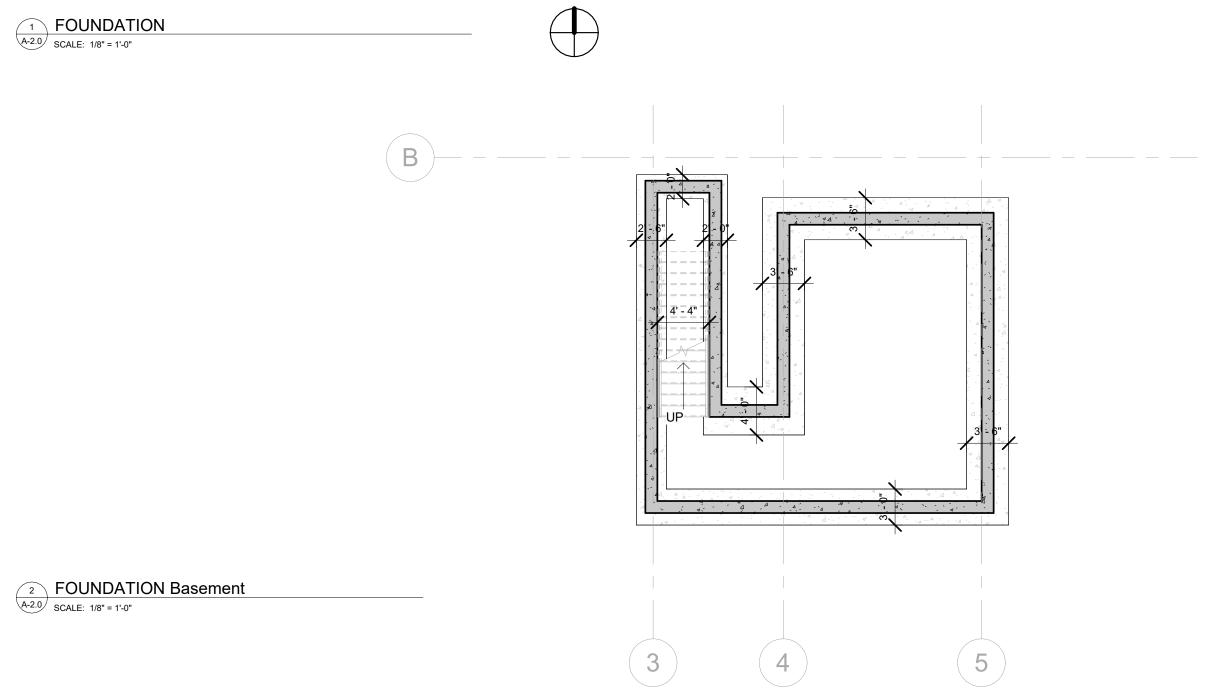
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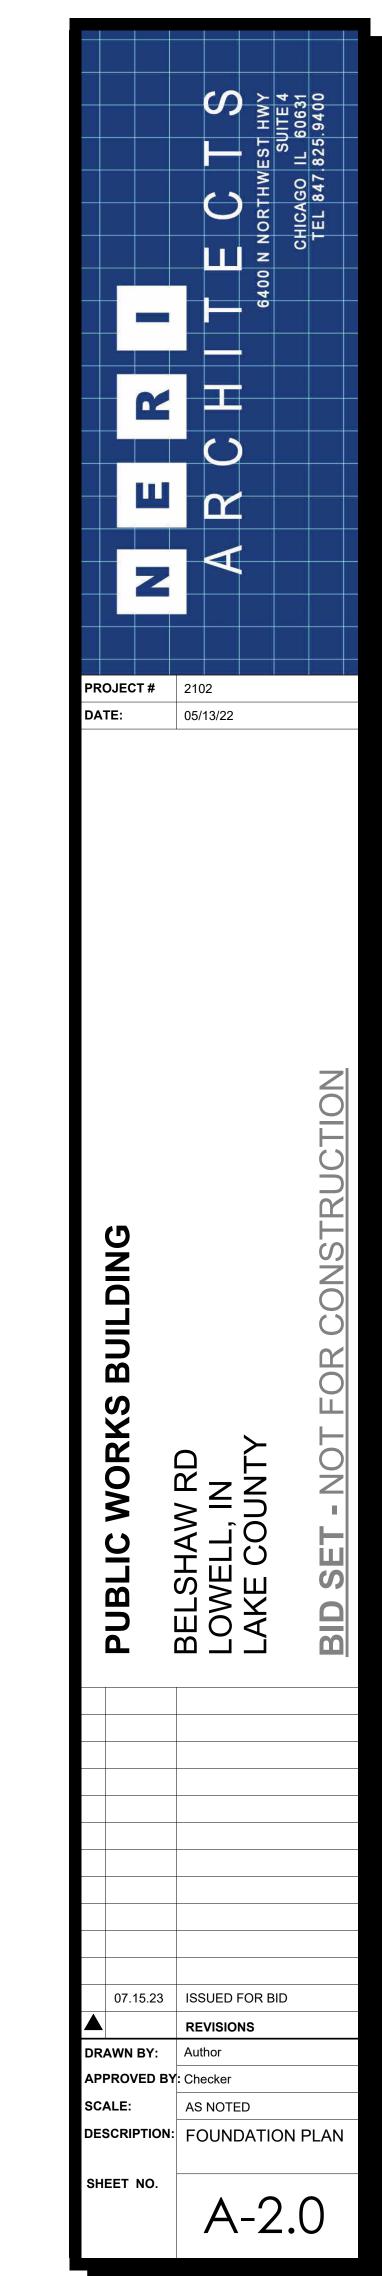
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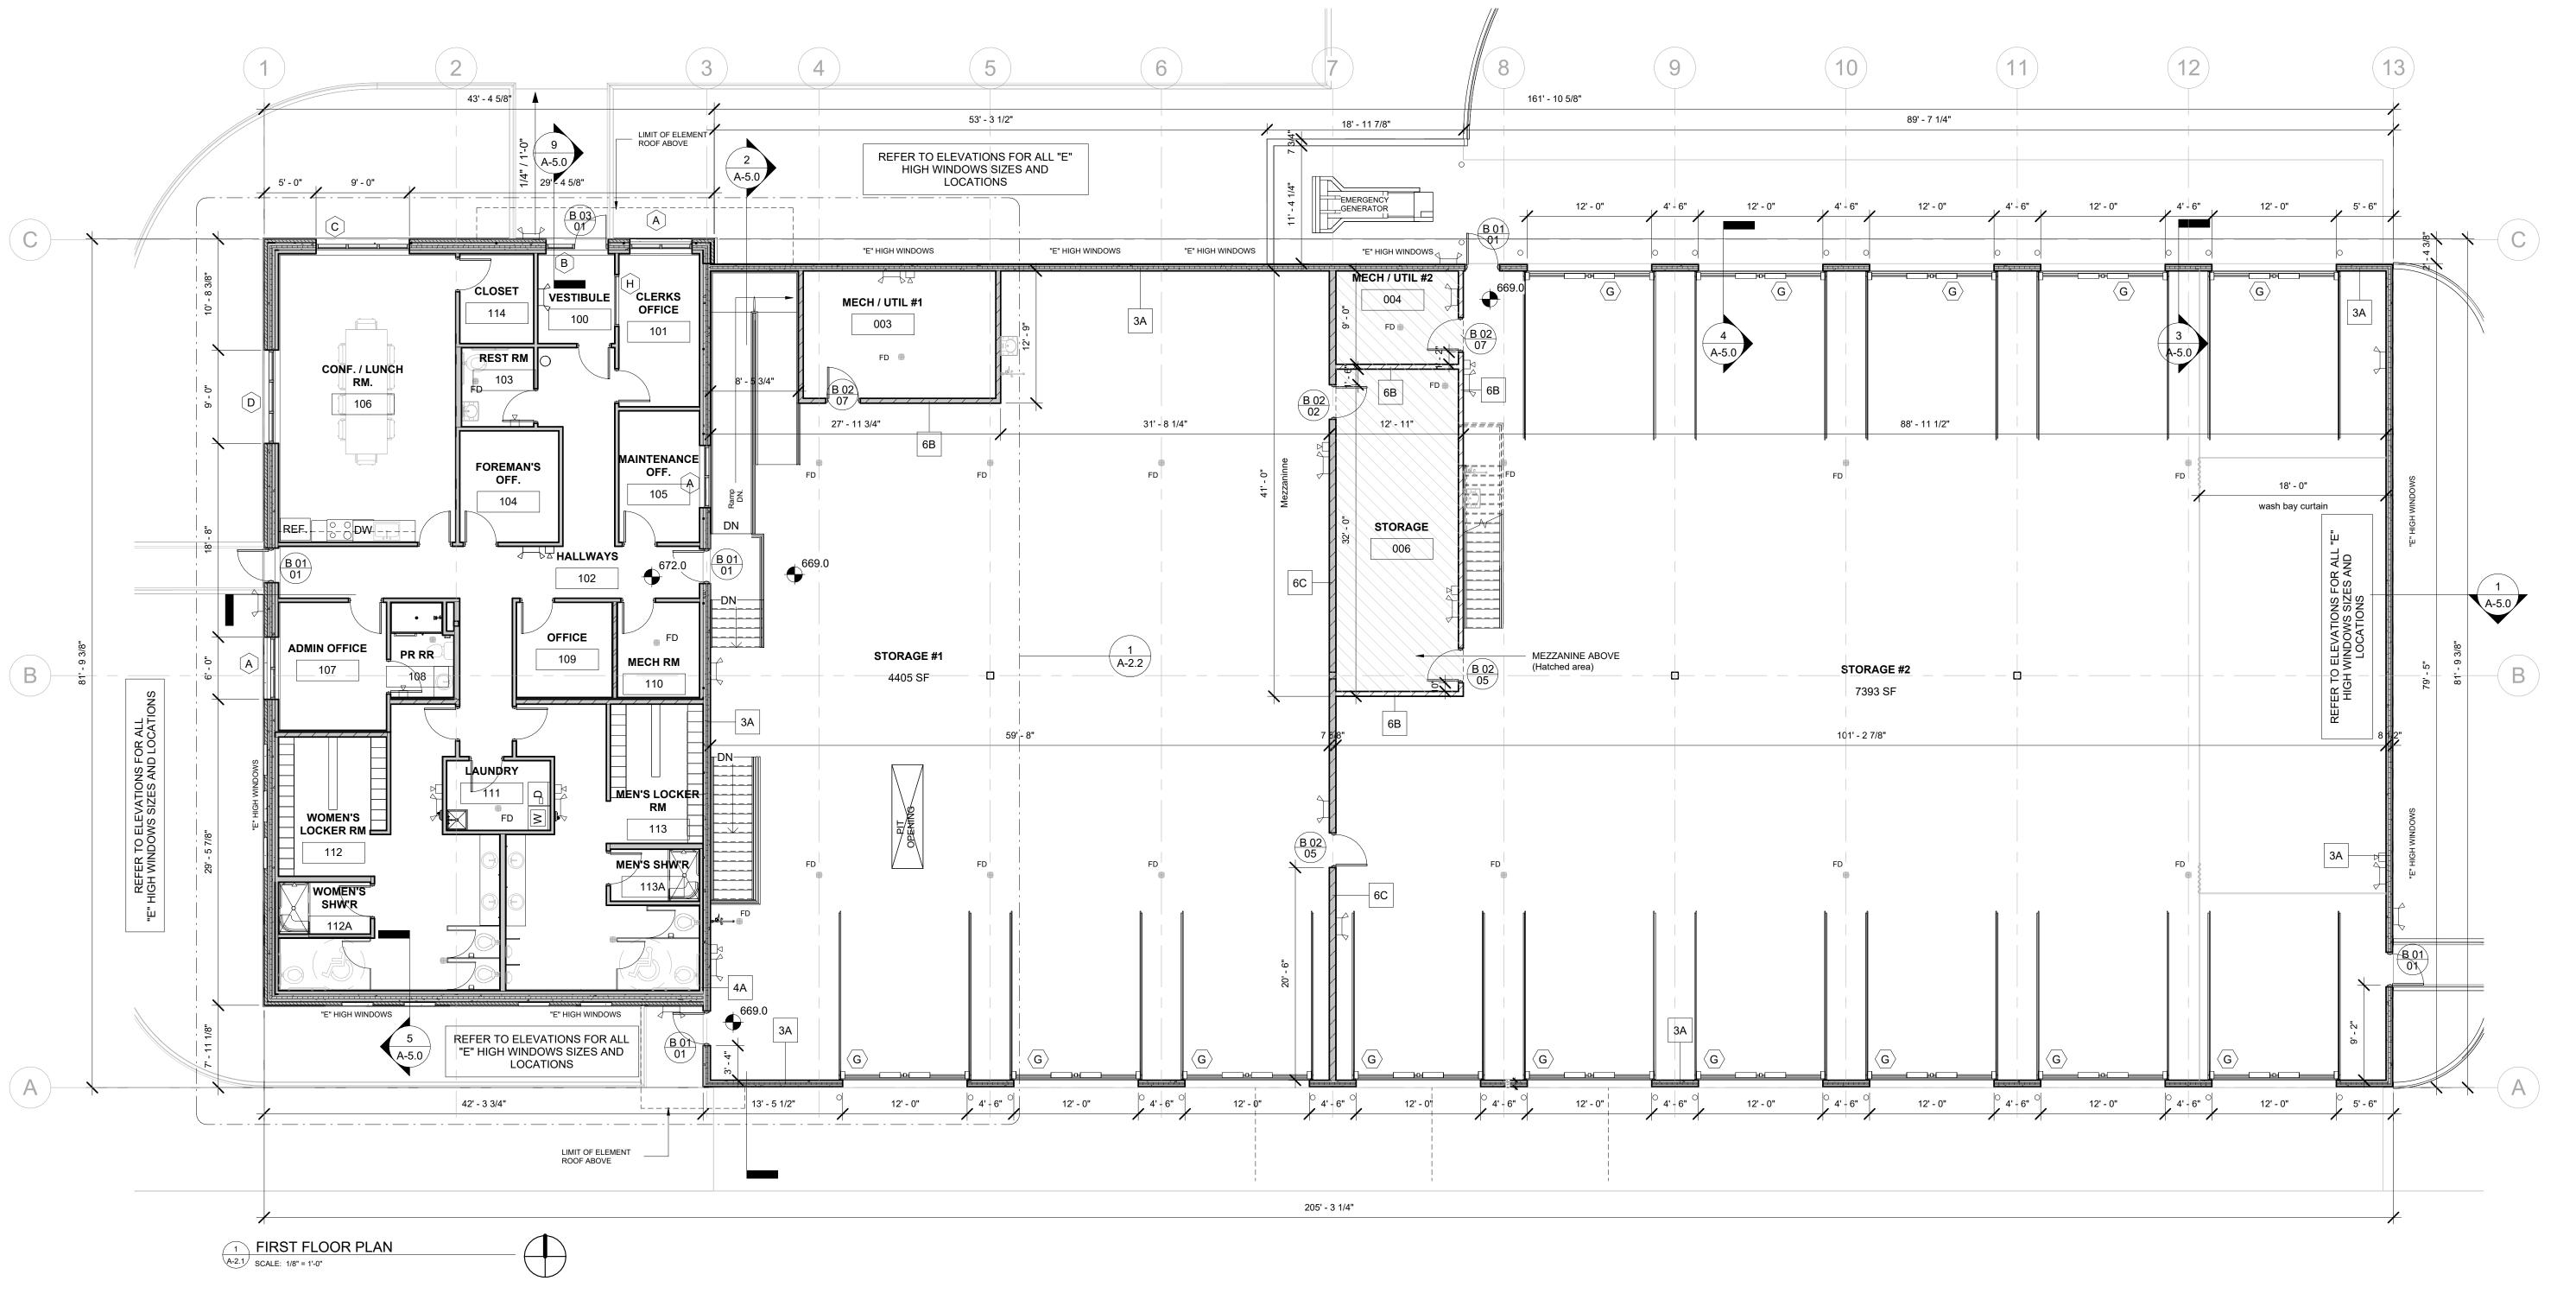
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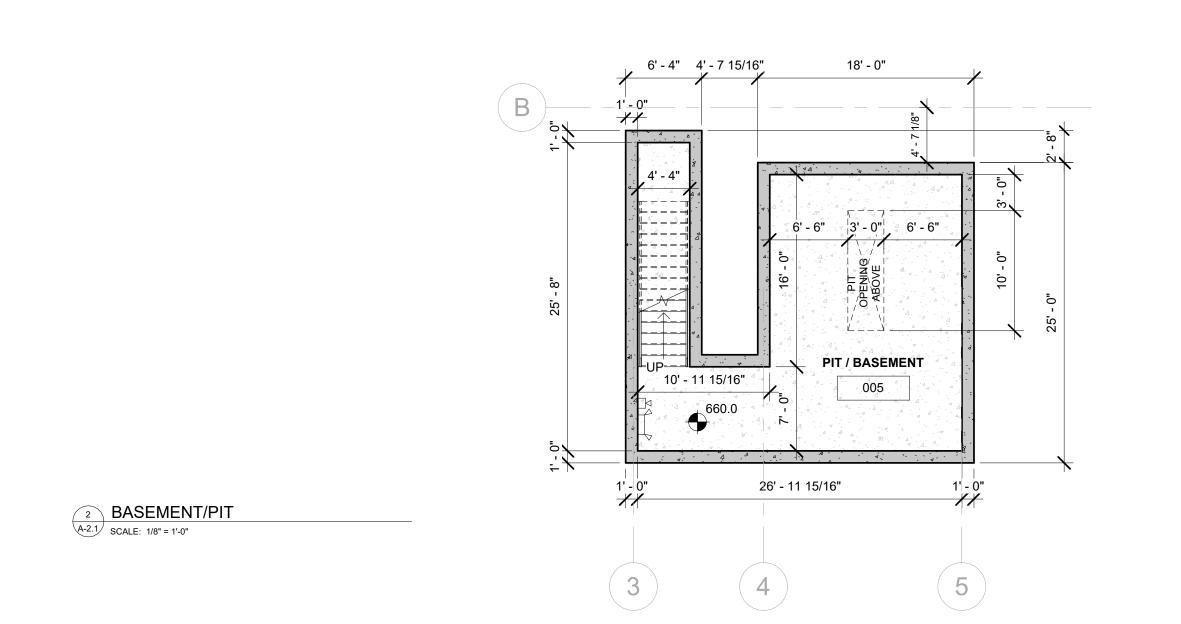
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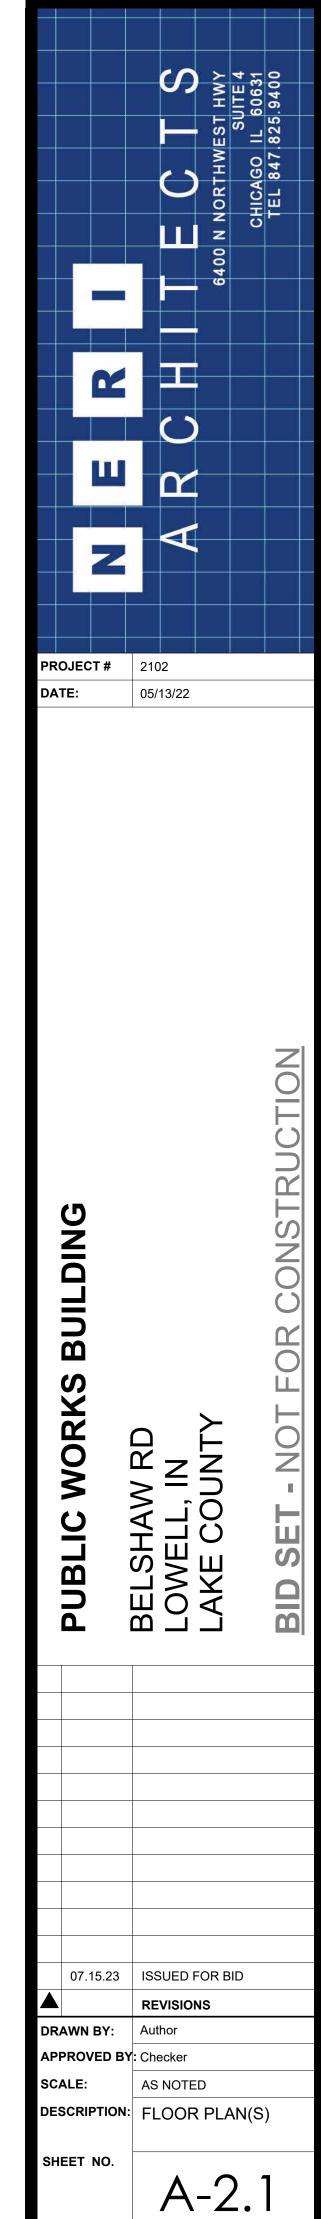
















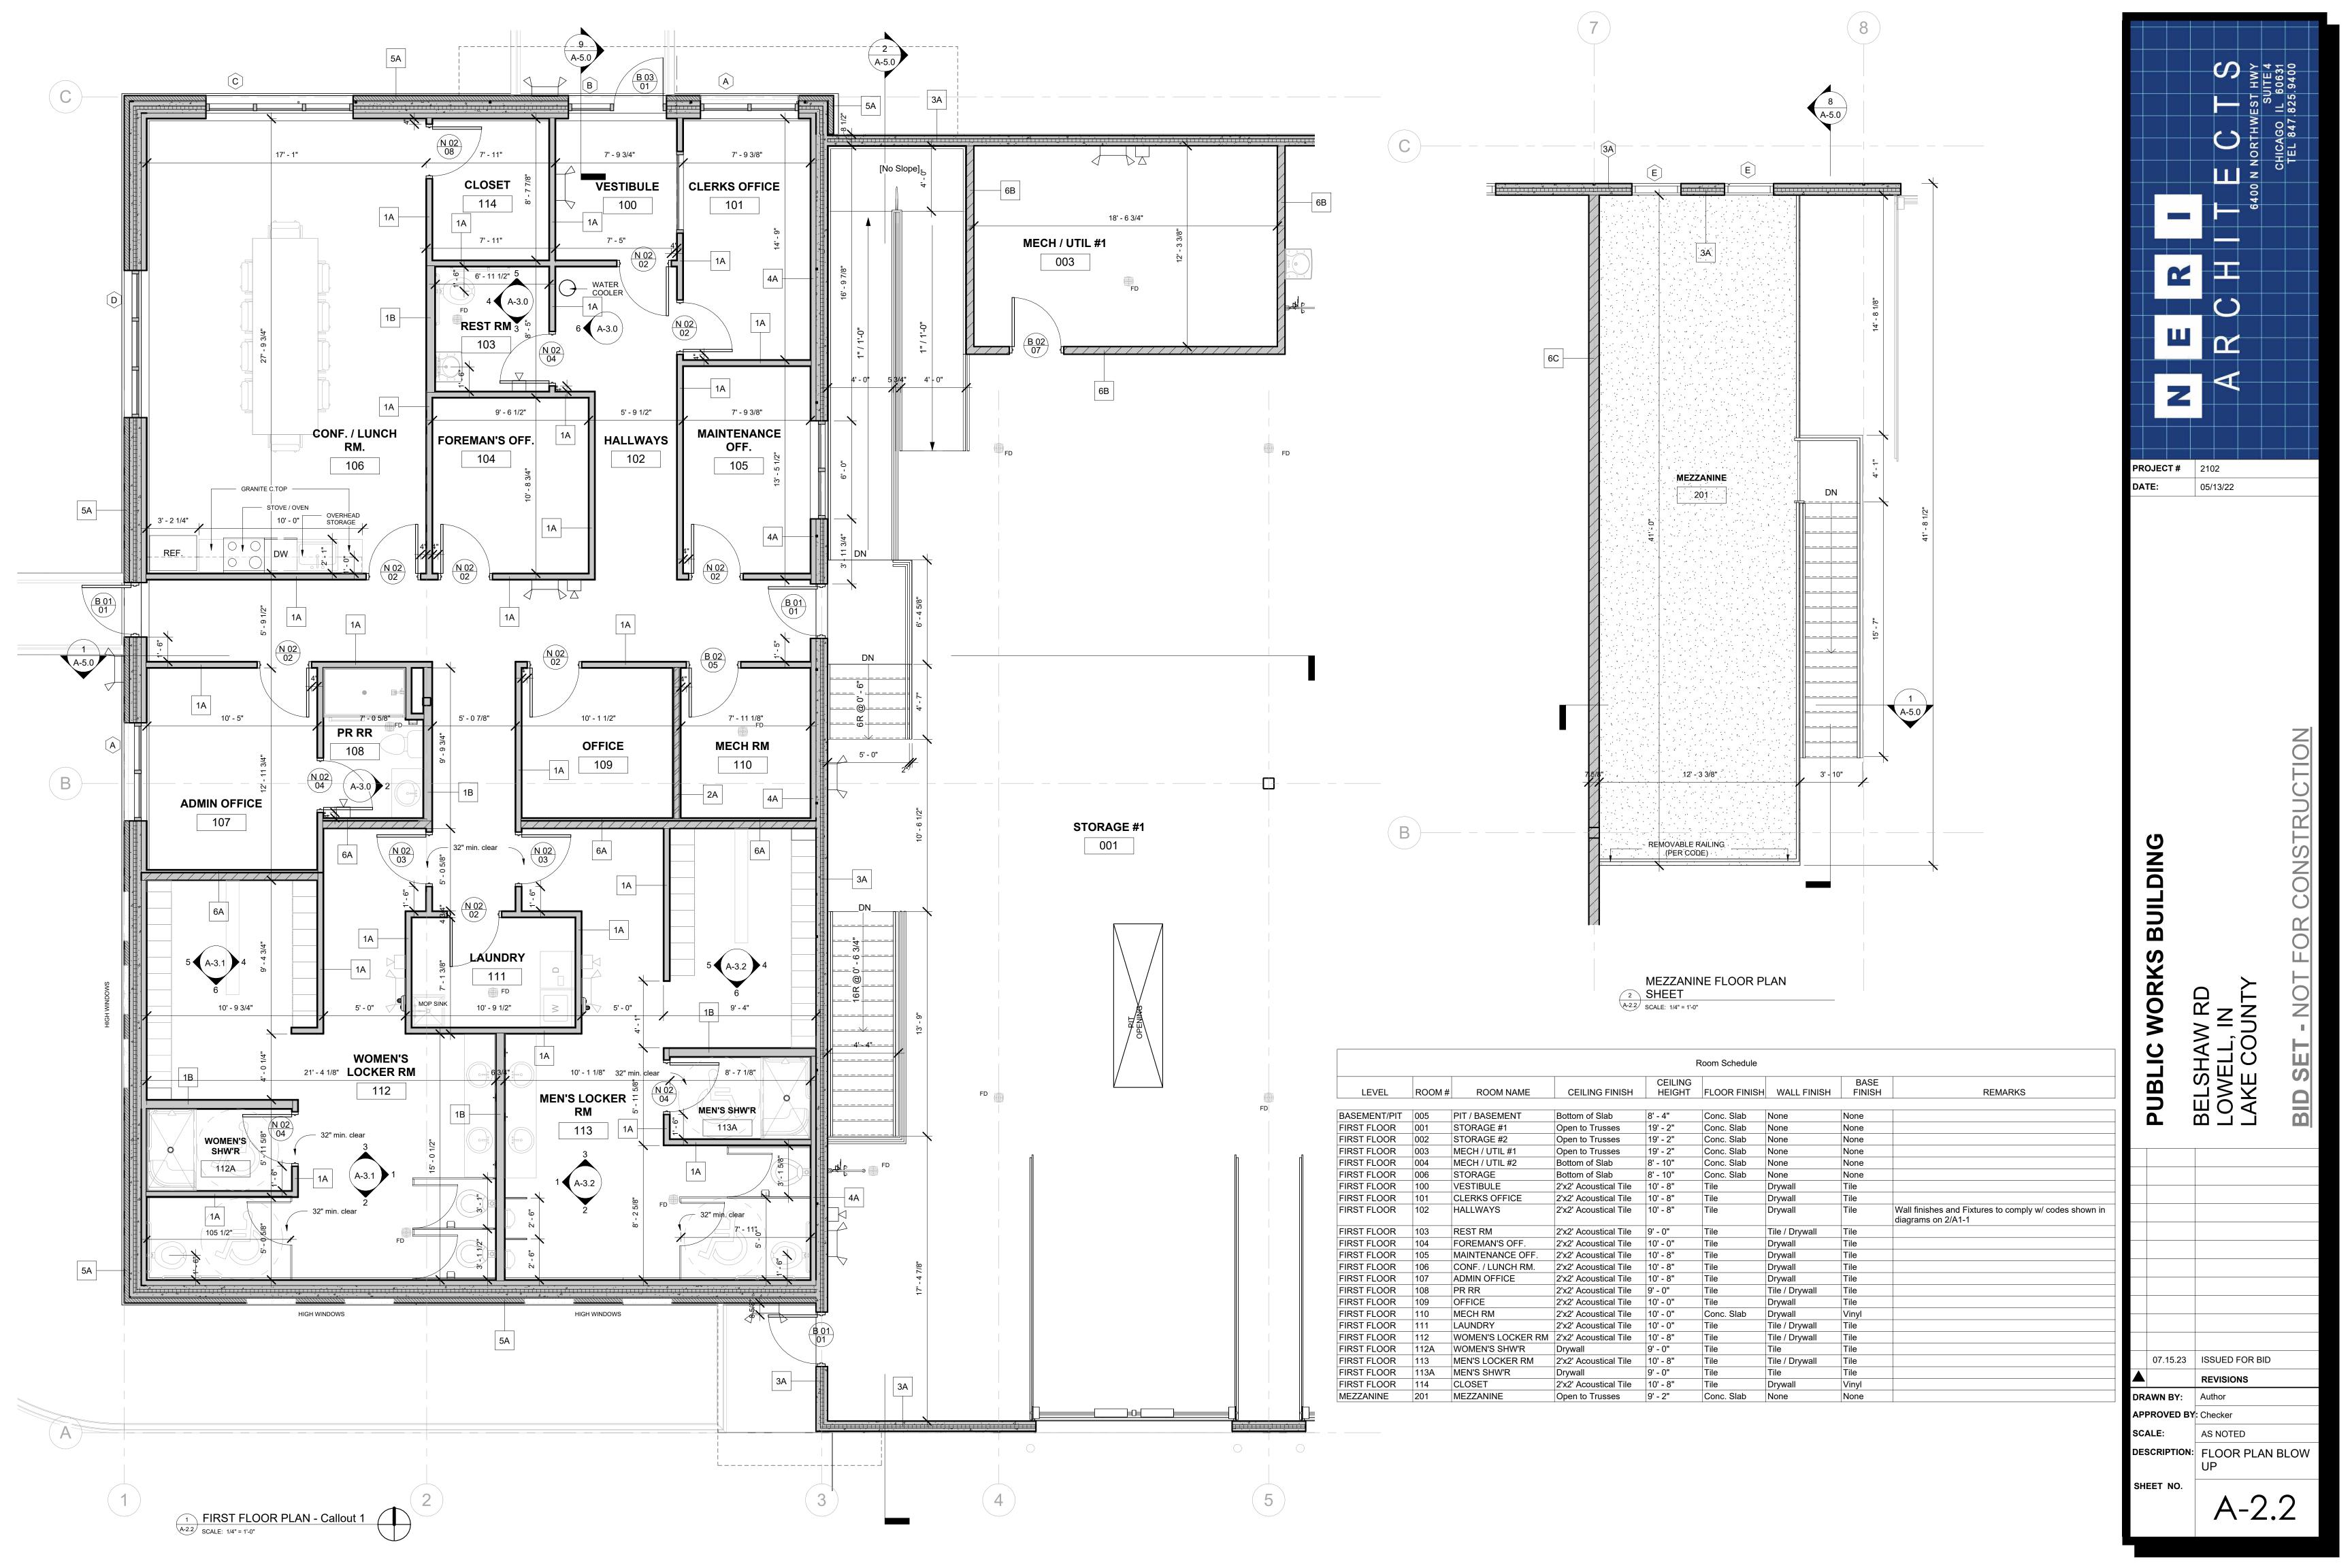


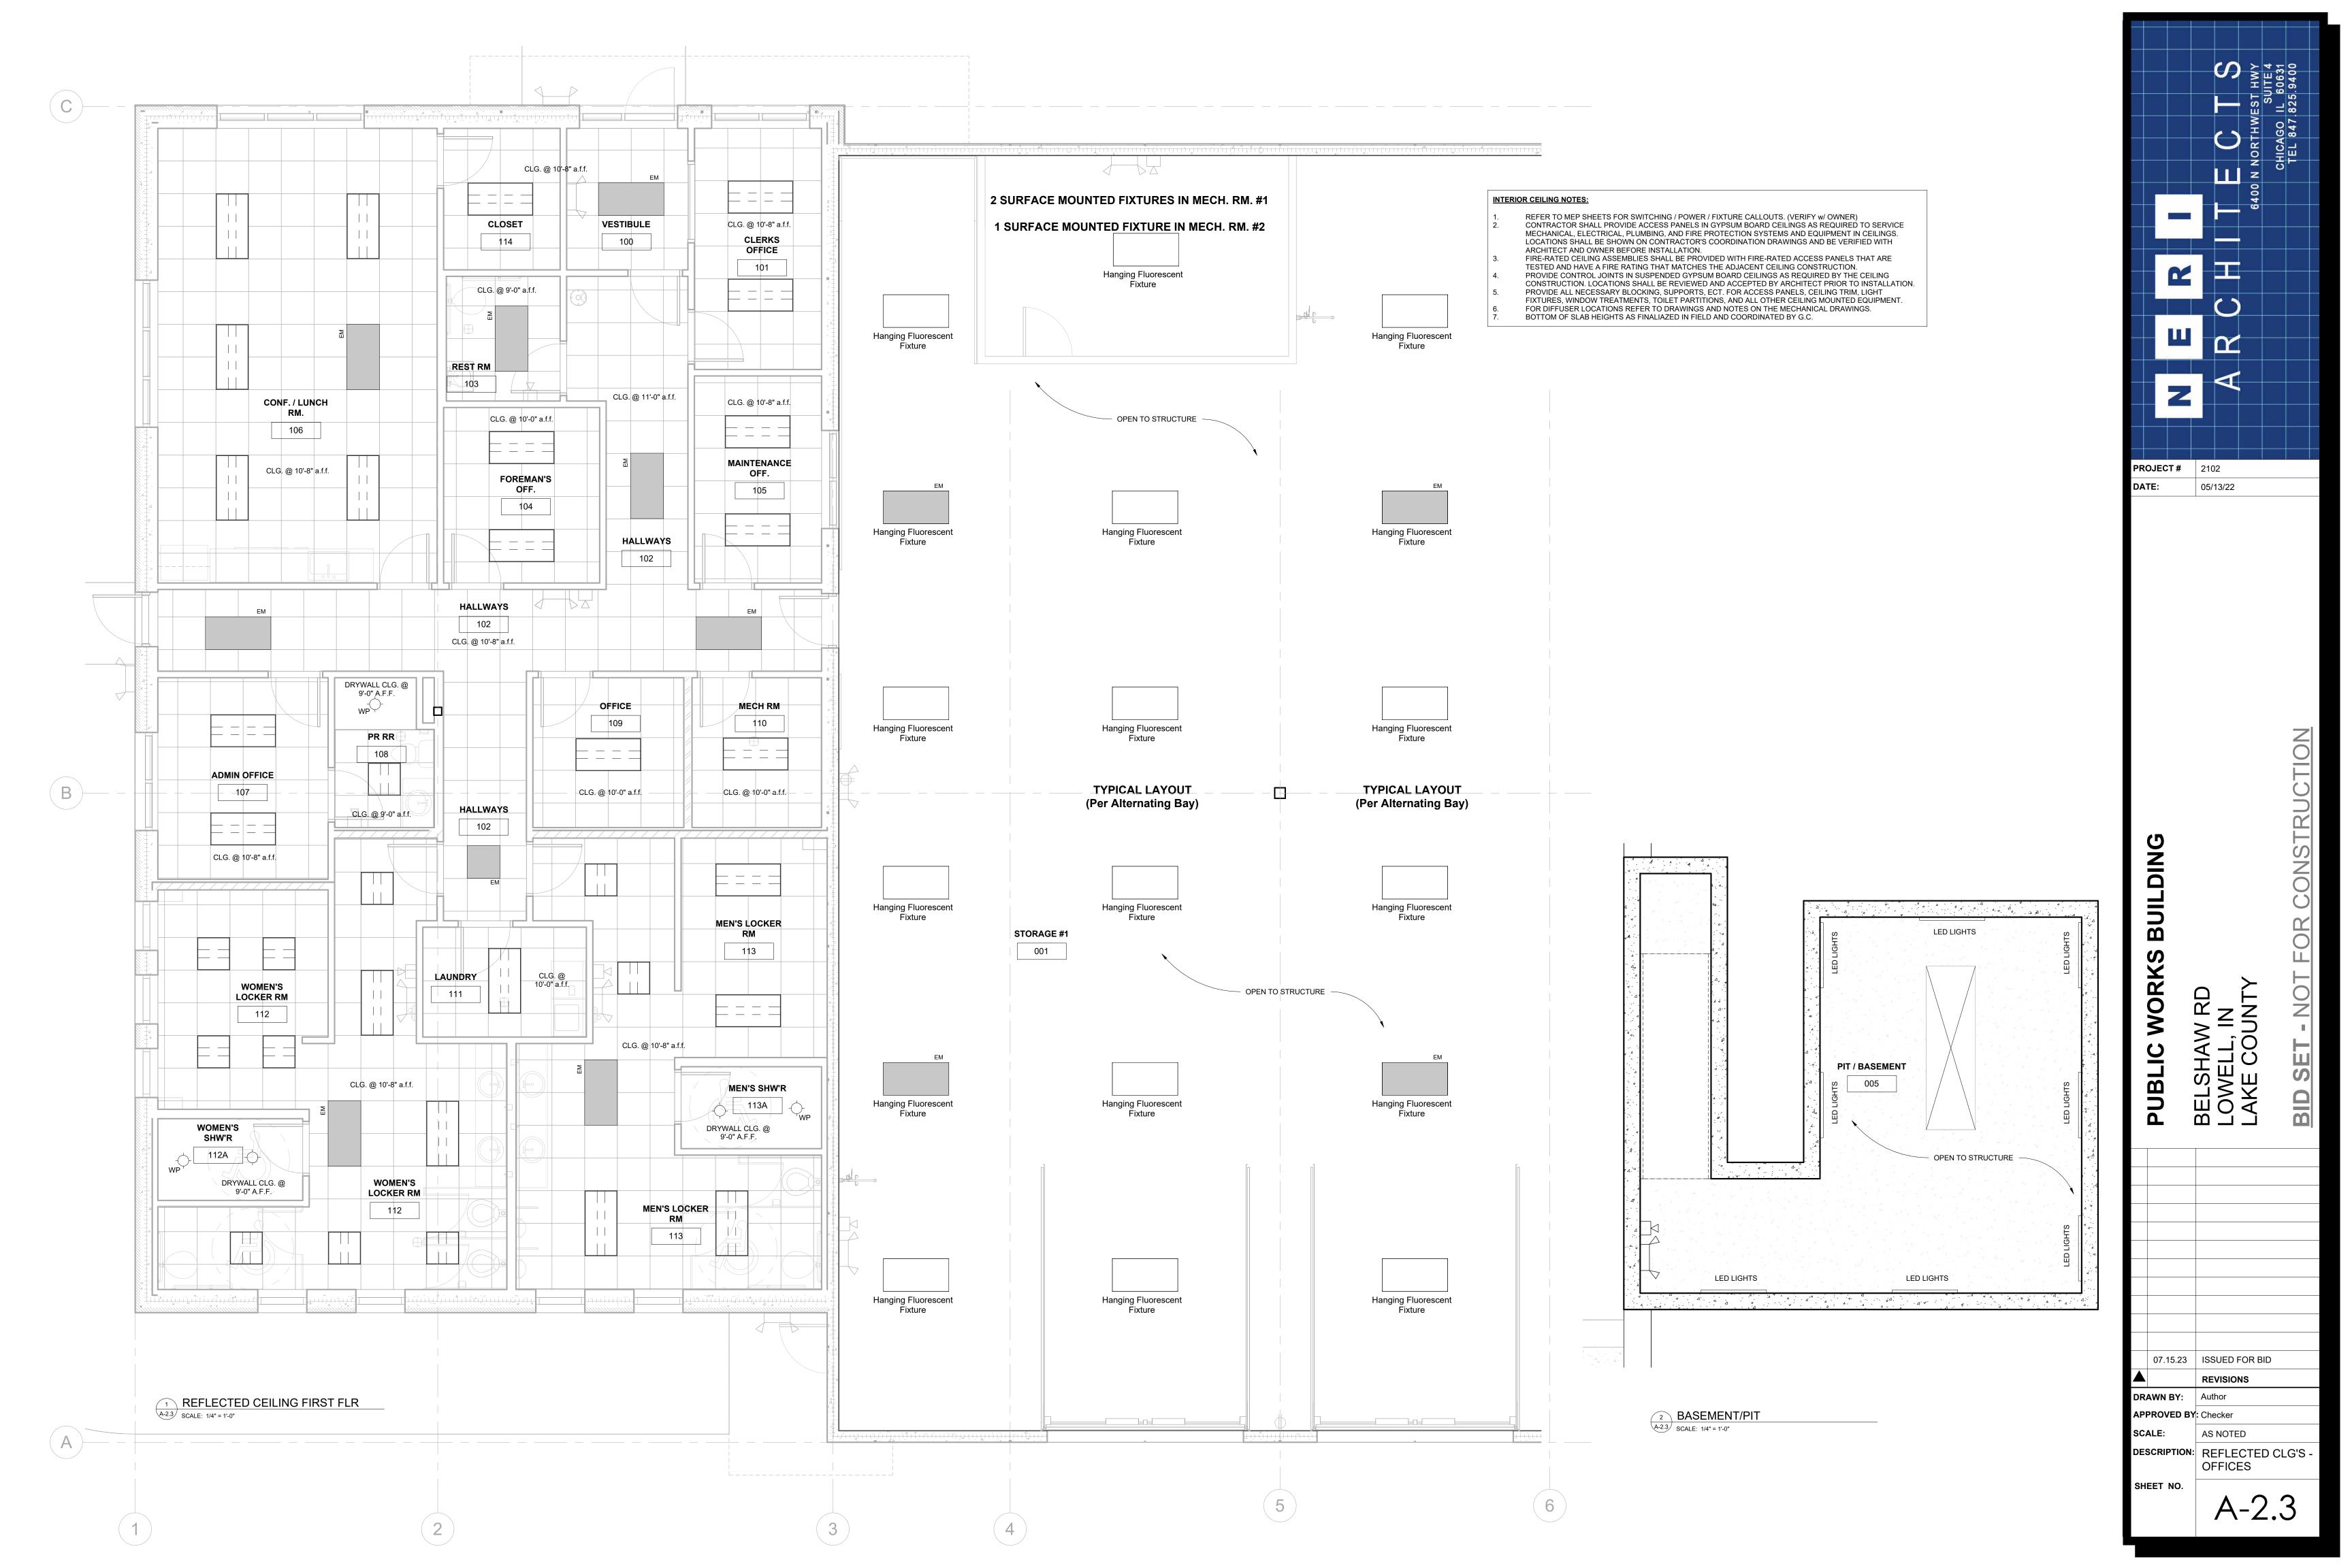


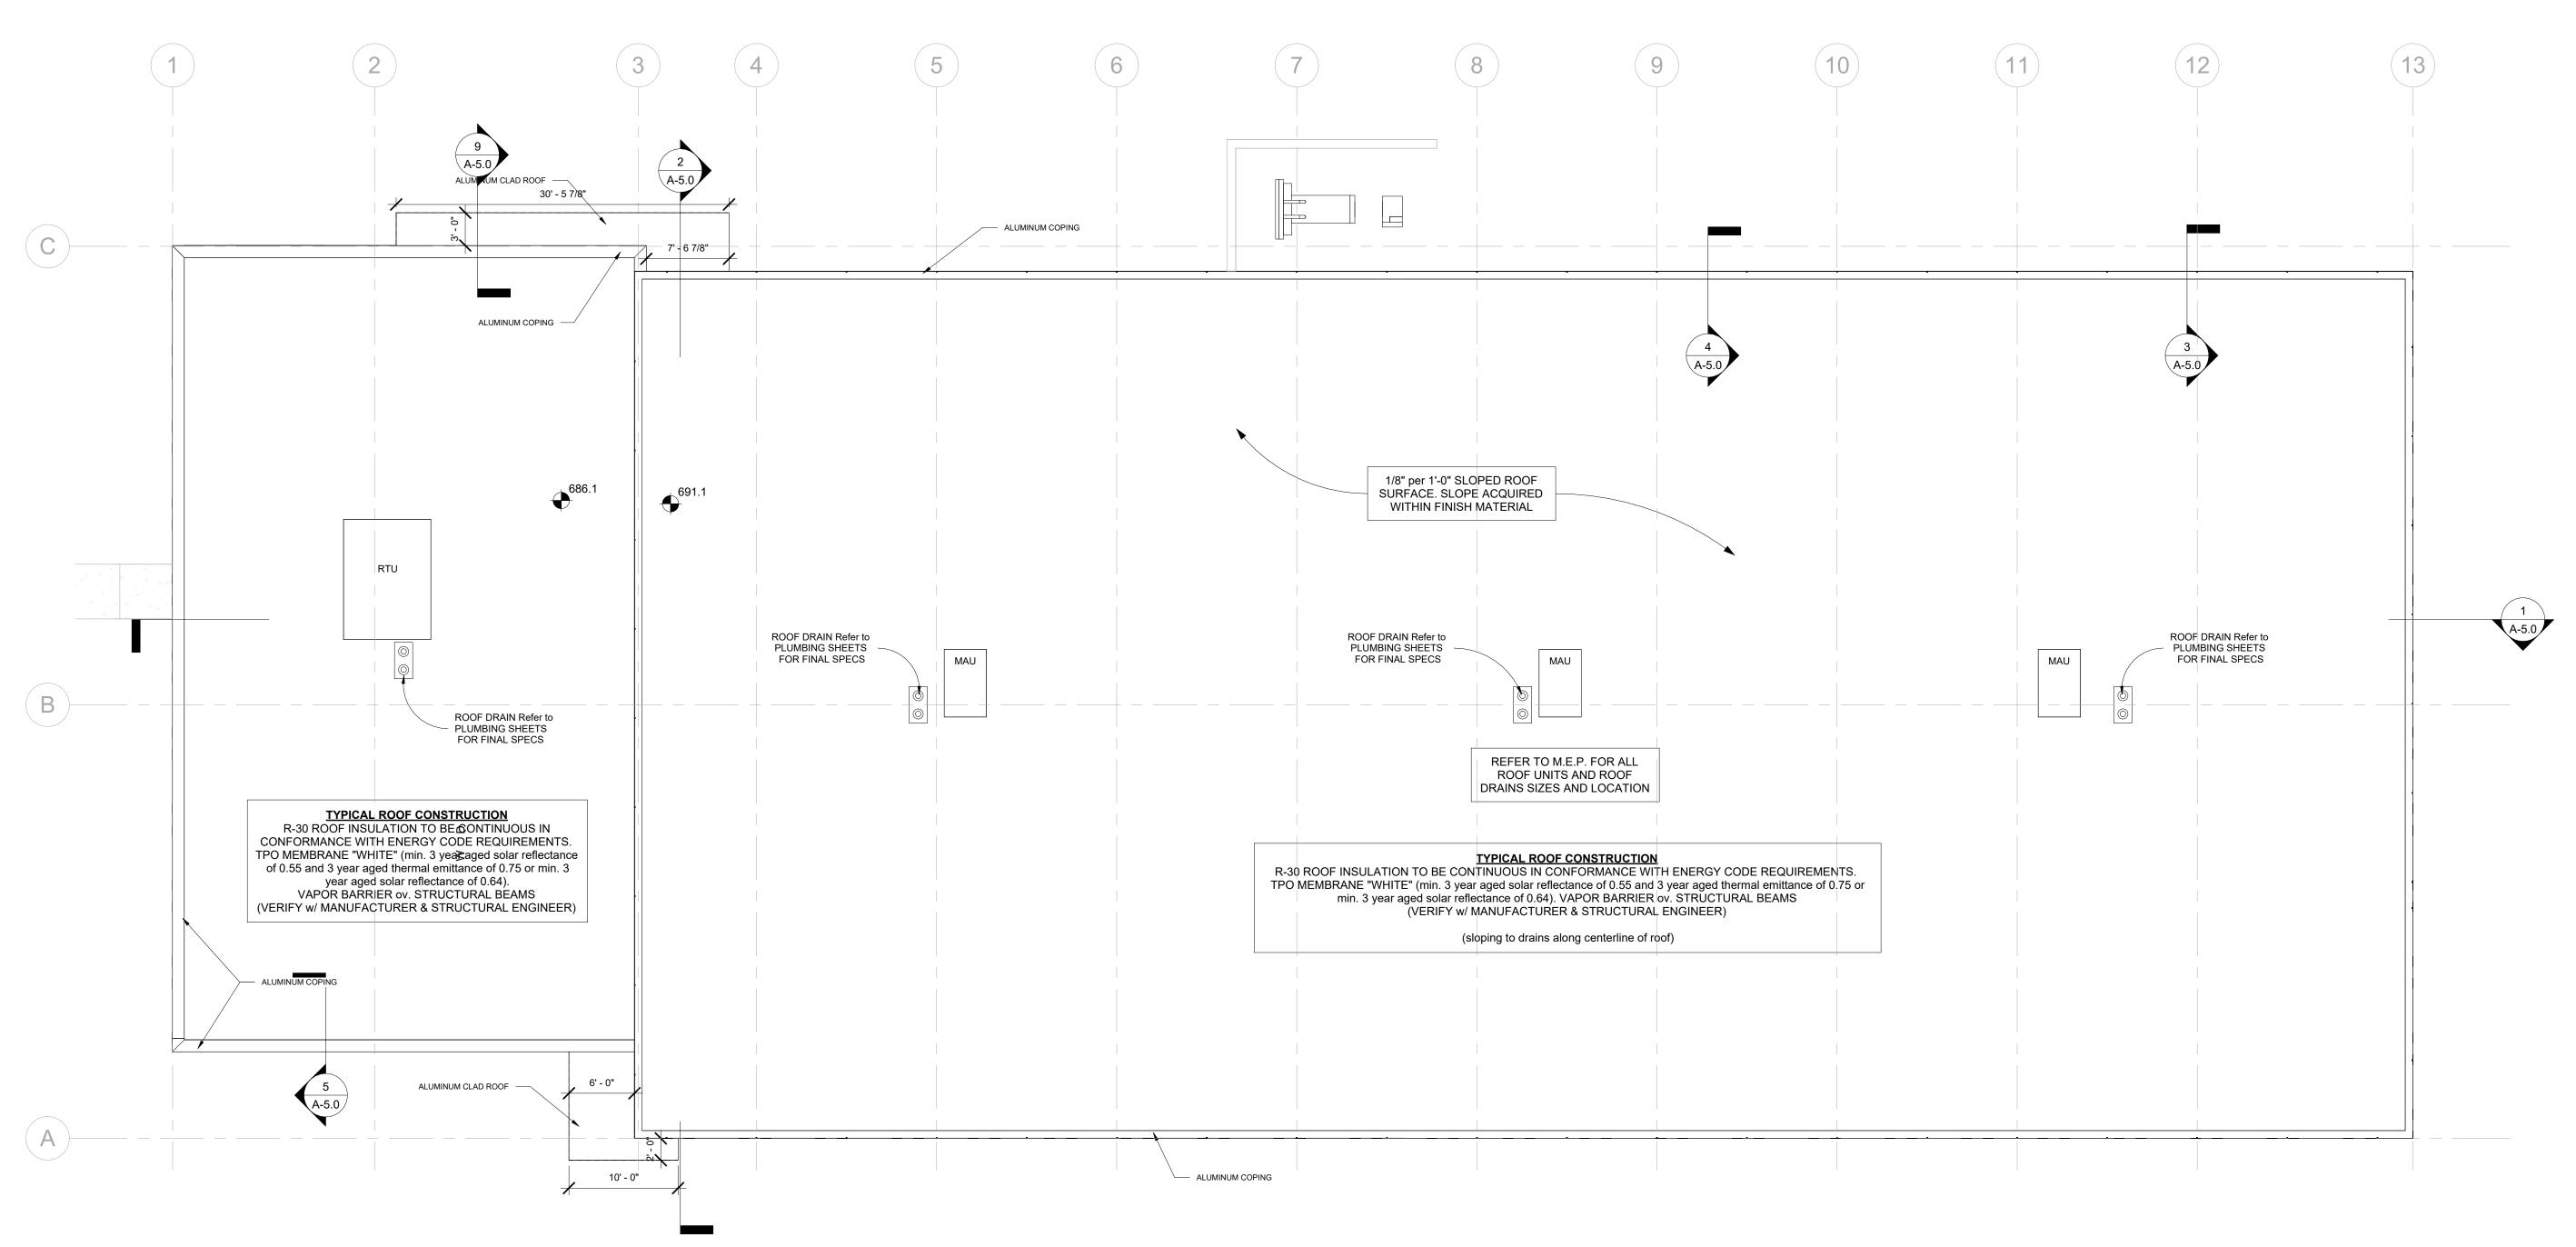



1 UPPER ROOF
A-2.4 SCALE: 1/8" = 1'-0"

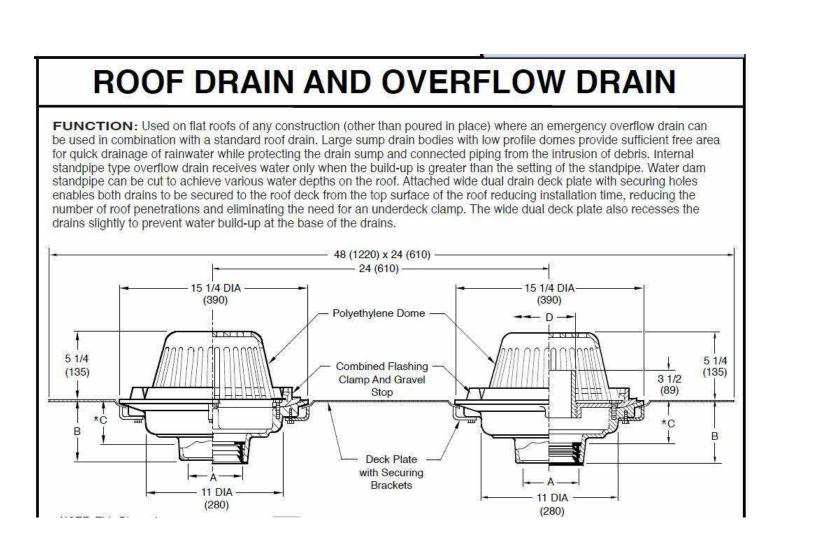


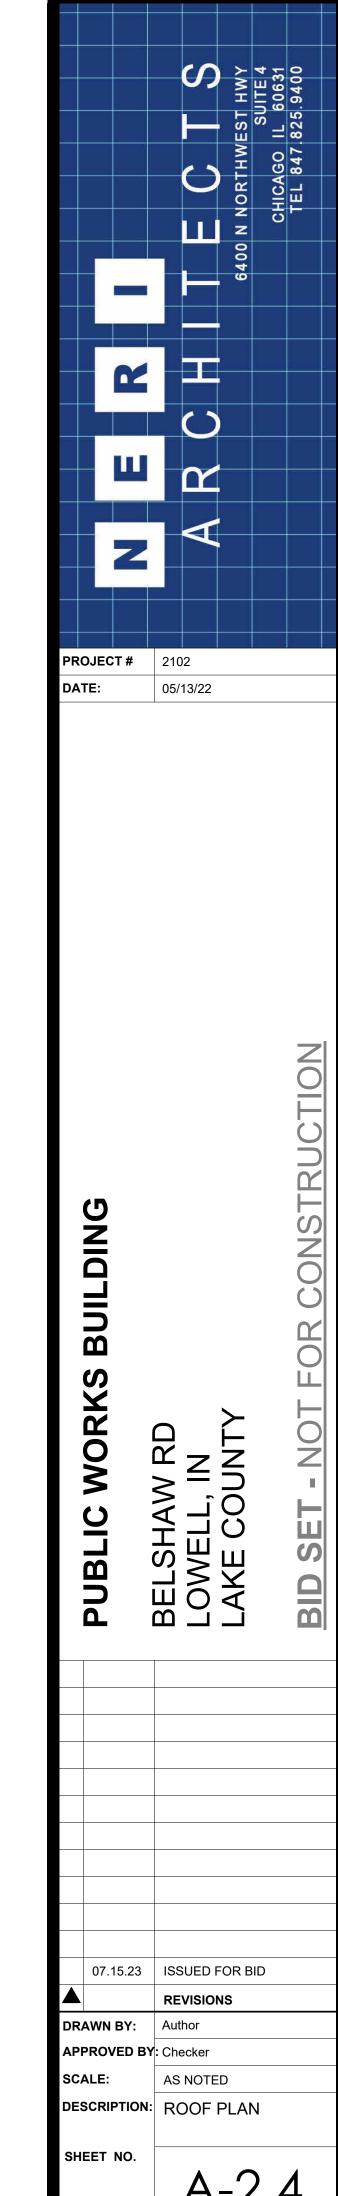


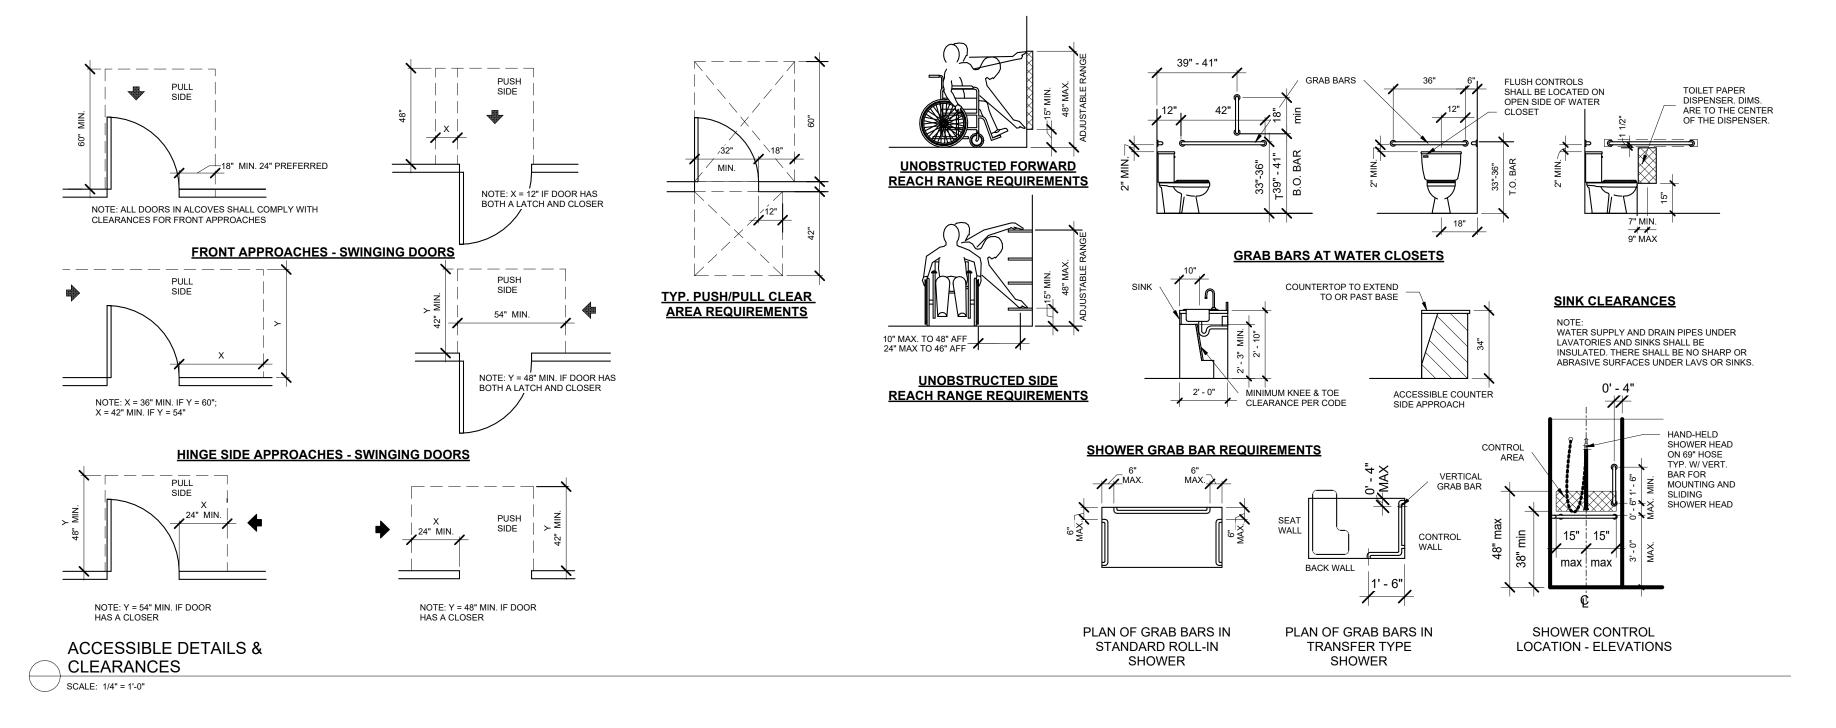

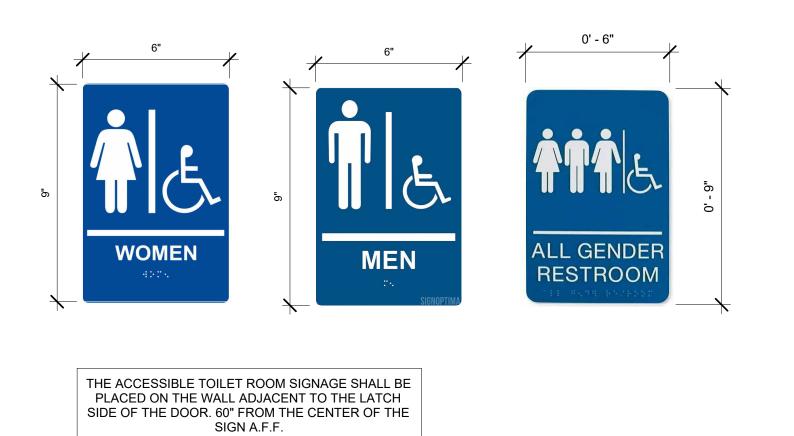


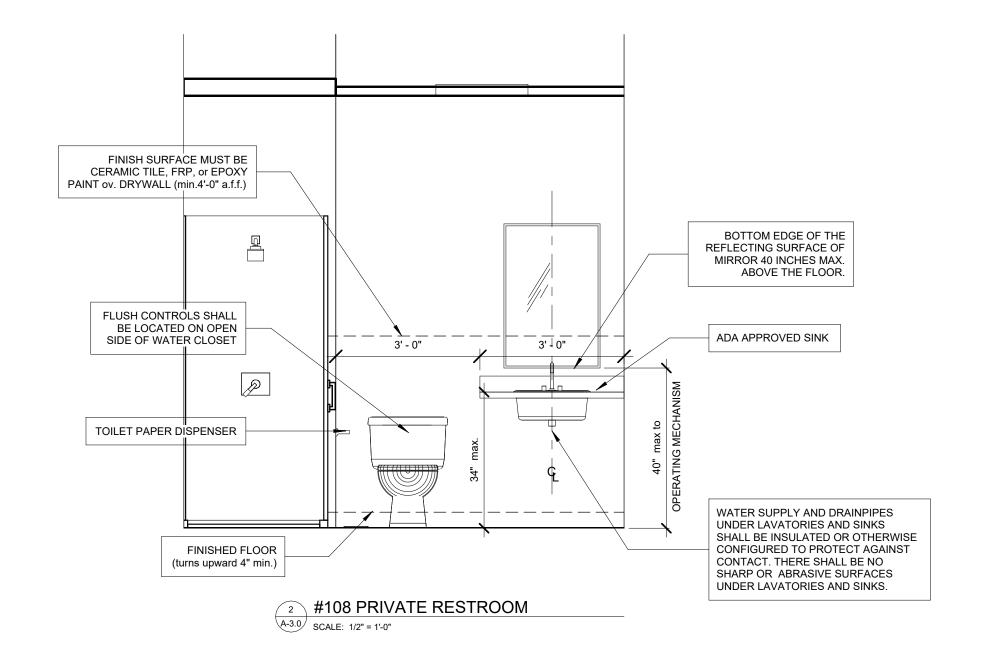


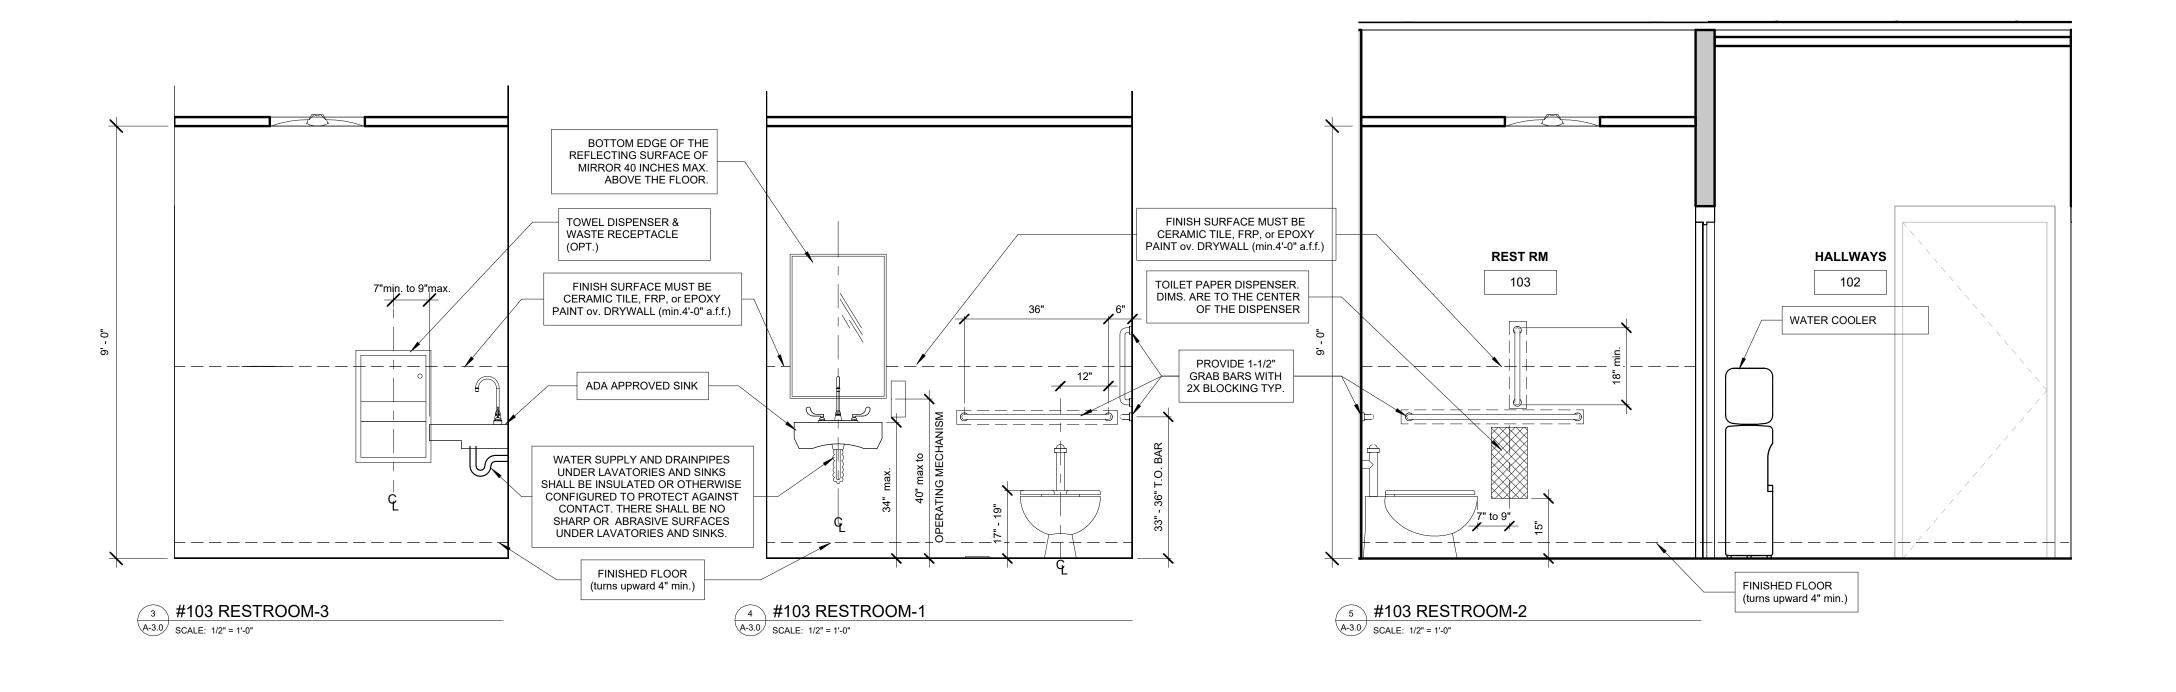


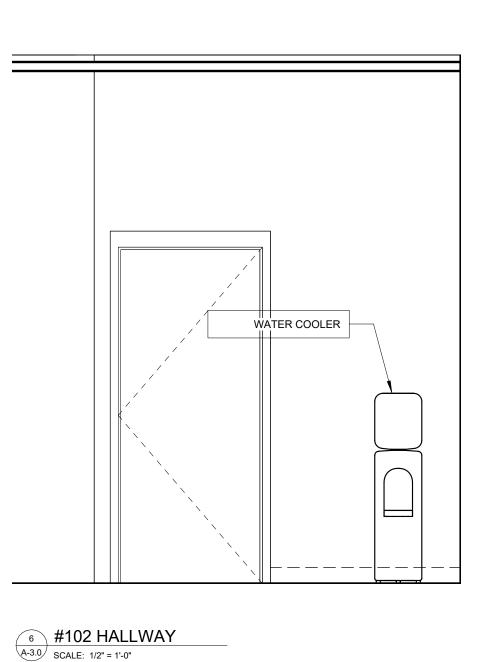





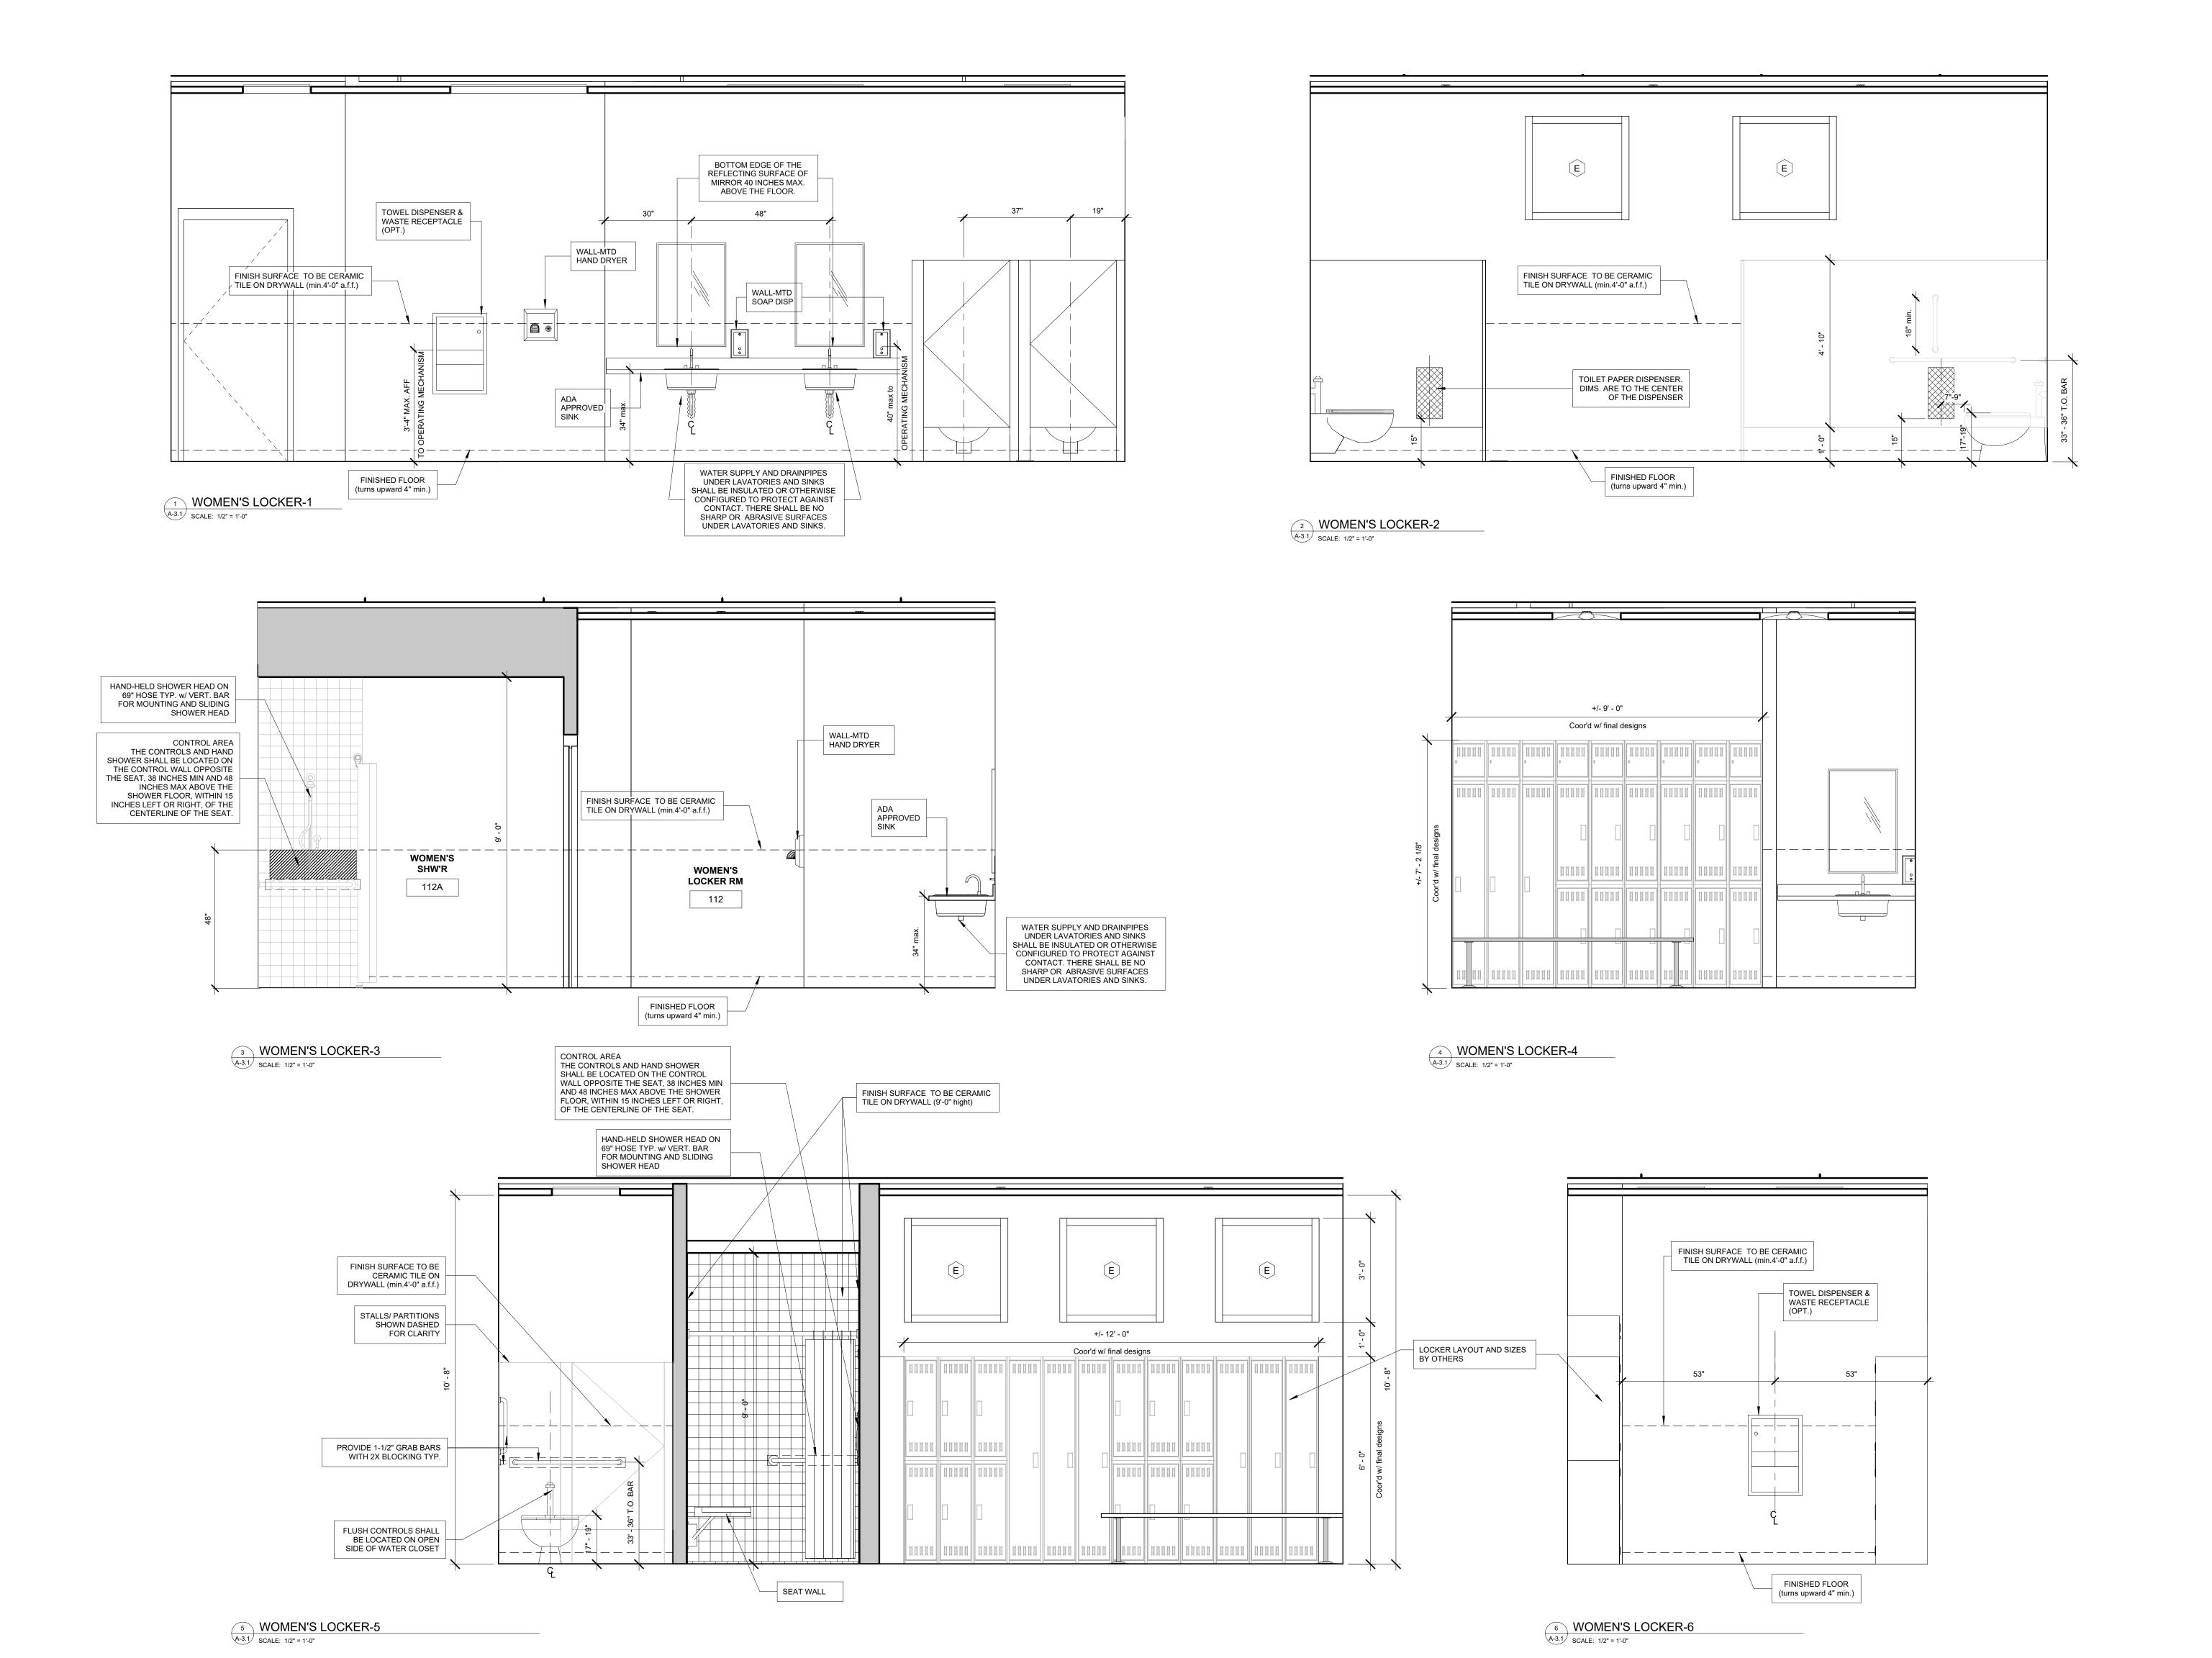


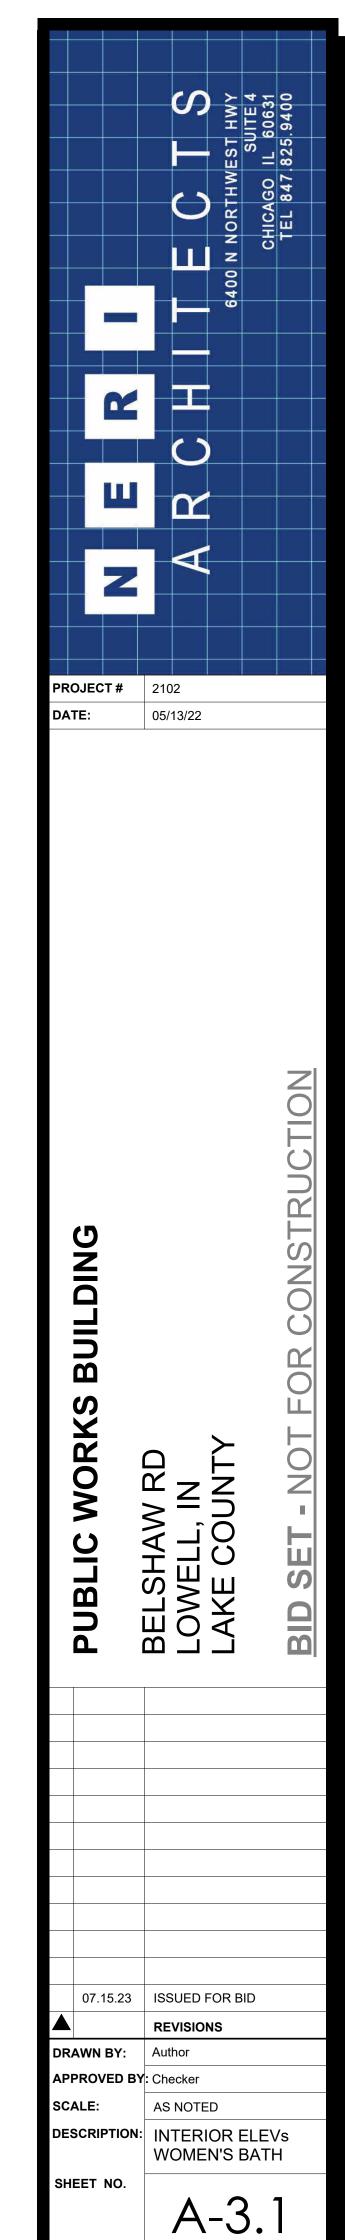

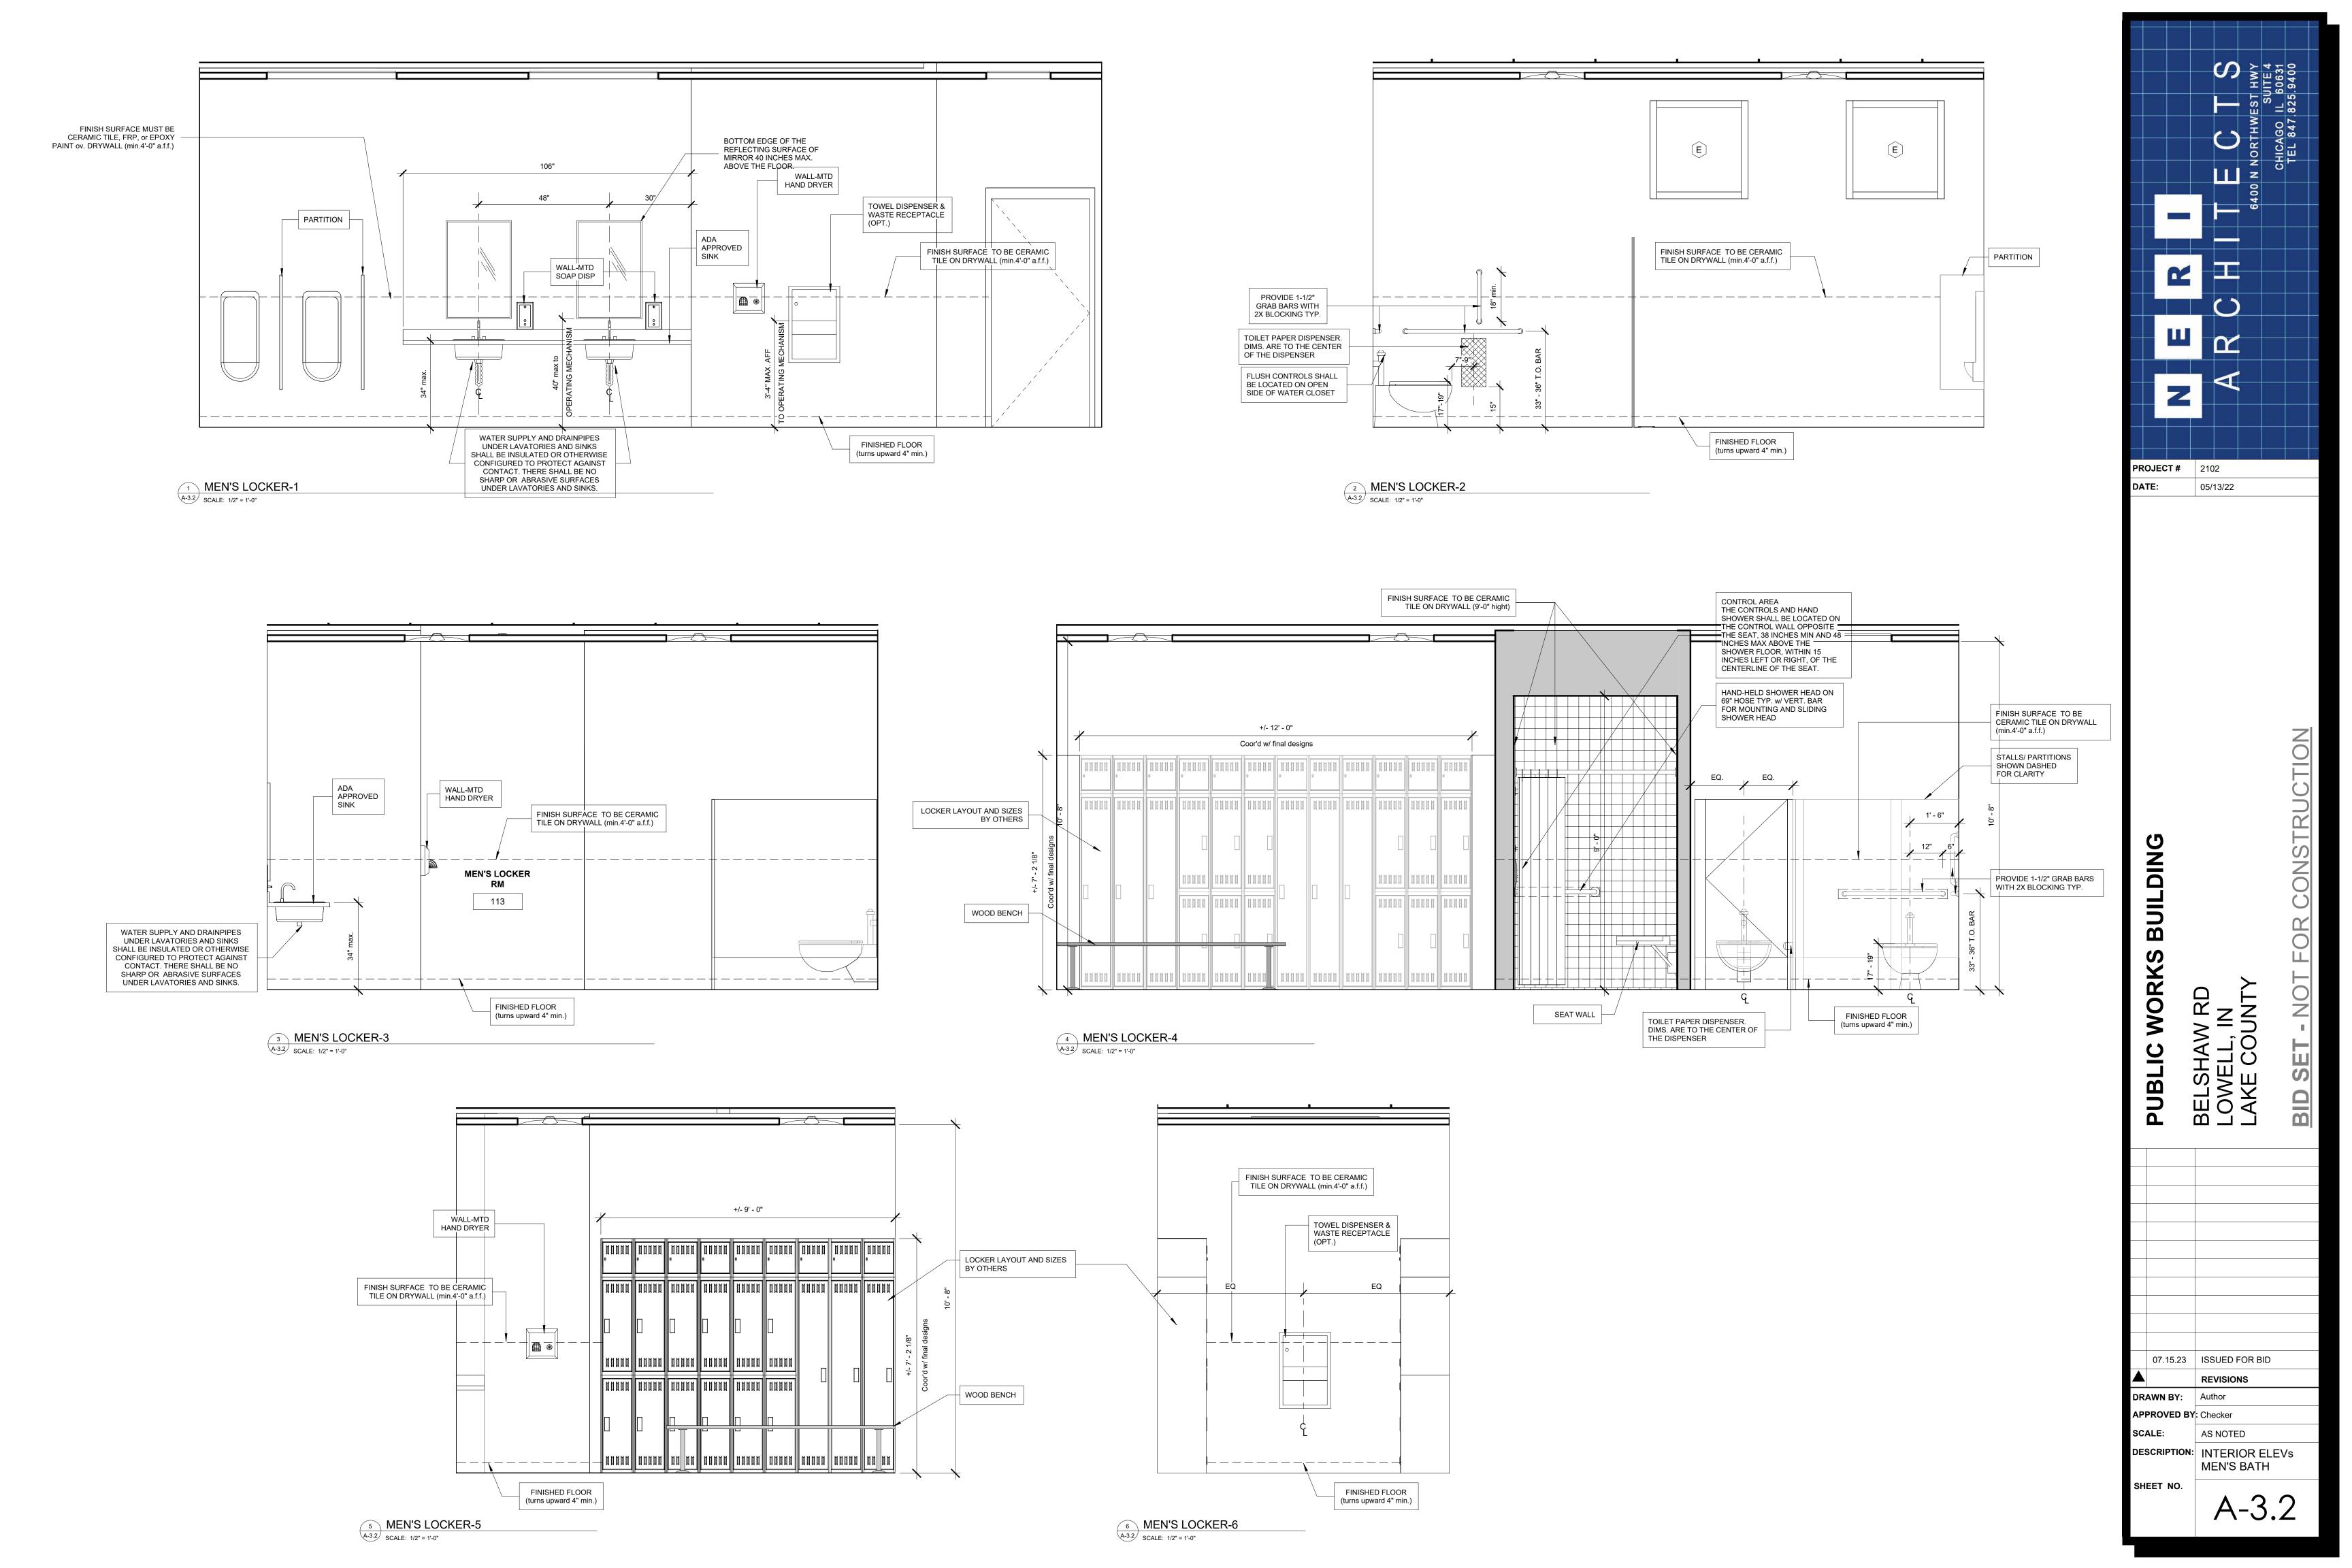

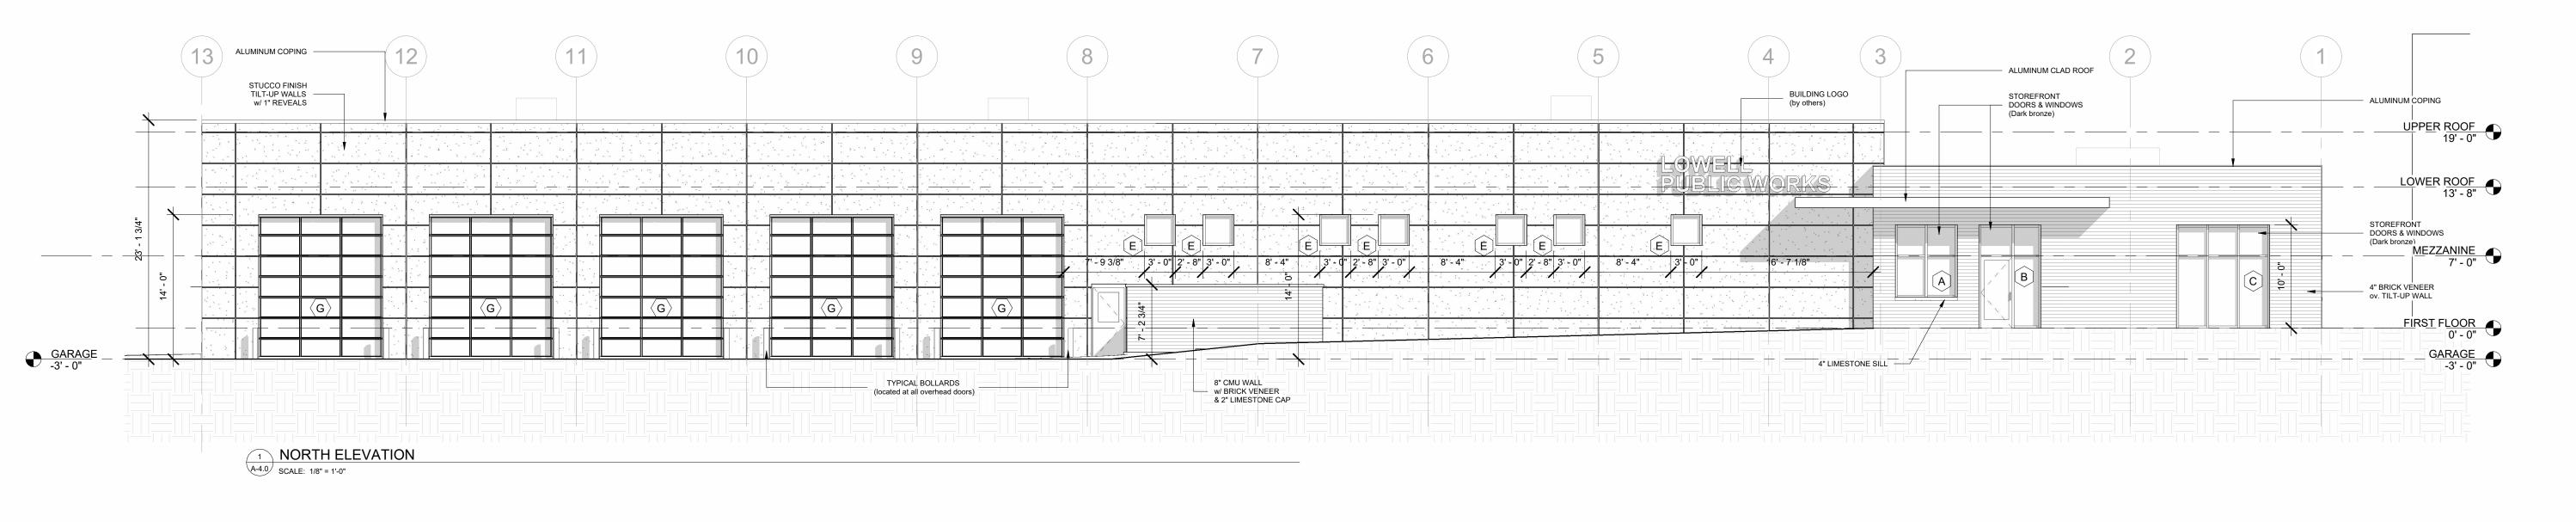

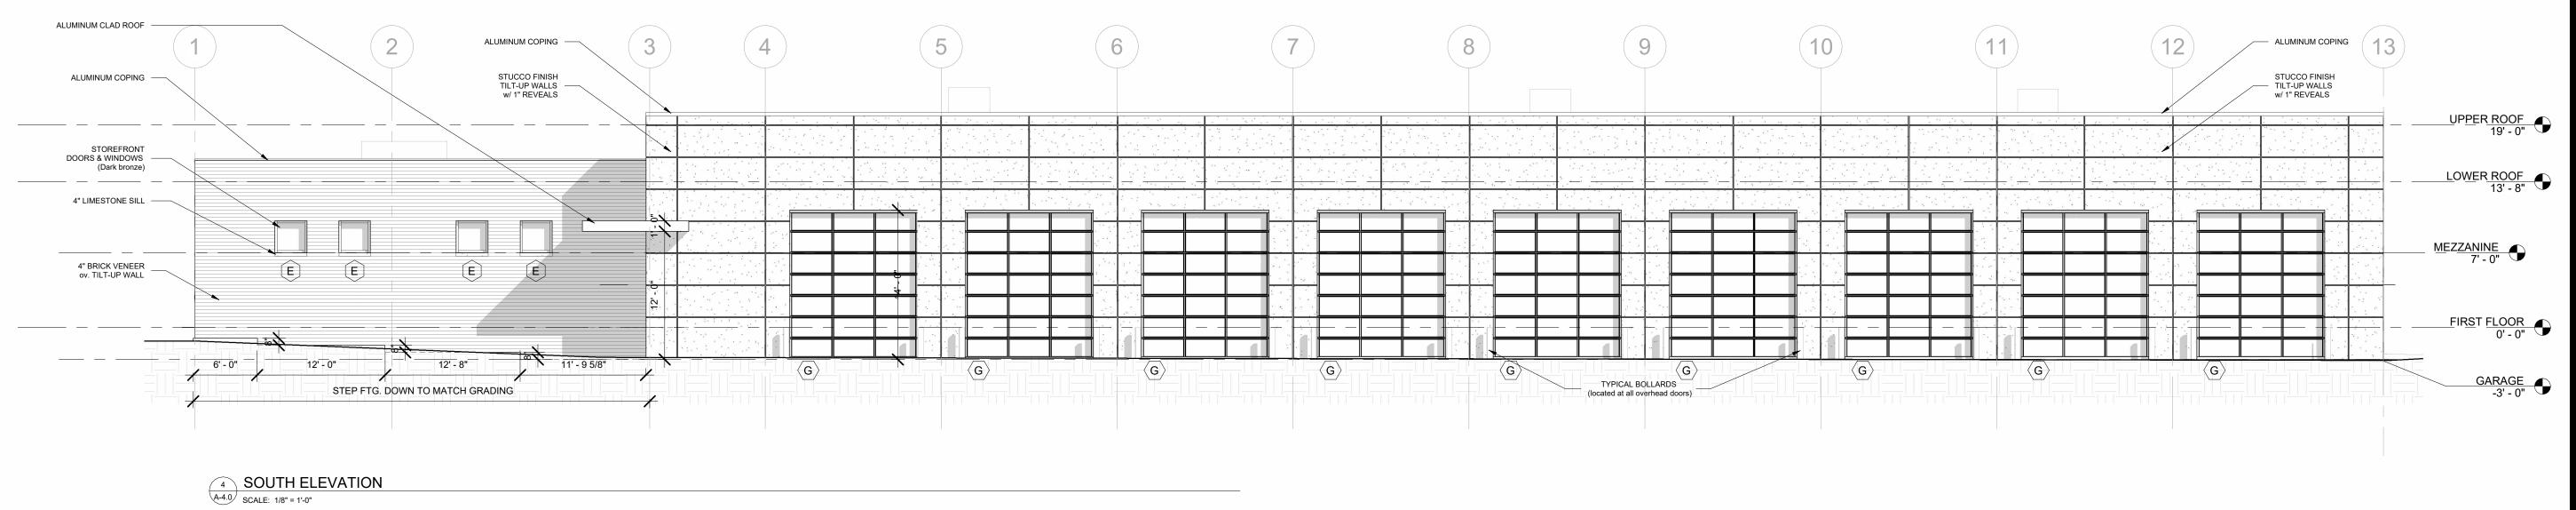

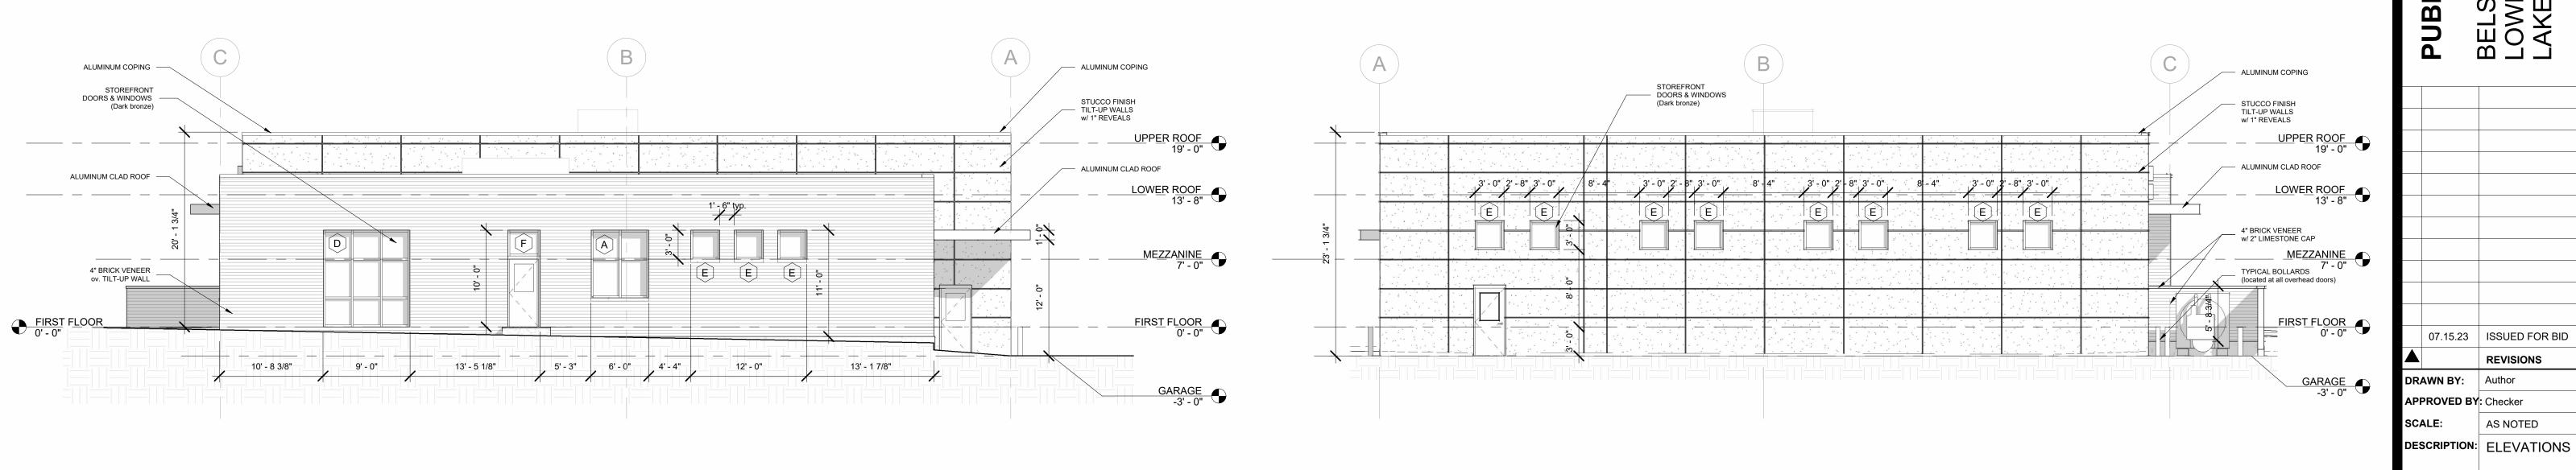

3 WEST ELEVATION
SCALE: 1/8" = 1'-0"

EAST ELEVATION
SCALE: 1/8" = 1'-0"




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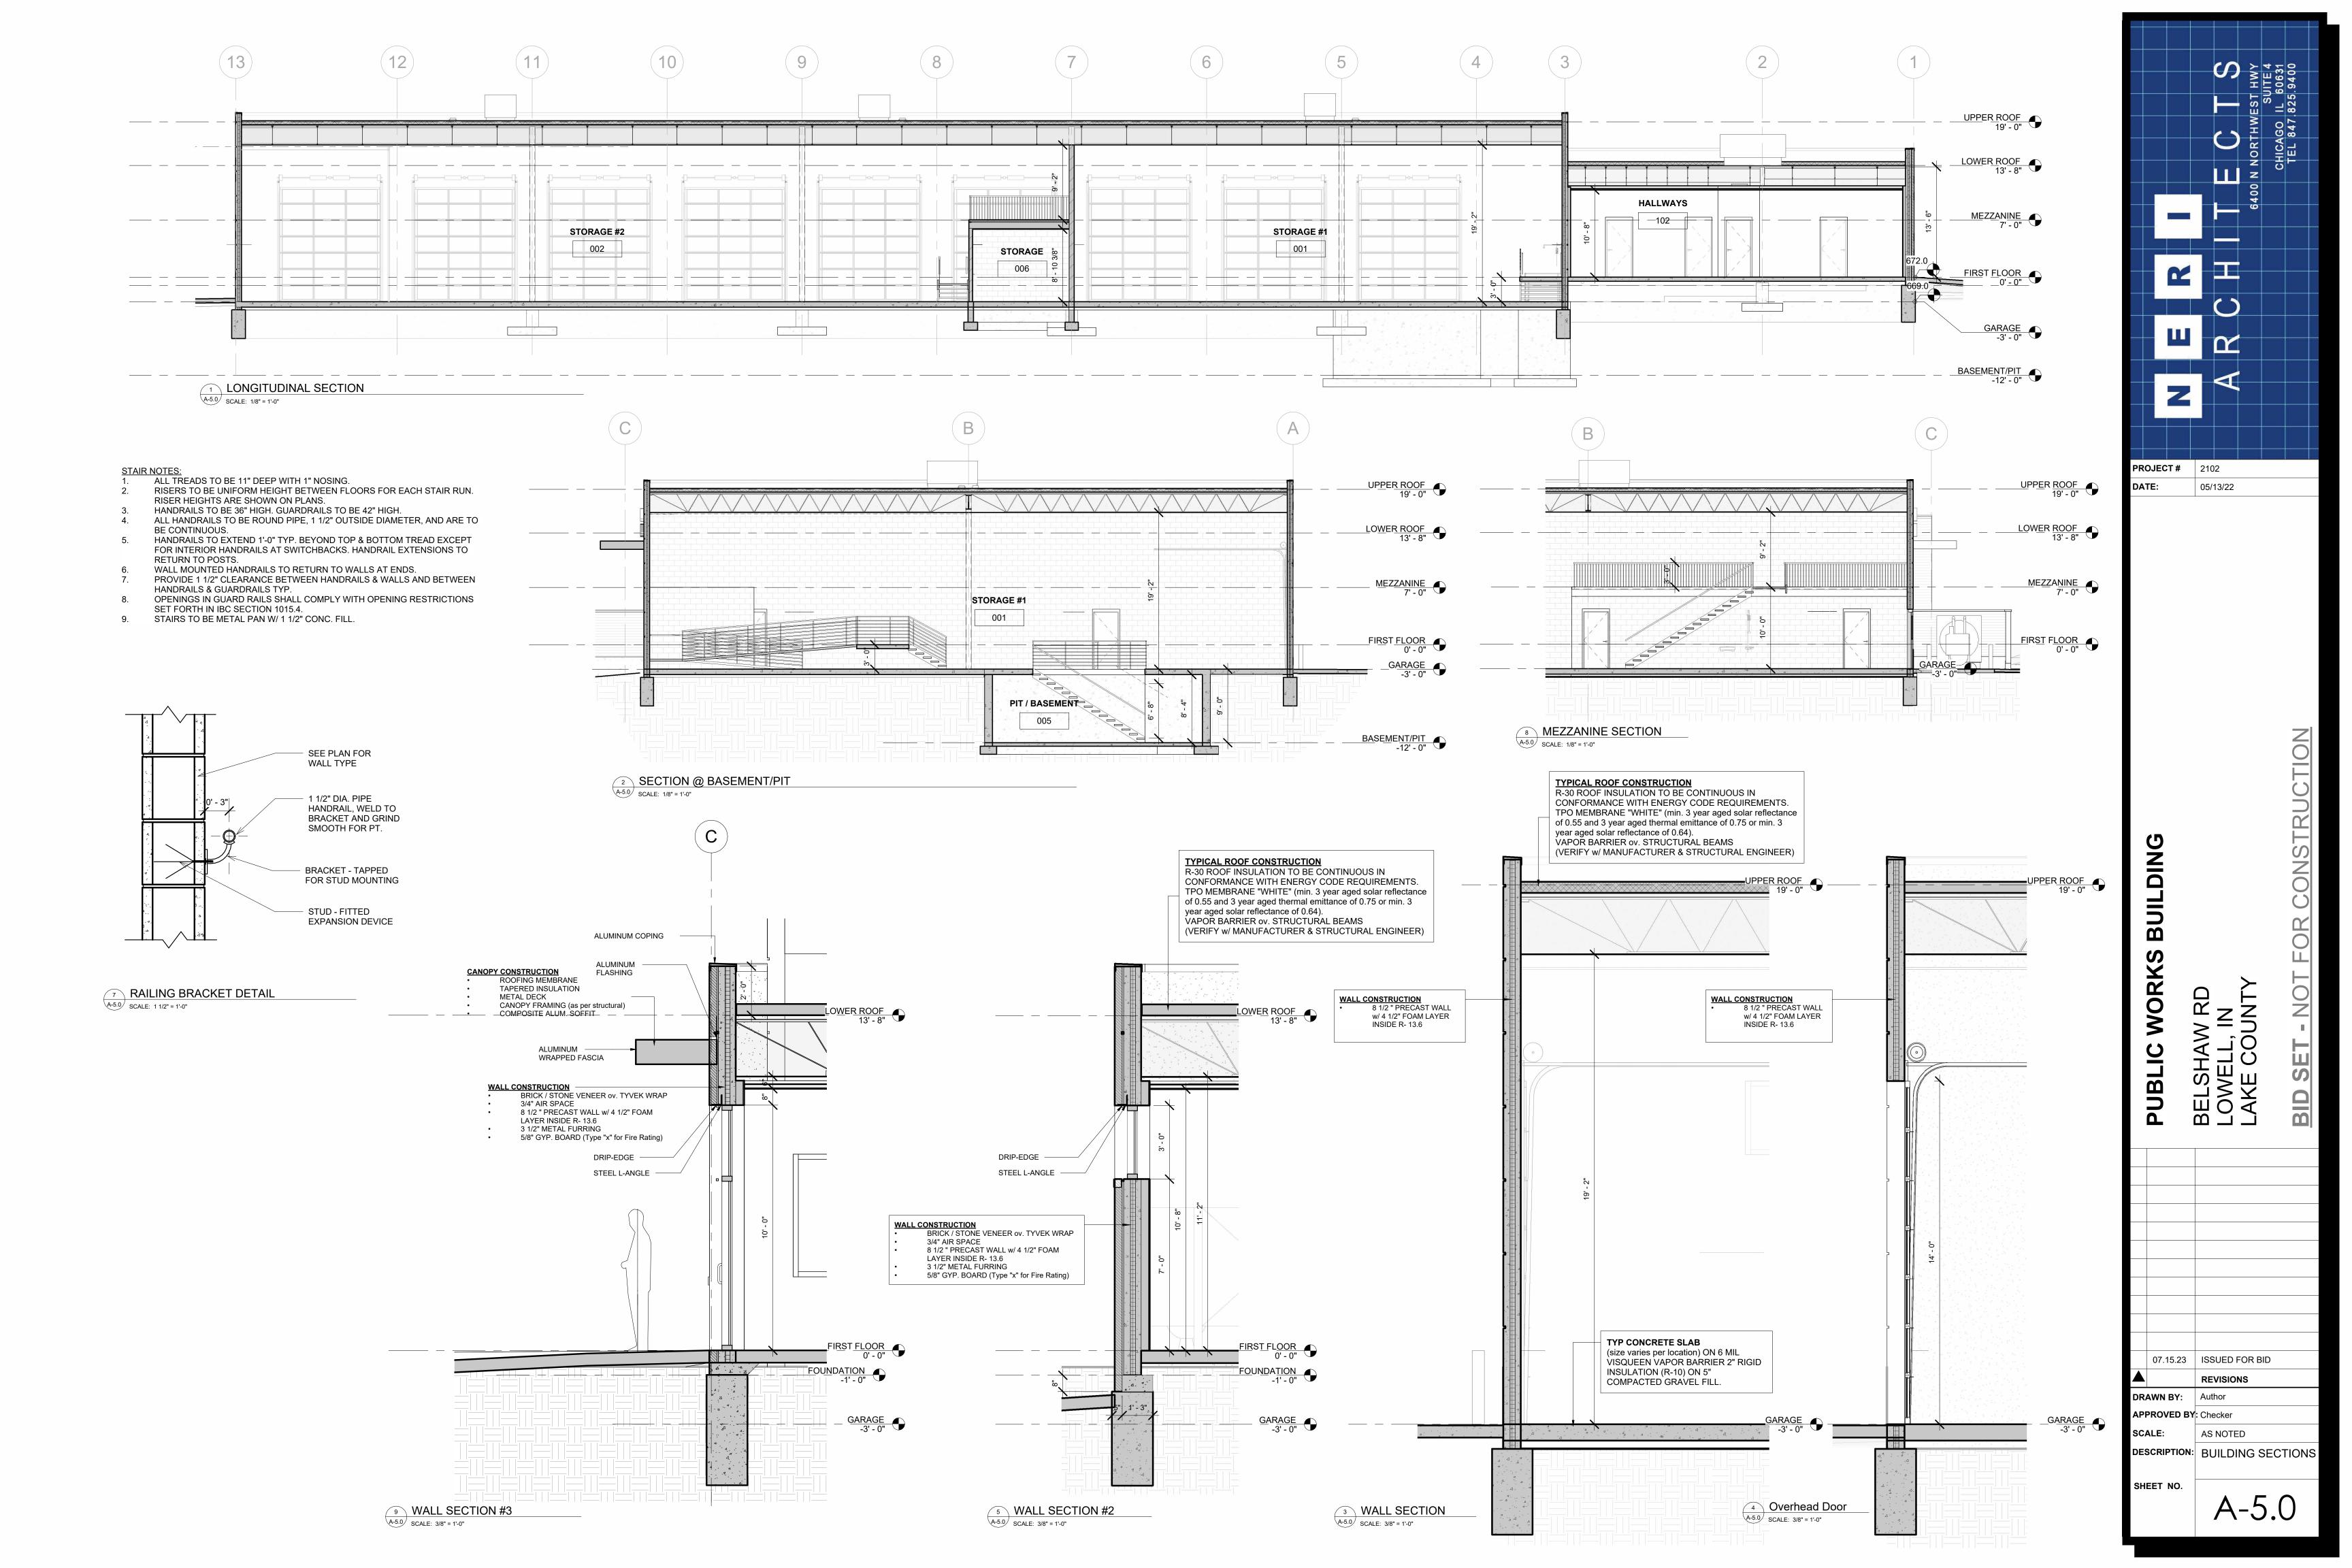
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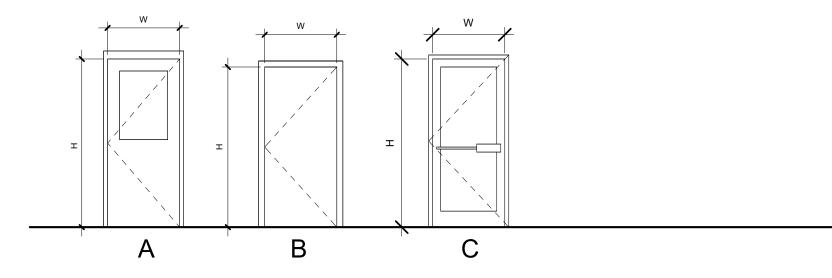
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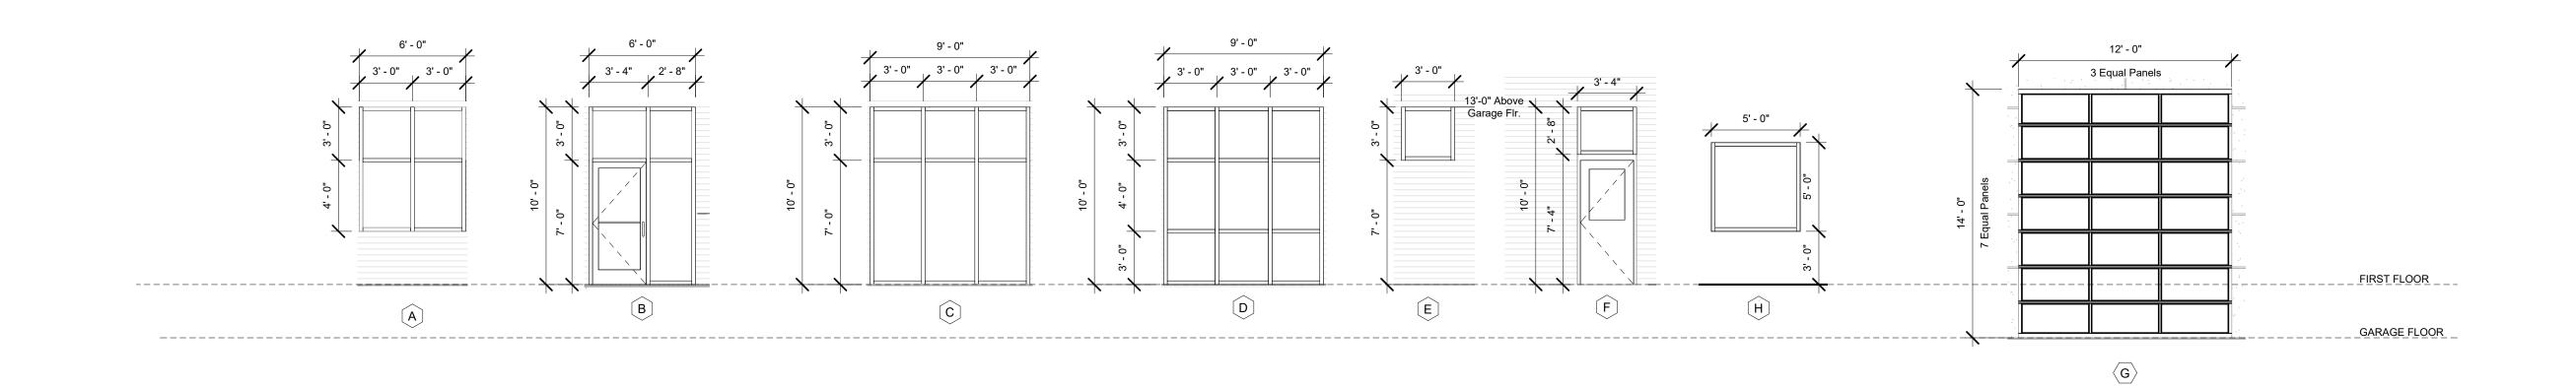






DOOR TYPE SCHEDULE											
DOOR FRAME											
WIDTH	HEIGHT	ELEV	MATERIAL	FINISH	MATERIAL	FINISH	REMARKS				
3'-0"	7'-0"	Α	MTL/GLASS	ALUM STOREFRONT	MTL	ALUM STOREFRONT					
3'-0"	7'-0"	В	WD	PTD	WD	PTD					
3'-0"	7'-0"	С	MTL/GLASS	ALUM STOREFRONT	MTL	ALUM STOREFRONT					
	3'-0" 3'-0"	3'-0" 7'-0" 3'-0" 7'-0"	WIDTH HEIGHT ELEV 3'-0" 7'-0" A 3'-0" 7'-0" B	WIDTH HEIGHT ELEV MATERIAL 3'-0" 7'-0" A MTL/GLASS 3'-0" 7'-0" B WD	WIDTH HEIGHT ELEV MATERIAL FINISH 3'-0" 7'-0" A MTL/GLASS ALUM STOREFRONT 3'-0" 7'-0" B WD PTD	WIDTH HEIGHT ELEV MATERIAL FINISH MATERIAL 3'-0" 7'-0" A MTL/GLASS ALUM STOREFRONT MTL 3'-0" 7'-0" B WD PTD WD	WIDTH HEIGHT ELEV MATERIAL FINISH MATERIAL FINISH 3'-0" 7'-0" A MTL/GLASS ALUM STOREFRONT MTL ALUM STOREFRONT 3'-0" 7'-0" B WD PTD WD PTD				

				HARDWARE SCHEDULE					
SET#	OPENING TYPE	HINGES	LOCKSET	KNOB/LEVER	FINISH	CLOSER	STOP	WEATHERSTRIPPING	REMARKS
1 ENT	TRANCES	1 1/2 PAIR BUTT, 4 1/2"x4"	CYLINDER DEADLATCH. KEY EXTERIOR	PUSH BAR INTERIOR, PULL EXTERIOR	MATCH STOREFRONT	ADA POWER OPERATOR WITH ACTUATOR PLATE INSIDE & KEY OPERATOR OUTSIDE		YES	THRESHOLD
)2 OFF	FICE	1 1/2 PAIR BB BUTT, 4 1/2"x4"	KEYED DOUBLE CYLINDER. ANSI E2141	LEVER	SATIN CHROME	NO	WALL	NO	WITH MASTERKEY
BAT	TH MAIN DOOR	1 1/2 PAIR BB BUTT, 4 1/2"x4"	N.A.	PUSH PLATE EXTERIOR, PULL INTERIOR	SATIN CHROME	SURFACE MOUNT, MEDIUM DUTY		NO	
4 BAT	THROOMS	1 1/2 PAIR BB BUTT, 4 1/2"x4"	PRIVACY. ANSI F76A	LEVER	SATIN CHROME	NO	WALL	NO	
5 MEC	CHANICAL	1 1/2 PAIR BB BUTT, 4 1/2"x4"	STOREROOM. ANSI F86 / KEYED(OUT)	LEVER	SATIN CHROME	YES	TBD	NO	KNURLED HARDWARE
6 EXT	TERIOR SWING	1 1/2 PAIR BUTT, 4 1/2"x4"	CYLINDER DEADLATCH. KEY EXTERIOR	PUSH BAR INTERIOR, KNURLED LEVER EXTERIOR	SATIN CHROME	YES	TBD	YES	FULLY GASKETED
7 ELE	ECTRIC ROOM	1 1/2 PAIR BUTT, 4 1/2"x4"	CYLINDER DEADLATCH. KEY EXTERIOR & EMERGENCY PADDLE INTERIOR.	PUSH BAR INTERIOR, LEVER EXTERIOR	SATIN CHROME				SIGNAGE ON DOOR TO READ 'ELECTRICAL ROOM', FULLY GASKETED, KNURLED HARDWARE
8 CLC	OSET	1 1/2 PAIR BB BUTT, 4 1/2"x4"	PASSAGE ANSI F75	LEVER	SATIN CHROME		WALL		

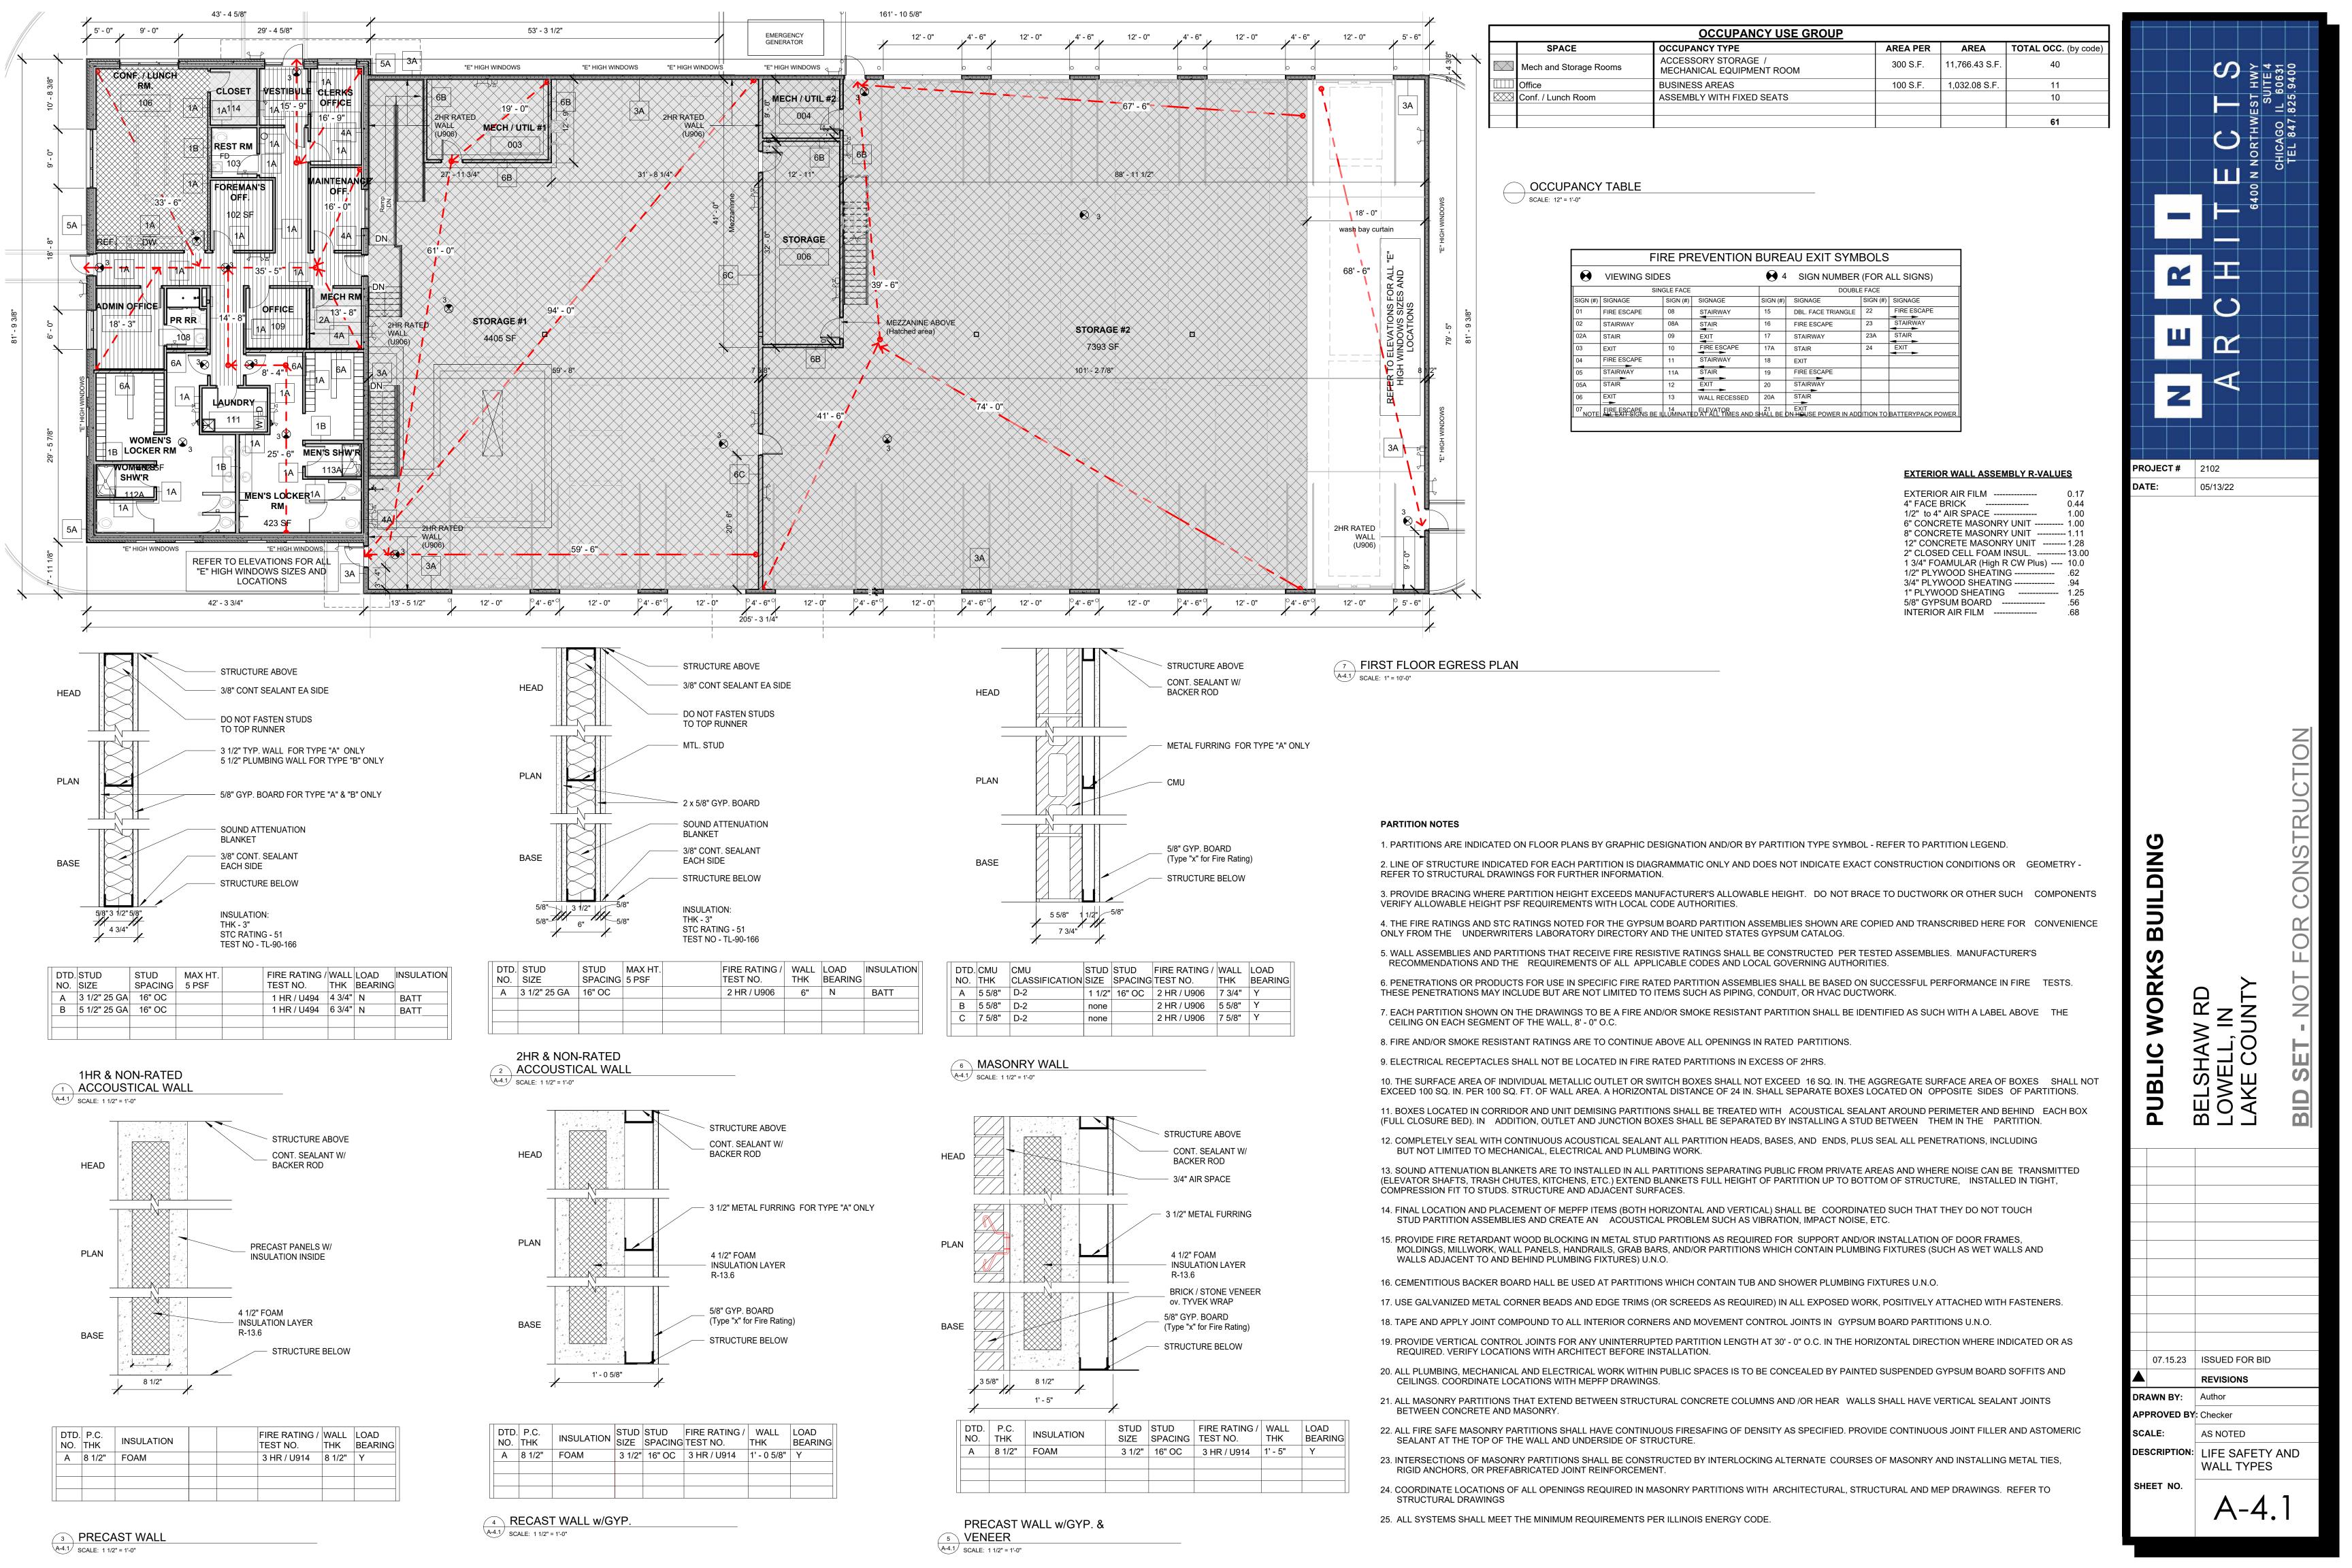

DOOR NOTES:

DOOR HARDWARE TO BE REVIEWED BY ARCHITECT, OWNER AND GENERAL CONTRACTOR BEFORE ORDERING.
 CONTRACTOR TO USE THE ARCHITECT'S DOOR TYPE PLAN DESIGNATION IN ADDITION TO THE ROOM NUMBER ON ALL SHOP DRAWING SCHEDULE SUBMITTALS.
 DOOR THICKNESS SHALL BE 1 3/4" TYP. UNO.
 ALL DOORS LEADING INTO HAZARDOUS ROOMS OR SPACES TO HAVE KNURLED HARDWARE AND FULLY GASKETED.
 GLAZING AT LABELED DOORS TO BE FIRE-RESISTIVE, PROVIDE SAFETY GLAZING AT ALL NON-RATED DOORS.
 GLAZING IN ALL EXTERIOR DOORS AND WINDOWS ARE TO COMPLY WITH 140 MPH WIND LOADS & IMPACT CODES
 ALL UNIT ENTRY DOORS TO BE SMOKE / DRAFT CONTROL DOORS.

8. ALL EXTERIOR, OPAQUE, SWINGING DOORS TO HAVE A U-FACTOR ≤ 0.37.
9. ALL EXTERIOR, OPAQUE, NON-SWINGING DOORS TO HAVE AN R FACTOR ≥ 4.75.
10. PROVIDE LEVER OPERATED HARDWARE THROUGHOUT THE BUILDING. NO DOOR KNOBS.

DOOR DESIGNATION SYMBOL:

FIRE RATING LEGEND A 3 HR. (CLASS A) B 90 MIN. (CLASS B) C 60 MIN. (CLASS B) D 45 MIN. (CLASS C) E 20 MIN. N NON RATED FIRE RATING DOOR TYPE DOOR TYPE DOOR HARDWARE SET

DOOR HARDWARE NOTE

DOOR HARDWARE SHALL BE CAPABLE OF OPERATION WITH THE USE OF ONE (1) HAND AND SHALL NOT REQUIRE TIGHT PINCHING, TIGHT GRASPING OR TWISTING OF THE WRIST TO OPERATE. THUMB-TURN DEADBOLTS ARE PROHIBITED; LEVER OR PADDLE DEADBOLT RELEASES ARE ACCEPTABLE, DOOR THRESHOLD SHALL NOT EXCEED ONE-HALF INCH (1/2 ") IN HEIGHT, THRESHOLDS EXCEEDING ONE-QUARTER INCH (1/4") IN HEIGHT SHALL HAVE A 1:2 BEVEL. DOOR CLOSERS SHALL MEET OPENING FORCE AND SWEEP PERIOD REQUIREMENTS. "SECTION: IAC 400.310 J) 7), 9), 9), 10)


A R C H I T E C T S

6400 N NORTHWEST HWY
SUITE 4
CHICAGO IL 60631
TEL 847.825.9400

PROJECT#	2102
DATE:	05/13/22


PUBLIC WORKS BUILDING
BELSHAW RD
LOWELL, IN

BELSHAW RE LOWELL, IN LAKE COUNT

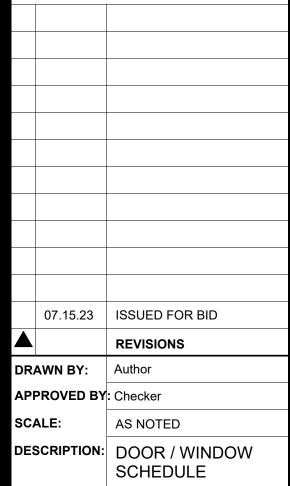


A-6.0

SHEET NO.

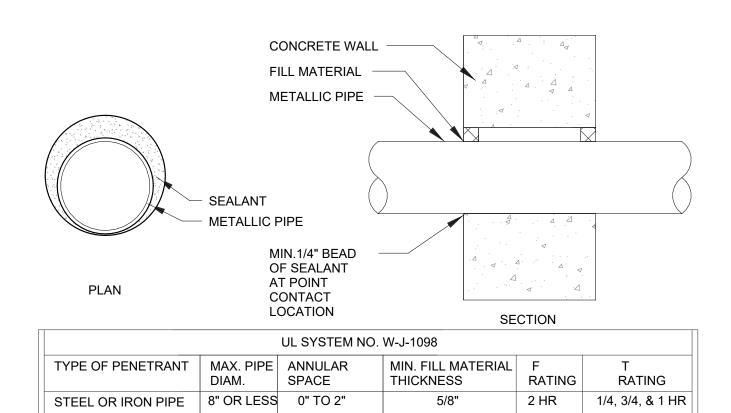


FILL MATERIAL: SPECIFIED TECHNOLOGIES-SPECSEAL LCI SEALANT

4" OR LESS 0" TO 2"

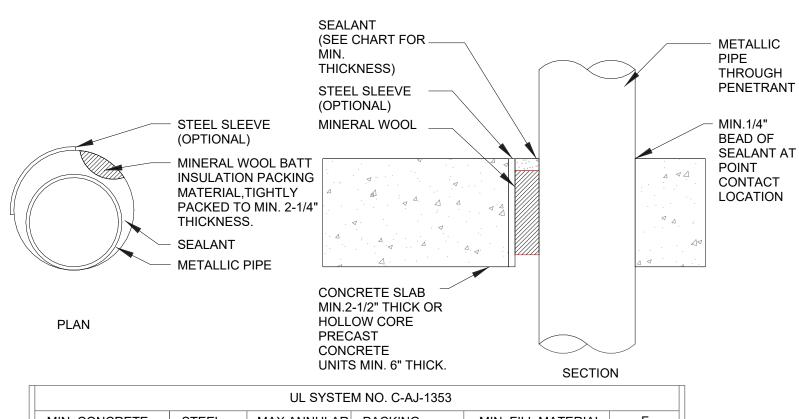

2 HR 1/4, 3/4, & 1 HR

MIN. CONCRETE STEEL MAX ANNULAR PACKING MIN. FILL MATERIAL RATING THICKNESS SLEEVE SPACE MATERIAL THICKNESS OPTIONAL 2-1/2" REQUIRED 3 HR 2 HR OPTIONAL 1/2" 4-1/2" NO FILL MATERIAL: SPECIFIED TECHNOLOGIES-SPECSEAL LCI SEALANT

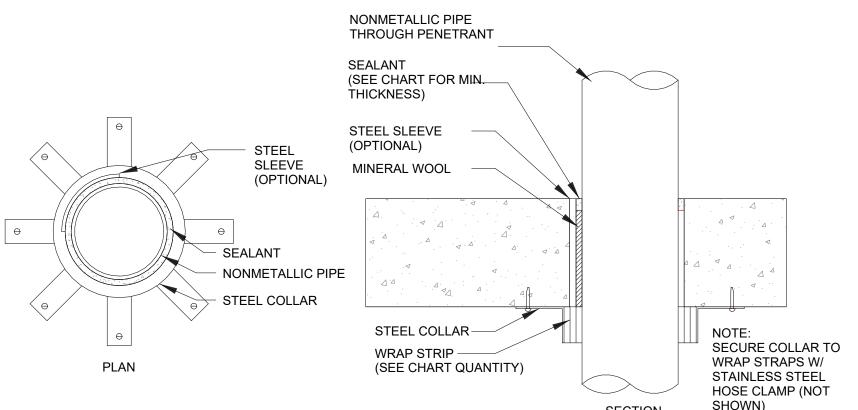

							SECTION	SHOWN)	
			l	JL SYSTEM NO. (C-AJ-2297				
PIPE TYPE	MAX PIPE DIAM.	MIN. CONCRETE THICKNESS	WRAP STRIP TYPE	MIN. NO. OF WRAP STRIP LAYERS	F RATING	T RATING	MIN. PACKING MATERIAL DEPTH	MIN. FILL MATERIAL DEPTH	MAX ANNULAF SPACE
PVC, ccPVC, CPVC, RNC, ABS, ccABS	2"	2-1/2"	RED, BLU OR BLU2	1	2	1	N/A	1/2"	1/16"
PVC, ccPVC, CPVC, RNC, ABS, ccABS	2"	2-1/2"	RED, BLU OR BLU2	1	2	1	2"	1/2"	3/14"
PVC, ccPVC, CPVC, RNC, ABS, ccABS	4"	2-1/2"	RED, BLU OR BLU2	2	2	1	2"	1/2"	3/14"
PVC, ccPVC, CPVC, RNC,	2"	4-1/2"	RED, BLU OR BLU2	1	3	2	N/A	1/4"	1/4"
PVC, ccPVC, CPVC, RNC,	3"	4-1/2"	RED, BLU OR BLU2	2	3	2	N/A	1/4"	1/4"
PVC, ccPVC, CPVC, RNC,	4"	4-1/2"	RED, BLU OR BLU2	3	3	2	N/A	1/4"	1/4"
PVC, ccPVC, CPVC, RNC,	6"	4-1/2"	RED	3	3	0	N/A	1/4"	1/2"
PVC, ccPVC, CPVC, RNC,	6"	4-1/2"	BLU OR BLU2	3	3	2	N/A	1/4"	3/16"
ABS, ccABS	2"	4-1/2"	RED	1	3	0	N/A	1/4"	1/2"
ABS, ccABS	2"	4-1/2"	BLU OR BLU2	1	3	2	N/A	1/4"	1/2"
ABS, ccABS	3"	4-1/2"	RED	2	2	0	N/A	1/4"	1/2"
ABS, ccABS	3"	4-1/2"	BLU OR BLU2	2	3	2	N/A	1/4"	1/2"
ABS, ccABS	4"	4-1/2"	RED	3	2	0	N/A	1/4"	1/2"
ABS, ccABS	4"	4-1/2"	BLU OR BLU2	3	3	2	N/A	1/4"	1/2"
ABS, ccABS	6"	4-1/2"	RED	3	3	0	N/A	1/2"	3/8"
ABS, ccABS	6"	4-1/2"	BLU OR BLU2	3	3	3	N/A	1/2"	3/8"

FILL MATERIAL: SPECIFIED TECHNOLOGIES-SPECSEAL LCI SEALANT WRAP STRIP: SPECIFIED TECHNOLOGIES-SPECSEAL RED WRAP STRIP, SPECSEAL BLU WRAP STRIP

SPECSEAL BLU2 WRAP STRIP

FIRESTOPPING NOTES

ALL PENETRATIONS THROUGH FIRE RATED FLOOR, WALL & ROOF/CEILING ASSEMBLIES BY ELECTRICAL, MECHANICAL & PLUMBING CONDUITS, PIPES TUBES, ETC., SHALL BE PROPERLY FIRE STOPPED TO COMPLY WITH ASTM E119 REQUIREMENTS. PROVIDE THROUGH PENETRATION SYSTEMS AS SPECIFIED FOR THE FOLLOWING ASSEMBLIES.

HOLLOW CORE CONCRETE PLANK FLOOR ASSEMBLY

U.L. DES. NO. 64 - UP TO 2 HR. RATING

COMPONENTS 1. FIRE STOP WRAP STRIP AROUND PIPE/CONDUIT

2. FIRE RESTRICTING METAL COLLAR W/APPROPRIATE FASTENERS 3. FIRE STOP CAULK OR MOLDABLE PUTTY AROUND COLLAR

METAL PIPE U.L. DES. NO. 319 - UP TO 2 HR. FIRE RATING

1. MINERAL WOOL PACKED INOT ANNULAR SPACE 2. FIRESTOP CAULK EACH SIDE OF PENETRATION

NON METALLIC PIPE

SEALANT

SEALANT

THICKNESS)

THROUGH PENETRANT

(SEE CHART FOR MIN.

ROOF/CEILING ASSEMBLY PLASTIC PIPE

U.L. DES. NO. 451 (B) - UP TO 1 HR. FIRE RATING PROVIDE THE FOLLOWING COMPONENTS AT THE BOTTOM OF GYPSUM

1. FIRE STOP WRAP/STRIP AROUND PIPE/CONDUIT EACH SIDE OF

2. FIRE STOP CAULK OR MOLDABLE PUTTY EACH SIDE OF PENETRATION

CEILING & AT THE BOTTOM SIDE OF ROOF DECK 1. FIRE STOP WRAP/STRIP AROUND PIPE/CONDUIT

GYPSUM BOARD WALL ASSEMBLY

U.L. DES. NO. 148 (B) - UP TO 2 HR. FIRE RATING

U.L. DES. NO. 147 (A) - UP TO 2 HR. FIRE RATING

1. FIRE STOP CAULK EACH SIDE OF PENETRATION

PLASTIC PIPE

COMPONENTS:

PENETRATION

METAL PIPE

2. FIRE RESTRICTING METAL COLLAR W/ APPROPRIATE FASTENERS

3. FIRE STOP CAULK OR MOLDABLE PUTTY AROUND COLLAR

DECK PENETRATIONS STEEL SLEEVE STEEL DUCT (OPTIONAL) NOM. 8" DIA. OR SMALLER MINERAL WOOL STEEL SLEEVE -BATT SEALANT (OPTIONAL) INSULATION (SEE CHART FOR MINERAL WOOL-PACKING MIN. THICKNESS) MATERIAL, TIGHTLY PACKED TO MIN. 2-1/4" THICKNESS. -SEALANT · △ △. - STEEL DUCT CONCRETE SLAB MIN.2-1/2" THICK OR PLAN **HOLLOW CORE**

MASONRY WALL ASSEMBLY

COMPONENTS:

COMPONENTS:

COMPONENTS:

PLASTIC PIPE U.L. DES. NO. 562 - UP TO 2 HR. FIRE RATING

2. FIRE STOP EACH SIDE OF PENETRATION

METAL PIPE U.L. DES. NO. 161 - UP TO 2 HR. FIRE RATING

U.L. DES. NO.453 - UP TO 1 HR. FIRE RATING

2. FIRE STOP CAULK EACH SIDE OF PENETRATION

1. BACKER ROD PACKED AROUND PIPE EACH SIDE OF WALL

1. MINIMUM 3 DEPTH MINERAL WOOL BACKING PACKED INTO ANNULAR

1. PROVIDE FIRE STOP CAULK AROUND GYPSUM BOARD CEILING & ROOF


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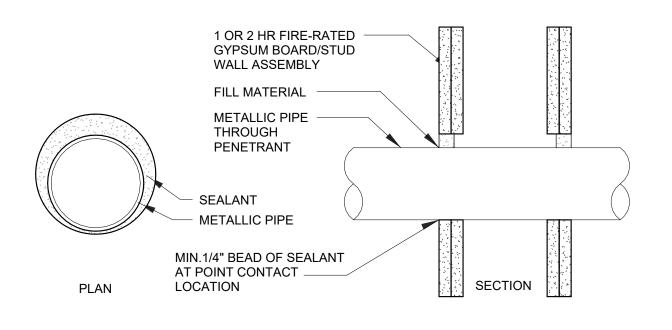
UL SYSTEM NO. C-AJ-7040											
MIN. CONCRETE THICKNESS											
4-1/2"	OPTIONAL	2" MAX	3"	1/2"	2 HR	1/4 HR					
FILL MATERIAL: SPE	FILL MATERIAL: SPECIFIED TECHNOLOGIES-SPECSEAL LCI SEALANT										

PRECAST CONCRETE

UNITS MIN. 6" THICK.


NON METALLIC PIPE SEALANT 2 OR 3 HR.RATED HOLLOW CORE PRECAST CONCRETE UNITS MIN. APPLIED TO OUTER 6" THICK. CIRCUMFERENCE OR WRAP PRIOR TO INSTALLATION SECTION WRAP STRIP UL SYSTEM NO. F-B-2014 MIN. HOLLOW CORE CONCRETE | PIPE DIAM. ANNULAR MIN. FILL MATERIAL RATING **UNIT THICKNESS** SPACE THICKNESS RATING 0 TO 2" 1/4 TO 5/16" 2 HR 3 HR 2 HR 1 HR 2" TO 3" 1/4 TO 5/16"



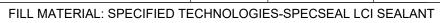


UL SYSTEM NO. W-L-1222											
TYPE OF PENETRANT	MAX. PIPE DIAM.	ANNULAR SPACE	MIN. FILL MATERIAL THICKNESS	F RATING	T RATING						
STEEL OR IRON PIPE, STEEL CONDUIT OR EMT	2"	0" TO 2"	5/8"	1&2 HR	1HR						
STEEL OR IRON PIPE, STEEL CONDUIT OR EMT	8"	0" TO 2"	5/8"	1&2 HR	3/4 HR						
COPPER PIPE OR TUBE	4"	0" TO 2"	5/8"	1&2 HR	1/4 HR						


FILL MATERIAL: SPECIFIED TECHNOLOGIES-SPECSEAL LCI SEALANT

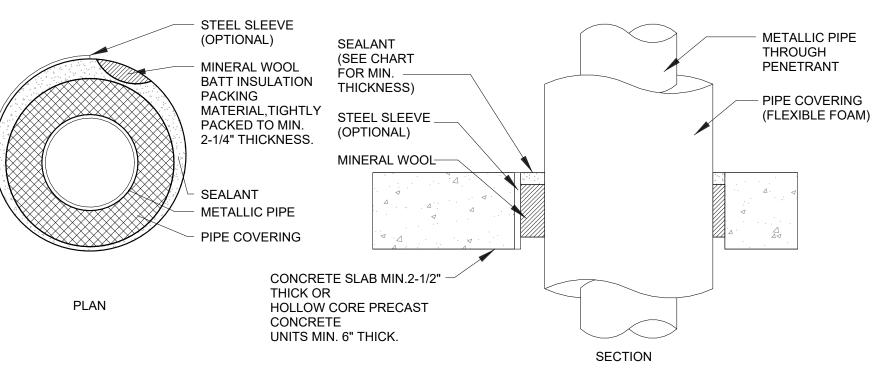


		ι	JL SYSTEM NO. C	:-AJ-5155			
MIN. CONCRETE THICKNESS	STEEL SLEEVE	PIPE COVERING THICKNESS	ANNULAR SPACE	MIN. PACKING MATERIAL THICKNESS	MIN. FILL MATERIAL THICKNESS	F RATING	T RATING
2-1/2"	YES	3/4"	1/4" TO 5/8"	1-1/2"	1"	2 HR	3/4 HR
4-1/2"	YES	3/4"	1/4" TO 5/8"	3"	1"	2 HR	3/4 HR
4-1/2"	NO	1/2"	0 TO 2"	3"	1/2"	2 HR	3/4 HR
4-1/2"	YES	1/2"	1/4" TO 1-5/8"	3"	1/2"	2 HR	3/4 HR

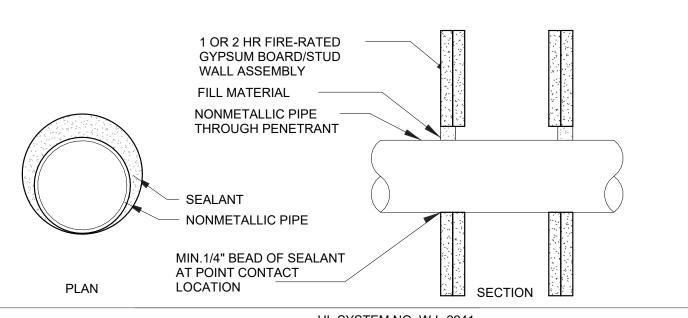


UL SYSTEM NO. W-L-2241						
TYPE OF PENETRANT	MAX. PIPE DIAM.	ANNULAR SPACE	MIN. FILL MATERIAL THICKNESS	F RATING	T RATING	
POLYVINYL CHLORIDE (PVC) PIPE	2"	0" TO 1"	5/8"	1&2 HR	1/4 HR	
CHLORINATED POLYVINYL CHLORIDE (CPVC) PIPE	2"	0" TO 1"	5/8"	1&2 HR	1/4 HR	
RIGID NONMETALLIC CONDUIT	2"	0" TO 1"	5/8"	1&2 HR	1HR OR 1-3/4HR	
ELECTRICAL NONMETALLIC TUBING	2"	0" TO 1"	5/8"	1&2 HR	1HR OR 1-3/4HR	
CROSS LINKED POLYETHYLENE (PEX) TUBING	1"	0" TO 1"	5/8"	1&2 HR	1HR OR 1-3/4HR	
ACRYLONITRILE BUTADIENE STYRENE (ABS) PIPE	1-1/2"	1/4" TO 3/4"	5/8"	1&2 HR	0HR	

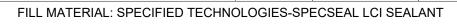

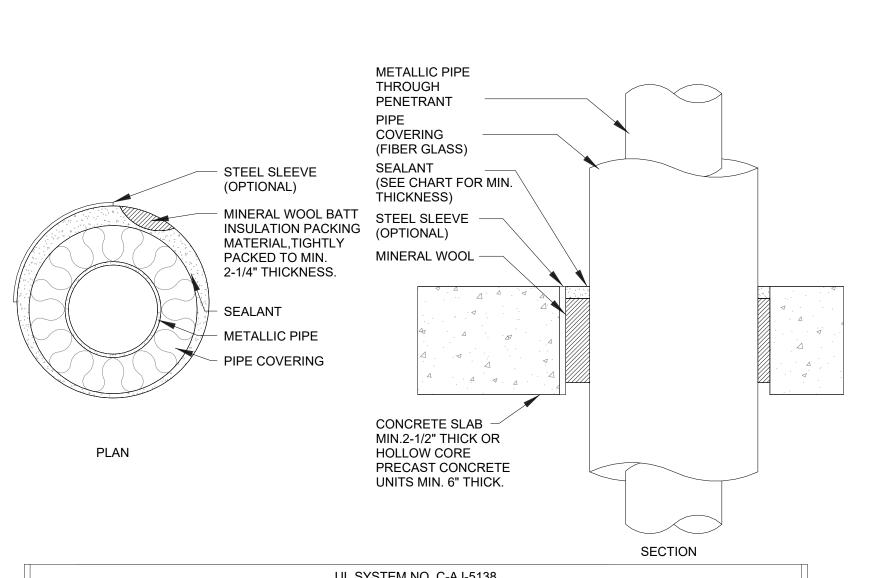

UL SYSTEM NO. C-AJ-5138							
MIN. CONCRETE THICKNESS	STEEL SLEEVE	MAX ANNULAR SPACE	MIN. PACKING MATERIAL DEPTH	MIN. FILL MATERIAL THICKNESS	F RATING	T RATING W/ SLEEVE	T RATING W/OUT SLEEVE
2-1/2"	OPTIONAL	1/4 " TO 5/8"	1-1/2"	1"	2 HR	3/4 HR	3/4 HR
4-1/2"	OPTIONAL	1/4 " TO 5/8"	3"	1/2"	2 HR	3/4 HR	1 HR
FILL MATERIAL: SPECIFIED TECHNOLOGIES-SPECSEAL LCI SEALANT							

FILL MATERIAL: SPECIFIED TECHNOLOGIES-SPECSEAL LCI SEALANT

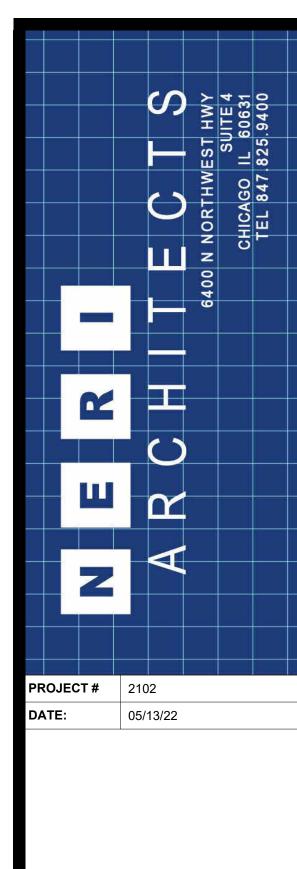

MICDIN


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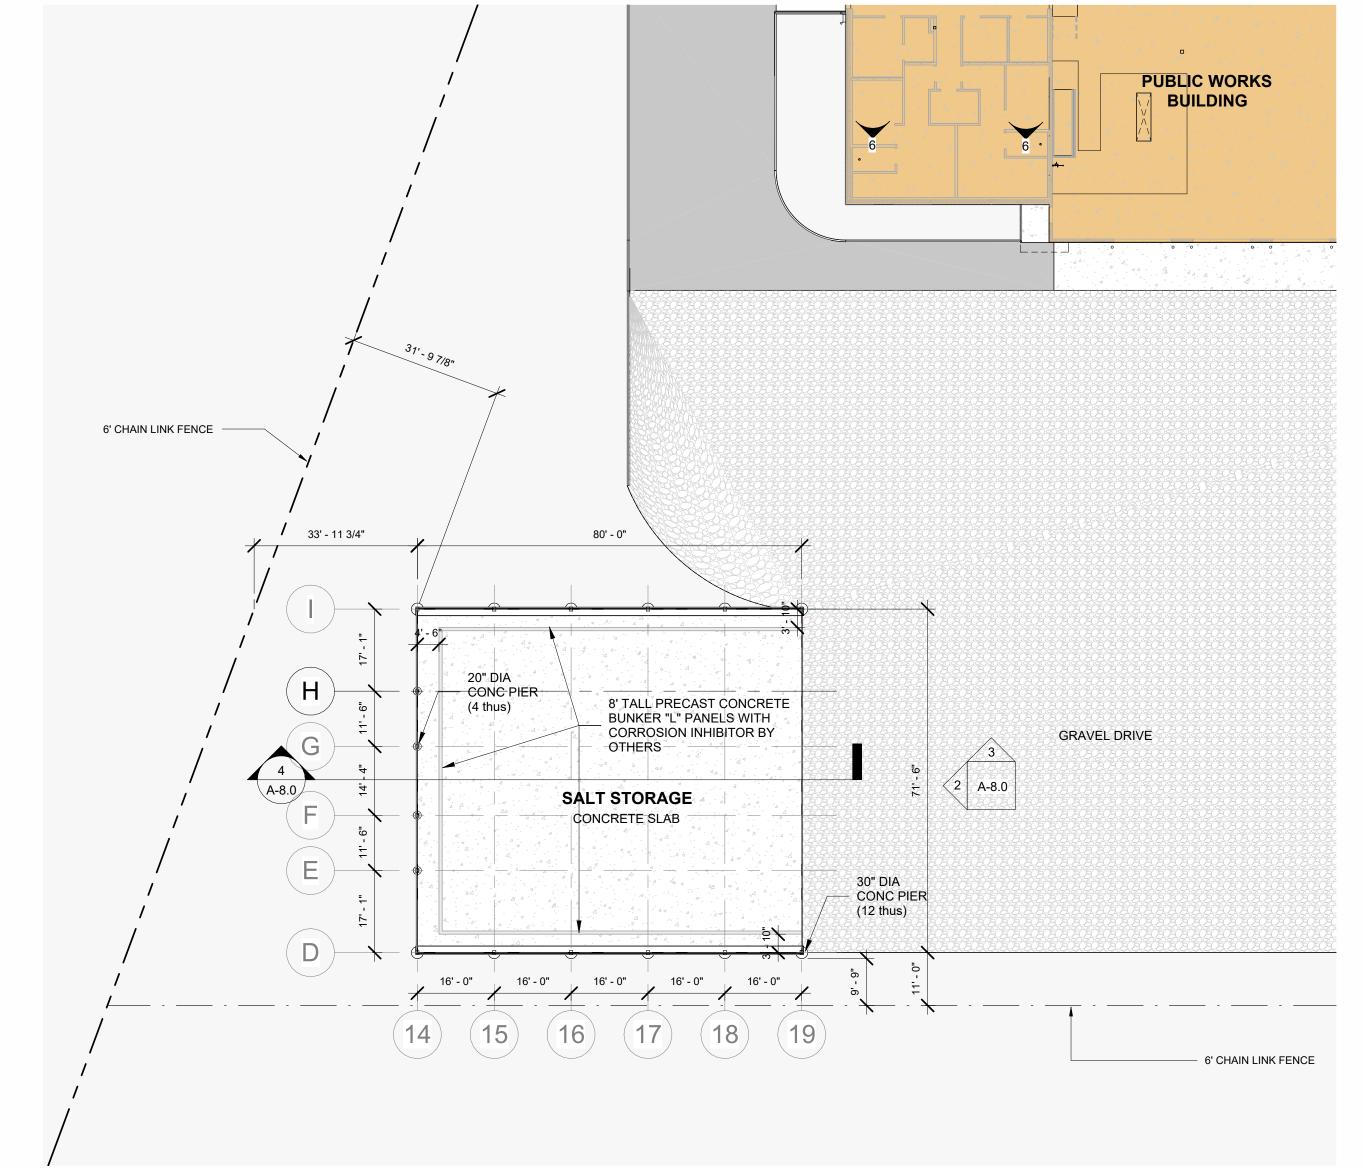
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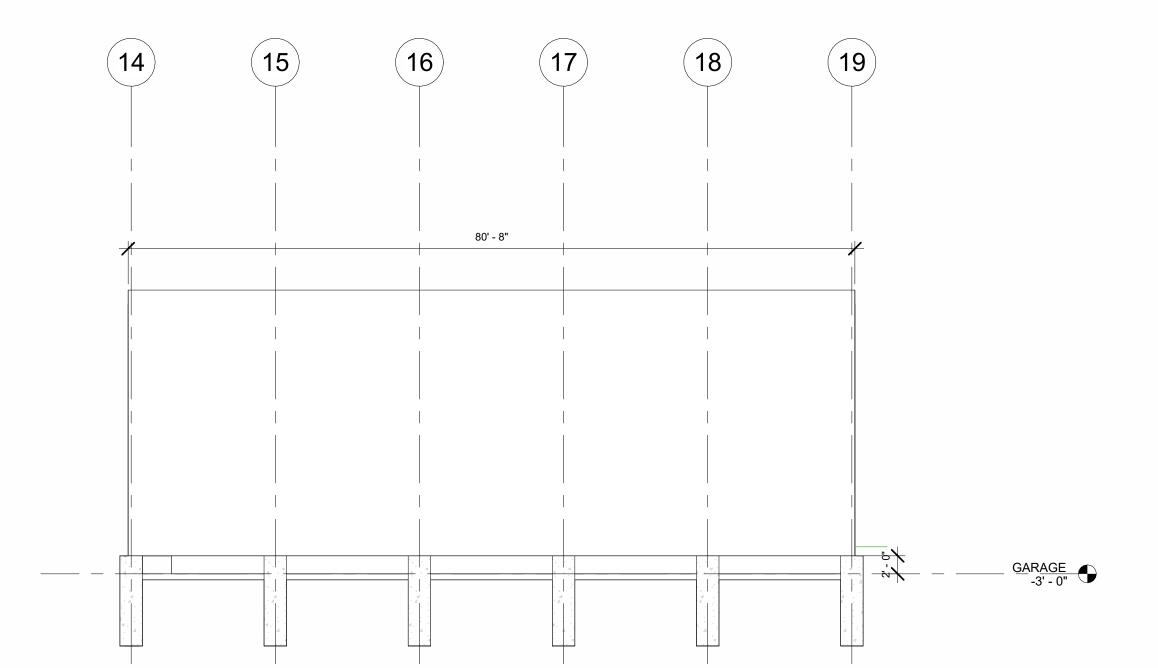
SHEET NO.


07.15.23 | ISSUED FOR BID REVISIONS DRAWN BY: RAM APPROVED BY: GCN / MAM

AS NOTED DESCRIPTION: FIRESTOPPING **DETAILS**





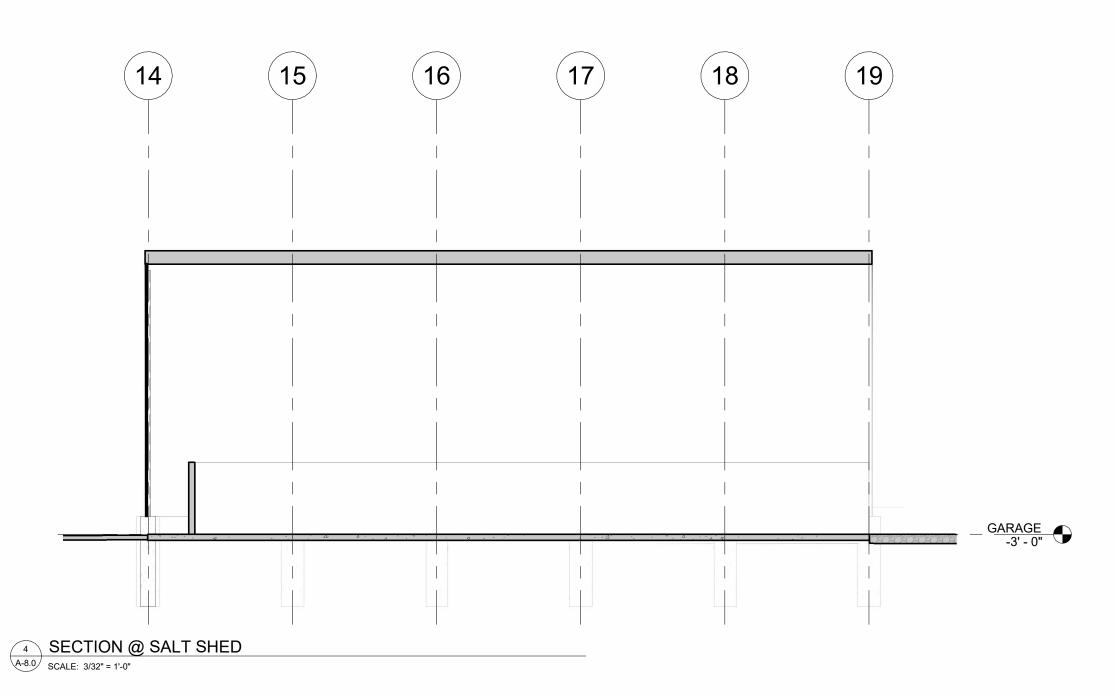

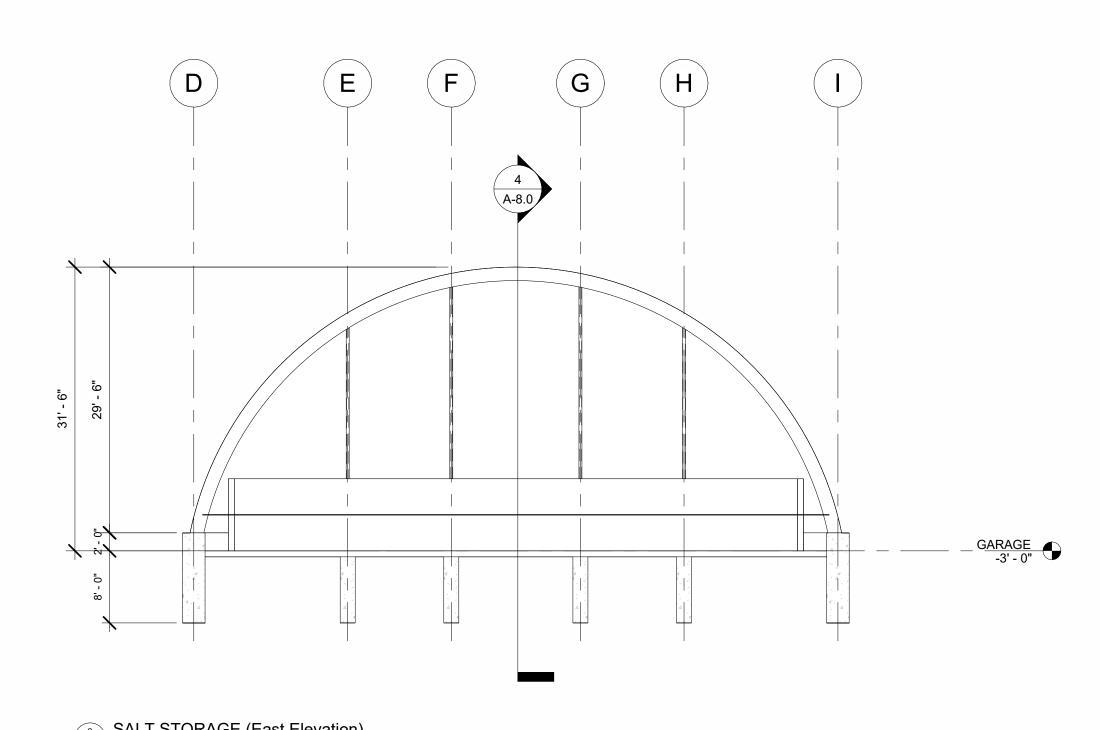

3 SALT STORAGE (South Elevation)
SCALE: 3/32" = 1'-0"

2 SALT STORAGE (East Elevation)
SCALE: 3/32" = 1'-0"

SALT SHED (SITE - Blow-up)

SCALE: 1" = 20'-0"

PROJECT # 2102 05/13/22 BID SET - NOT FOR CONSTR PUBLIC WORKS BUILDING BELSHAW RD LOWELL, IN LAKE COUNTY 07.15.23 ISSUED FOR BID **REVISIONS** DRAWN BY: RAM APPROVED BY: GCN / MAM AS NOTED DESCRIPTION: ACCESSORY STRUCTURE

SHEET NO.

A-8.0

	DRAWING INDEX
S-101	GENERAL NOTES, SECTIONS AND DETAILS
S-201	FOUNDATION PLAN

GENERAL NOTES:

THE FOLLOWING NOTES SHALL APPLY UNLESS OTHERWISE SHOWN OR NOTED ON THE

- 1. DESIGN AND CONSTRUCTION SHALL BE IN ACCORDANCE WITH CITY OF LOWELL BUILDING CODE, LATEST EDITION.
- 2. THE CONTRACTOR SHALL VERIFY ALL DIMENSIONS IN THE FIELD PRIOR TO COMMENCING WORK. THE ENGINEER SHALL BE NOTIFIED OF ANY DISCREPANCIES WHICH MAY EXIST.
- 3. INSPECTIONS SHALL BE MADE ON ALL MATERIALS AND PROCESSES AS SPECIFIED
- A. CONCRETE HAVING A STRENGTH IN EXCESS OF 2000 PSI B. WELDING
- 4. MATERIAL TESTS SHALL BE MADE AS SPECIFIED. CONCRETE TEST CYLINDERS SHALL BE MADE FOR ALL CONCRETE. TEST RESULTS SHALL BE DETERMINED BY THE TESTING LABORATORY.
- 5. DETAILS, SECTIONS AND NOTES SHOWN ON THIS DRAWING ARE INTENDED TO BE TYPICAL AND SHALL APPLY TO SIMILAR SITUATIONS ELSEWHERE, UNLESS OTHERWISE SHOWN.
- 6. CONTRACTOR SHALL FURNISH ALL NECESSARY BRACING REQUIRED TO PROPERLY CONSTRUCT THE STRUCTURE. ALL BRACING TO BE DESIGNED AND SEALED BY A LICENSED STRUCTURAL ENGINEER. SUBMIT BRACING / SHORING DRAWINGS TO THE ENGINEER OF RECORD FOR APPROVAL PRIOR TO PROCEEDING. FOUNDATION WALLS SHALL REMAIN LATERALLY BRACED UNTIL FIRST FLOOR IS FULLY CONSTRUCTED.
- DO NOT SCALE DRAWINGS.
- 8. CONTRACTOR SHALL RELY ONLY ON WRITTEN COMMUNICATION WHEN COMMUNICATING WITH THE EOR. EOR WILL NOT PROVIDE ANY INFORMATION

DESIGN LOADS:

FOUNDATION PIERS WERE DESIGNED FOR THE COLUMN LOADS PROVIDED BY THE BUILDING MANUFACTURER. DESIGN LOADS ARE NOT CALCULATED BY ANAX ENGINEERING, INC. SEE BELOW.

MATERIALS:

- CONCRETE:
- A. CONCRETE STRENGTHS AT 28 DAYS SHALL BE AS FOLLOWS:
- A.1. GRADE SLABS
- A.2. FOOTINGS F'c = 4000 PSI
- A.3. FOUNDATION WALLS F'c = 4000 PSI
- B. AIR ENTRAINMENT SHALL BE USED IN ALL CONCRETE EXCEPT CAISSONS AND FOOTINGS.

F'c = 4000 PSI

- C. CONCRETE MIX DESIGNS SHALL BE PREPARED BY AN APPROVED TESTING LABORATORY. MIX DESIGNS SHALL BE SUBMITTED TO THE ENGINEER FOR APPROVAL BEFORE USE.
- D. FINE AND COARSE AGGREGATES SHALL BE STONE AGGREGATES CONFORMING TO ASTM C33.
- E. PORTLAND CEMENT SHALL BE TYPE I OR III CONFORMING TO ASTM C150. F. THE WATER-CEMENT RATIO FOR BEAMS AND SLABS SHALL NOT EXCEED 0.40. SUPERPLASTICIZERS MAY BE USED.
- 2. REINFORCEMENT:
- A. REINFORCING STEEL SHALL CONFORM TO ASTM 615 (60,000 PSI YIELD) FOR BEAMS, SLABS AND WALLS.
- B. WELDED WIRE FABRIC USED FOR SLAB ON GRADE CONSTRUCTION SHALL CONFORM TO ASTM A884 FOR WELDED WIRE EPOXY COATED.

SUBMIT ALL SHOP DRAWINGS TO THE ENGINEER FOR REVIEW AND GENERAL CONFORMANCE TO THE CONSTRUCTION DOCUMENTS. REINFORCING STEEL SHOP SHALL BE SUBMITTED TO THE EOR FOR APPROVAL. DO NOT BEGIN FABRICATION OF THE STEEL REBARS UNTIL ALL SHOP DRAWINGS HAVE BEEN APPROVED BY THE EOR. PRIOR TO SUBMISSION TO THE ENGINEER, THE GENERAL CONTRACTOR SHALL REVIEW AND APPROVE ALL SHOP DRAWINGS. AN APPROVAL STAMP OF THE SHOP DRAWINGS IS REQUIRED. GC SHALL REVIEW AND APPROVE ALL DIMENSIONS, QUANTITIES AND CONTRACTIBILITY ASPECTS.

FOUNDATION NOTES:

- 1. NO SOIL INVESTIGATION HAS BEEN PERFORMED BY ANAX ENGINEERING, INC. THE BEARING CAPACITY USED FOR THE FOUNDATION DESIGN IS 3.0 KSF AS PER GEOTECHNICAL REPORT PREPARED BY ADVANCED ENGINEERING SERVICES DATED 12/24/20. THE BEARING VALUE SHALL BE VERIFIED IN THE FIELD BY A QUALIFIED TESTING AGENCY PRIOR TO CONSTRUCTION PROCEDURE.
- 2. THE OWNER SHALL PROVIDE THE SERVICES OF A GEOTECHNICAL ENGINEER TO VERIFY THE SOIL BEARING CAPACITIES AT THE BOTTOM OF THE FOOTINGS IF LESSER BEARING VALUES ARE ENCOUNTERED AT THE REQUIRED ELEVATIONS, THE CONTRACTOR SHALL NOTIFY THE ENGINEER BEFORE THE PROCEEDING WITH THE PLACEMENT OF FOUNDATIONS.
- 3. FOOTINGS SHALL BE PLACED ON UNDISTURBED SOIL OR COMPACTED GRANULAR FILL. THE MINIMUM DEPTH FOR FOOTINGS SHALL BE 3'-6" BELOW GRADE, UNLESS SHOWN OTHERWISE ON THE DRAWINGS.
- 4. THE CONTRACTOR IS RESPONSIBLE FOR THE DESIGN, INSTALLATION AND REMOVAL OF ALL EXCAVATION SUPPORT SYSTEMS.

REINFORCED CONCRETE NOTES:

- 1. REINFORCED CONCRETE WORK SHALL BE IN ACCORDANCE WITH "BUILDING CODE REQUIREMENTS FOR REINFORCED CONCRETE", ACI 318 LATEST EDITION.
- 2. CONCRETE SHALL NOT BE DROPPED THROUGH REINFORCING STEEL (AS IN WALLS) SO AS TO CAUSE SEGREGATION OF AGGREGATES. IN SUCH CASES, HOPPERS OR VERTICAL CHUTES OR TRUNKS SHALL BE USED. CHUTES OR TRUNKS SHALL BE OF VARIABLE LENGTHS SO THAT THE FREE UNCONFINED FALL OF CONCRETE SHALL NOT EXCEED SIX (6) FEET AND A SUFFICIENT NUMBER OF CHUTES OR TRUNKS SHALL BE USED TO INSURE THAT THE CONCRETE IS KEPT LEVEL AT ALL TIMES.
- 3. ALL DIMENSIONS SHOWN FOR LOCATIONS OF REINFORCING ARE TO BE TAKEN FROM THE FACE OF MAIN BARS AND DENOTE CLEAR MIN. COVERAGE. FOR BEAMS AND TIED COLUMNS, DIMENSIONS ARE TO MAIN BARS. UNLESS SPECIFICALLY NOTED, CONCRETE COVERAGES TO REINFORCING STEEL (NOT PRESTRESSING STEEL) SHALL BE AS FOLLOWS:
- A. 3" WHERE CONCRETE IS DEPOSITED DIRECTLY AGAINST GROUND (EXCEPT
- B. 2" WHERE CONCRETE IS EXPOSED TO GROUND, BUT PLACED IN FORMS. C. 2" TO MAIN BARS OF TIED COLUMNS.
- A. 1-1/2" TO WALL BARS, UNLESS NOTED OTHERWISE.
- E. 1" TO BOTTOM BARS AND 2" TO TOP BARS IN SLABS IN FORMS.
- F. 2" TO BARS IN SLABS ON GRADE. G. 2" TO MAIN BARS OF BEAMS.
- 4. THE SPLICES IN ADJACENT BARS SHALL NOT BE LESS THAN FIVE (5') FEET APART. VERTICAL WALL BARS SHALL BE SPLICED AT OR NEAR FLOOR LINES. BARS MAY BE WIRED TOGETHER AT SPLICES OR LAPS EXCEPT FOR TOP REINFORCING OF BEAMS AND SLABS OR WHERE DEFINITELY DETAILED TO BE SEPARATED. SEE BEAM DETAILS OR SCHEDULES FOR SEPARATION OF BEAM OR GIRDER BARS OVER SUPPORTS. CONTINUOUS BARS IN SPANDRELS, WALL BEAMS, ETC., SHALL LAP AS FOLLOWS:
- A. TOP BARS AT CENTER LINE OF SPAN.

OPENINGS FOR ELECTRICAL EQUIPMENT.


LATEST EDITION.

B. BOTTOM BARS AT CENTER LINE OF SUPPORTS. 5. SEE ARCHITECTURAL AND MECHANICAL DRAWINGS FOR THE SIZE AND LOCATION OF WALL AND FLOOR OPENINGS, WALL OFFSETS, PROVISIONS FOR FUTURE EQUIPMENT, STAIR DETAILS, PIPE, VENT, DUCT AND OTHER OPENINGS AND DETAILS NOT SHOWN


ON STRUCTURAL DRAWINGS. SEE ELECTRICAL DRAWINGS FOR SUPPORTS AND

- 6. REINFORCING STEEL DETAILS SHALL BE IN ACCORDANCE WITH THE MANUAL OF STANDARD PRACTICE FOR DETAILING REINFORCED CONCRETE STRUCTURES, ACI
- THE MINIMUM REINFORCEMENT FOR WALLS SHALL BE AS PER ACI 318 CHAPTER 14, SECTION 14.3, UNLESS NOTED OTHERWISE.
- 8. THE MINIMUM TEMPERATURE REINFORCEMENT SHALL BE AS PER ACI 318 CHAPTER 7, SECTION 7.12 UNLESS NOTED OTHERWISE.

	LAP SPLICE SCHEDULE (APPLIES TO REINF. CONC. & MASONRY)					
BAR SIZE	CLASS "B" SPLICE					
#4	33					
#5	41					
#6	48					
#7	70					
#8	81					

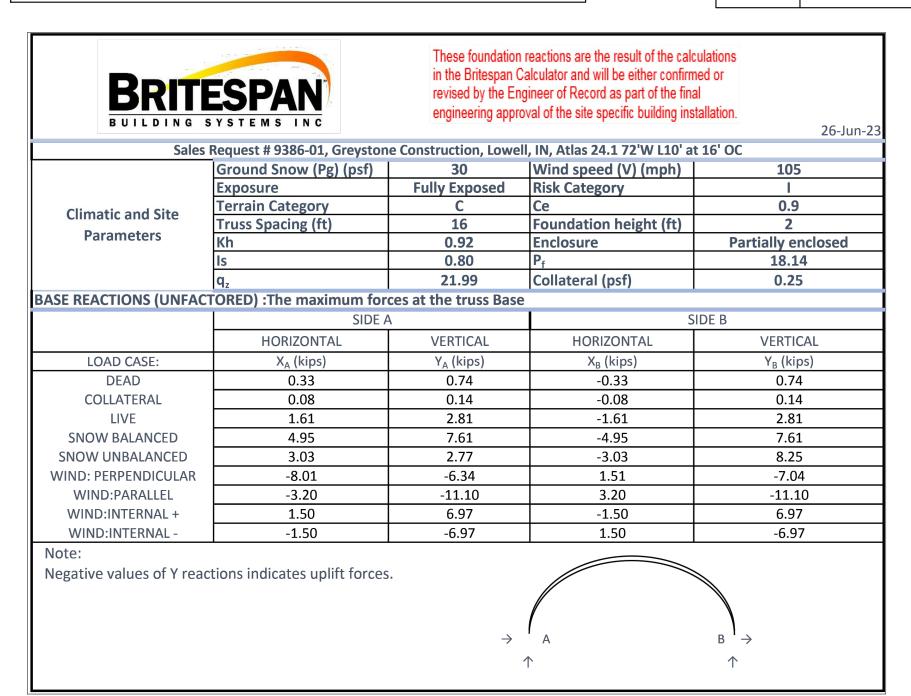

FRAME REACTIONS AS PROVIDED BY MANUF. - NOT BY ANAX ENGINEERING Scale: No Scale

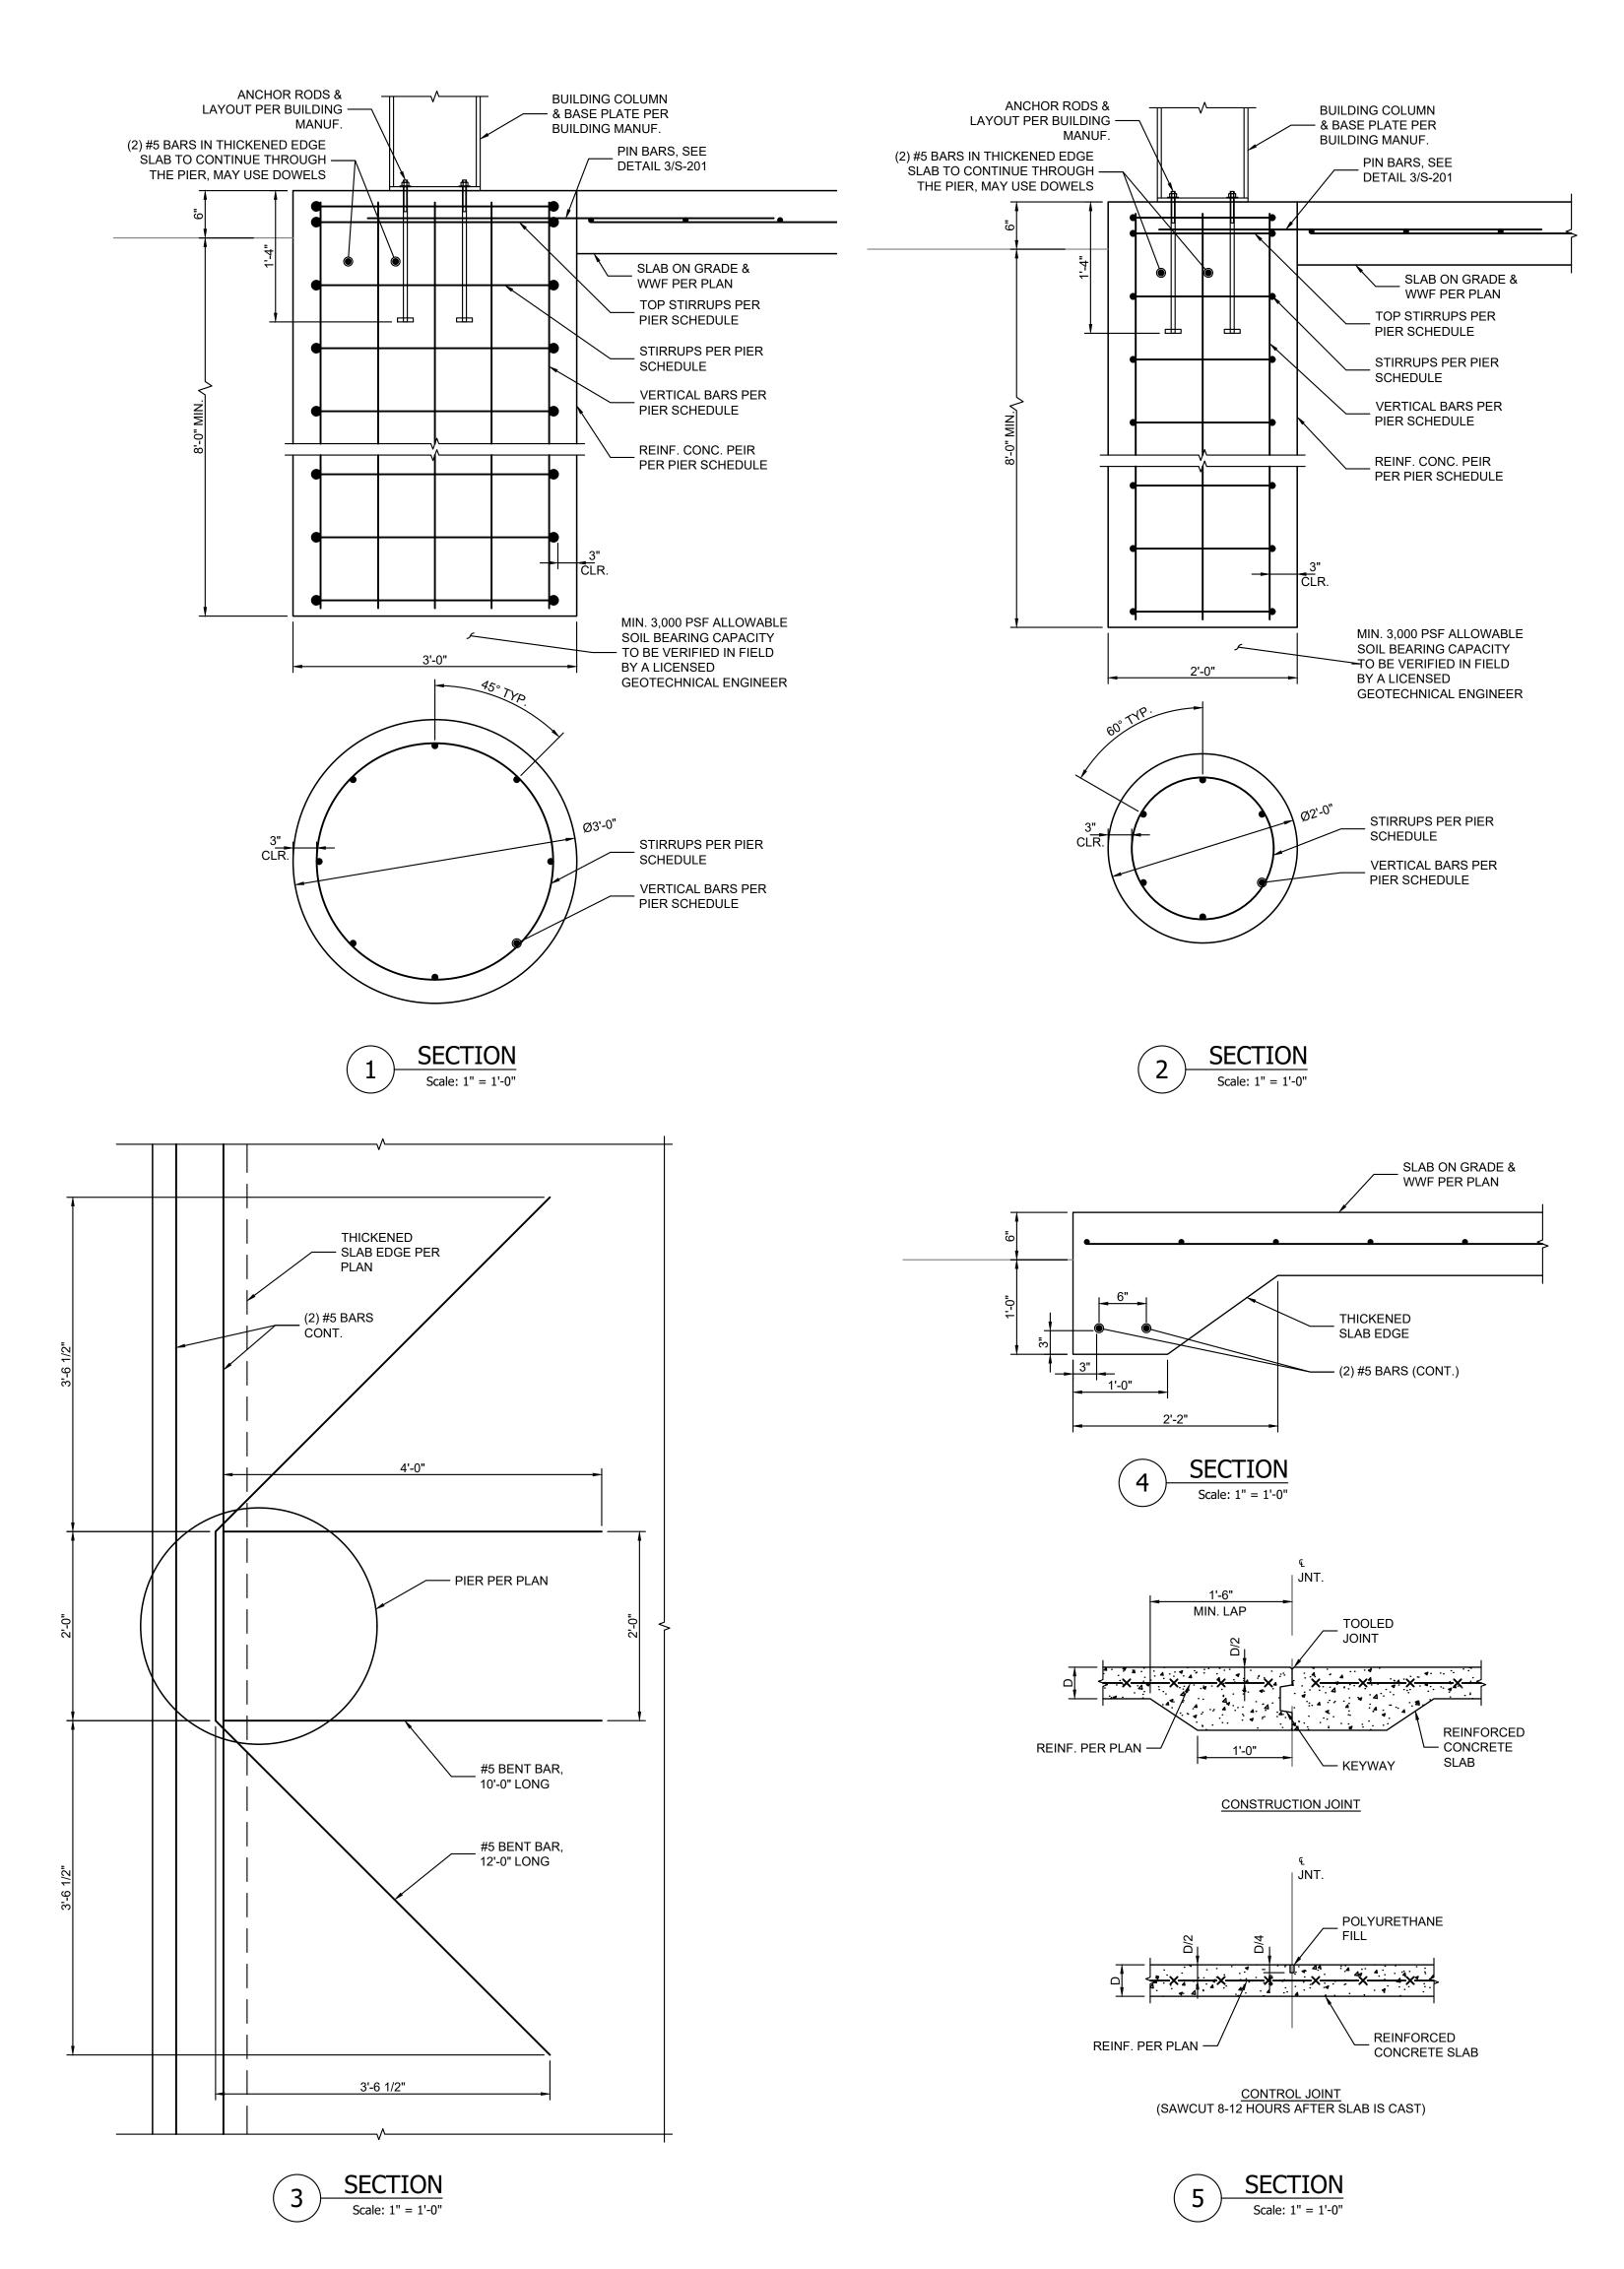

ANAX ENGINEERING, INC.

 Δ STRUCTURAL ENGINEERS Δ

122 S. MICHIGAN AVE., SUITE 1390 CHICAGO, IL 60603

PHONE: 847-461-9006

EMAIL: INFO@ANAXENG.COM

SHEET REVISIONS:

WWW.ANAXENGINEERING.COM

No. DATE NATURE OF REVISION

- 7-26-23 ISSUED FOR PERMIT

STATEMENT OF COMPLIANCE

have prepared, or caused to be

prepared under my supervision, the

attached plans and specifications

and state that, to the best of my knowledge and belief and to the extent of my contractual obligation, they are in compliance with the

applicable Codes and Ordinances.

Signature Date: 7-26-2023 License Expires: 07-31-2024

PROJECT No.: 23021

Public Works Salt

Storage Foundation

Lake County

Lowell, IN

ISSUED FOR PERMIT

GENERAL NOTES.


SECTIONS AND DETAILS

S-101 A

PROJECT NAME:

SHEET NAME:

SHEET No.:

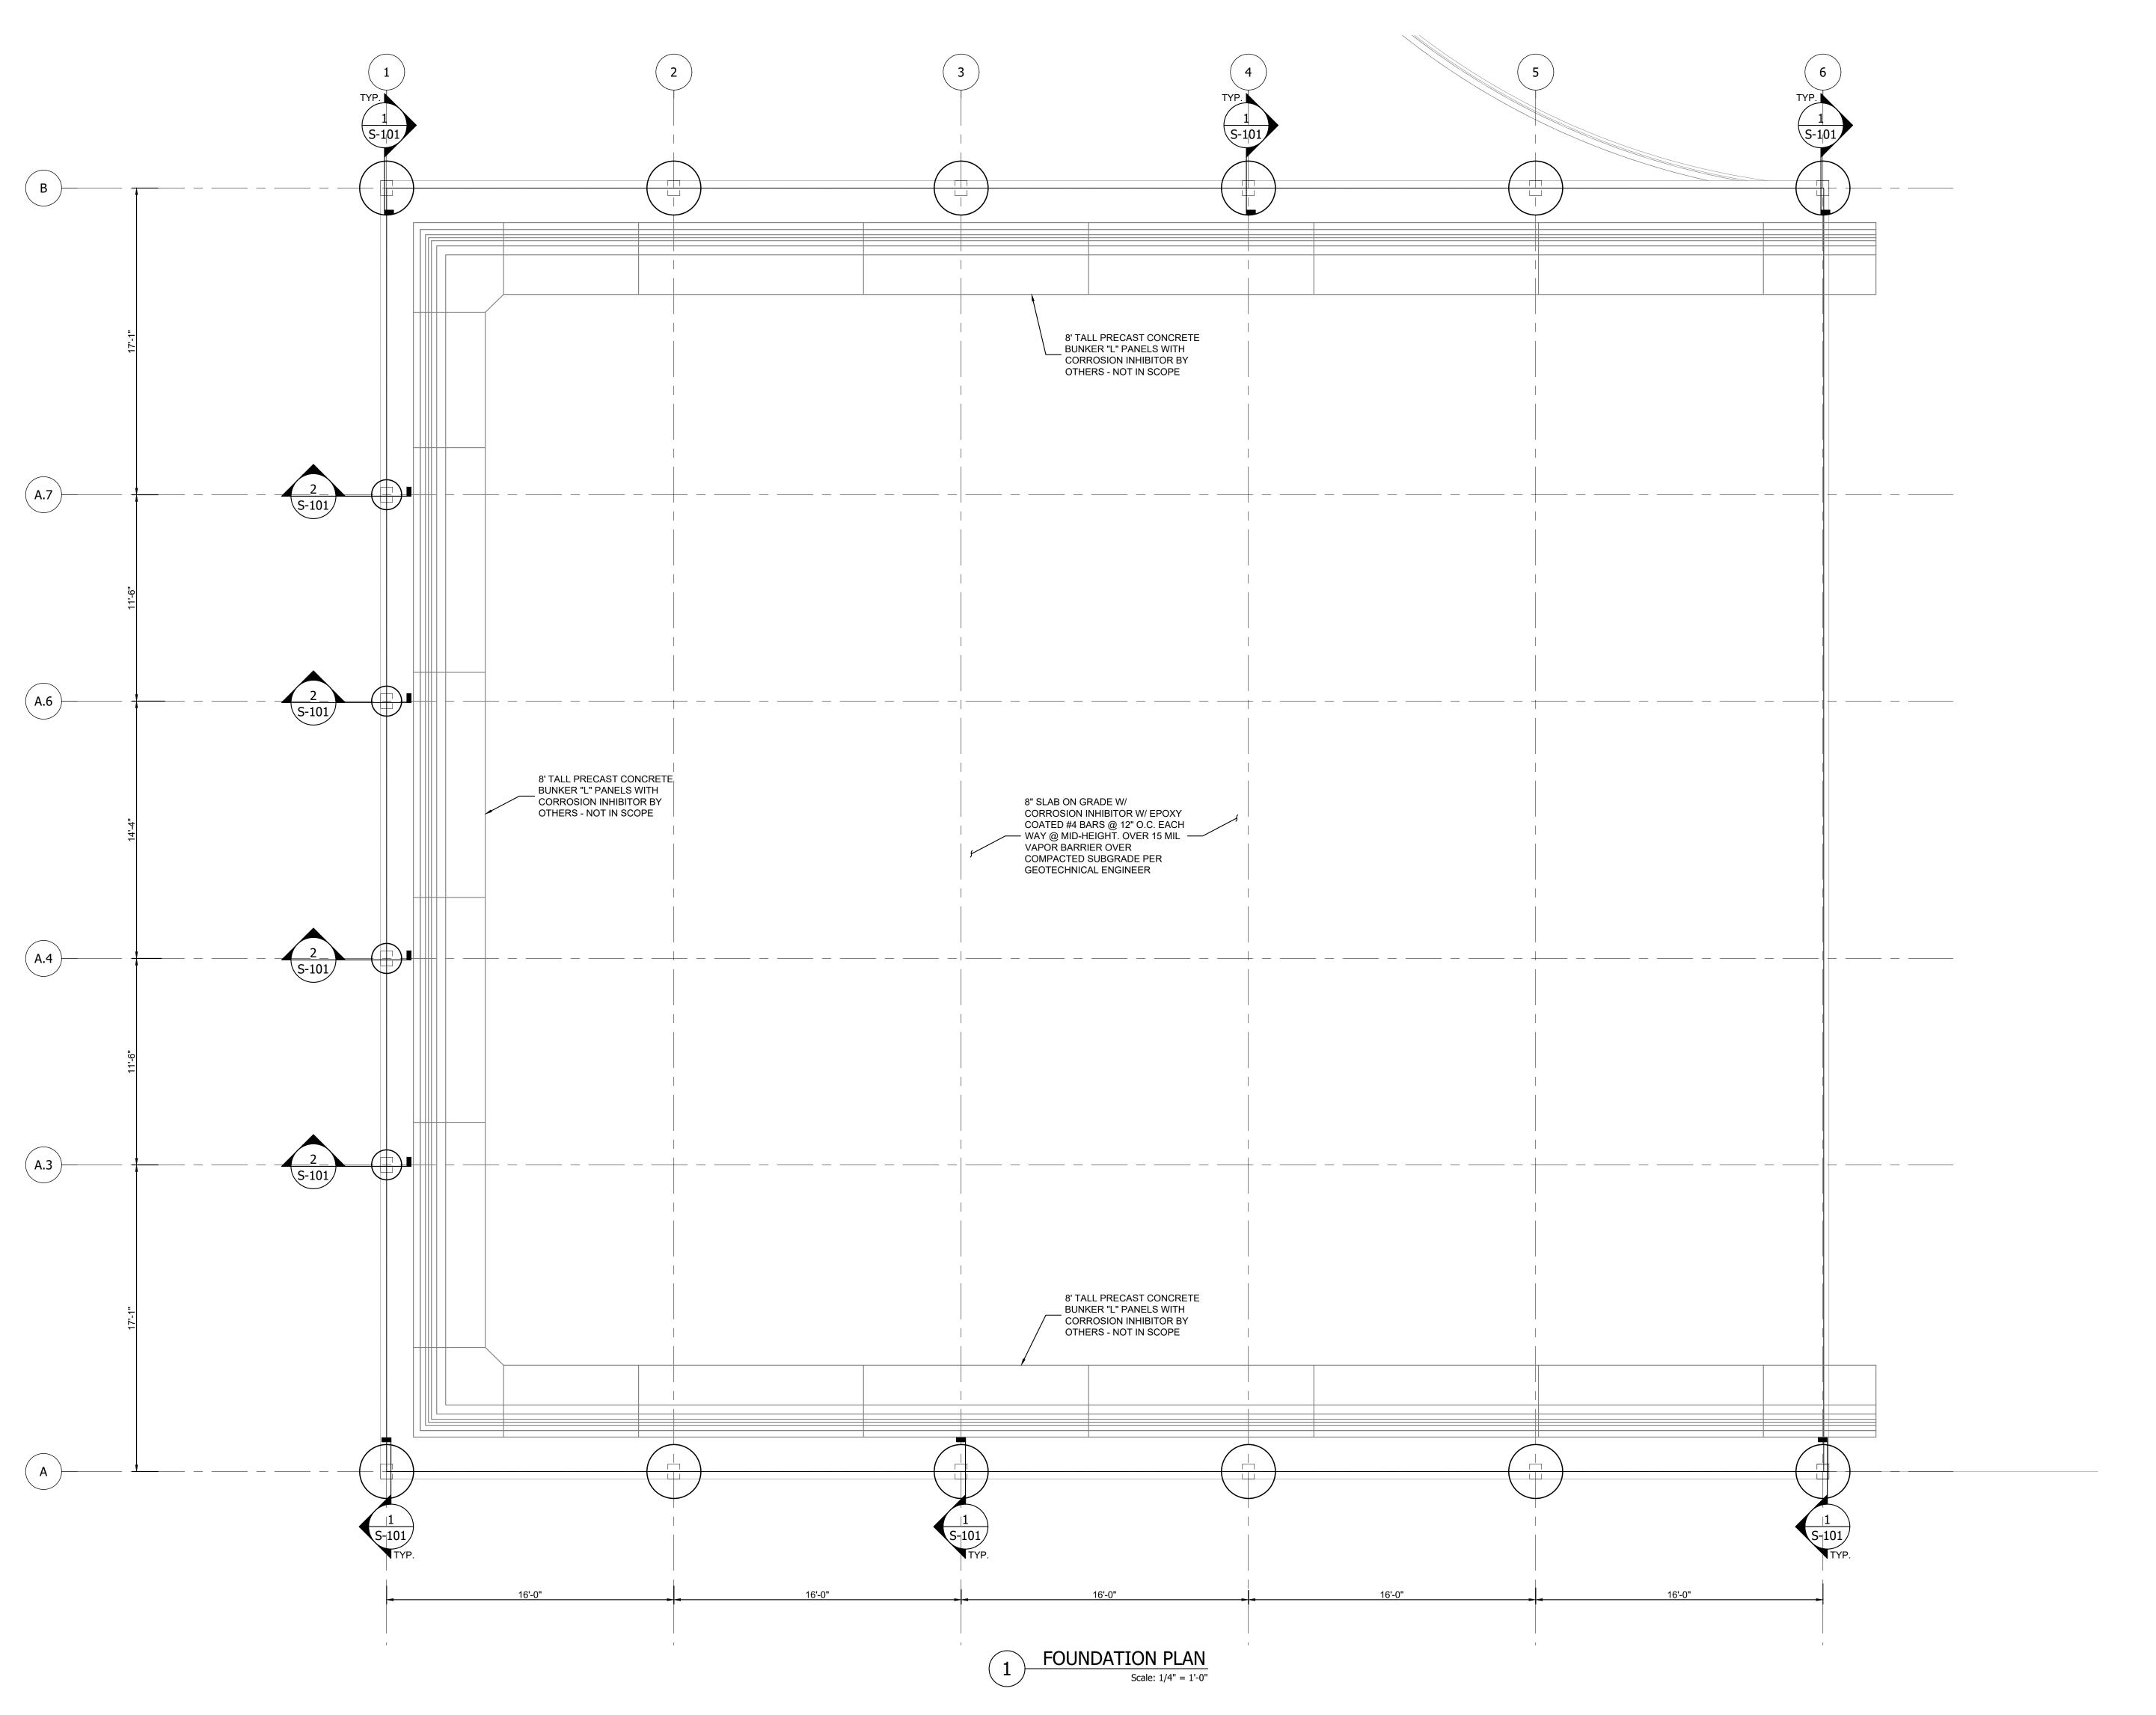




Δ STRUCTURAL ENGINEERS Δ
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WWW.ANAXENGINEERING.COM

SHEET REVISIONS:

No. DATE NATURE OF REVISION

7-26-23	ISSUED FOR PERMIT
	7-26-23

STATEMENT OF COMPLIANCE
I have prepared, or caused to be prepared under my supervision, the attached plans and specifications and state that, to the best of my knowledge and belief and to the extent of my contractual obligation, they are in compliance with the applicable Codes and Ordinances.

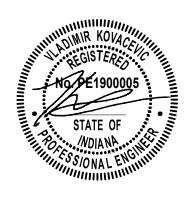

Signature Date: 7-26-2023 License Expires: 07-31-2024

PROJECT NAME:

Public Works Salt
Storage Foundation
Lake County
Lowell, IN

PROJECT No.: 23021

ISSUED FOR PERMIT

SHEET NAME:

FOUNDATION PLAN

SHEET No.:

S-201 A

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GENERAL NOTES:

THE FOLLOWING NOTES SHALL APPLY UNLESS OTHERWISE SHOWN OR NOTED ON THE

- 1. DESIGN AND CONSTRUCTION SHALL BE IN ACCORDANCE WITH CITY OF LOWELL BUILDING CODE, LATEST EDITION.
- 2. THE CONTRACTOR SHALL VERIFY ALL DIMENSIONS IN THE FIELD PRIOR TO COMMENCING WORK. THE ENGINEER SHALL BE NOTIFIED OF ANY DISCREPANCIES WHICH MAY EXIST.
- 3. INSPECTIONS SHALL BE MADE ON ALL MATERIALS AND PROCESSES AS SPECIFIED
- A. CONCRETE HAVING A STRENGTH IN EXCESS OF 2000 PSI B. WELDING
- 4. MATERIAL TESTS SHALL BE MADE AS SPECIFIED. CONCRETE TEST CYLINDERS SHALL BE MADE FOR ALL CONCRETE. TEST RESULTS SHALL BE DETERMINED BY THE TESTING LABORATORY.
- 5. TOP OF FLOORS SHALL BE TRUE TO INDICATED ELEVATIONS. VARIATIONS SHALL NOT EXCEED 1/4" IN 10 FEET. CARE MUST BE EXERCISED IN FINISHING OPERATIONS TO OBTAIN A TRUE SURFACE.
- 6. DETAILS, SECTIONS AND NOTES SHOWN ON THIS DRAWING ARE INTENDED TO BE TYPICAL AND SHALL APPLY TO SIMILAR SITUATIONS ELSEWHERE, UNLESS OTHERWISE SHOWN.
- 7. USE BONDING ADHESIVE AND SEALER AT ALL CONSTRUCTION JOINTS IN SUPPORTED
- 8. CONTRACTOR SHALL FURNISH ALL NECESSARY BRACING REQUIRED TO PROPERLY CONSTRUCT THE STRUCTURE. ALL BRACING TO BE DESIGNED AND SEALED BY A LICENSED STRUCTURAL ENGINEER. SUBMIT BRACING / SHORING DRAWINGS TO THE ENGINEER OF RECORD FOR APPROVAL PRIOR TO PROCEEDING. FOUNDATION WALLS SHALL REMAIN LATERALLY BRACED UNTIL FIRST FLOOR IS FULLY CONSTRUCTED.
- 9. DO NOT SCALE DRAWINGS.
- 10. THE CONTRACTOR SHALL BE RESPONSIBLE FOR SHEETING AND SHORING ADJACENT STRUCTURES AS REQUIRED SO THAT THEY ARE NOT ENDANGERED BY THIS CONSTRUCTION. SHORING SHALL BE DESIGNED BY LICENSED STRUCTURAL ENGINEER AND SEALED.
- 11. CONTRACTOR SHALL RELY ONLY ON WRITTEN COMMUNICATION WHEN COMMUNICATING WITH THE EOR. EOR WILL NOT PROVIDE ANY INFORMATION VERBALLY.

DESIGN LOADS:

- DESIGN SELFWEIGHT LOADS ARE IN ACCORDANCE WITH SHOWN PHYSICAL STRUCTURE.

2.	THE	E DESIGN SUPERIMPOSEI	D LOADS ARE AS FOLLOWS:
	A.	WAREHOUSE FLOOR: LIVE LOAD DEAD LOAD TOTAL LOAD	= 125 PSF = 15 PSF = 140 PSF
	B.	OFFICES: LIVE LOAD DEAD LOAD PARTITION LOAD TOTAL LOAD	= 50 PSF = 15 PSF = 20 PSF = 85 PSF
	C.	ROOF: SNOW LOAD <u>DEAD LOAD</u> TOTAL LOAD	= 30 PSF = 25 PSF = 55 PSF
	D.	WIND: MWFRS CLADDING	= 20 PSF = 25 PSF

MATERIALS

CONCRETE:

- A. CONCRETE STRENGTHS AT 28 DAYS SHALL BE AS FOLLOWS: A.1. GRADE SLABS F'c = 4000 PSI
- A.2. FOOTINGS F'c = 4000 PSI
- A.3. FOUNDATION WALLS F'c = 4000 PSI
- B. AIR ENTRAINMENT SHALL BE USED IN ALL CONCRETE EXCEPT CAISSONS AND FOOTINGS.
- C. CONCRETE MIX DESIGNS SHALL BE PREPARED BY AN APPROVED TESTING LABORATORY. MIX DESIGNS SHALL BE SUBMITTED TO THE ENGINEER FOR APPROVAL BEFORE USE. D. FINE AND COARSE AGGREGATES SHALL BE STONE AGGREGATES CONFORMING
- TO ASTM C33 E. PORTLAND CEMENT SHALL BE TYPE I OR III CONFORMING TO ASTM C150.
- F. THE WATER-CEMENT RATIO FOR BEAMS AND SLABS SHALL NOT EXCEED 0.40. SUPERPLASTICIZERS MAY BE USED.
- 2. REINFORCEMENT:
- REINFORCING STEEL SHALL CONFORM TO ASTM 615 (60,000 PSI YIELD) FOR BEAMS, SLABS AND WALLS.
- B. WELDED WIRE FABRIC USED FOR SLAB ON GRADE CONSTRUCTION SHALL CONFORM TO ASTM A884 FOR WELDED WIRE EPOXY COATED.

	MIXING PRO	PORTIONS FOR TYPE N	OR O MORTAR
PARTS BY VOLUME			AGGREGATE MEASSURED IN
MORTAR TYPE	PORTLAND CEMENT	TYPE "S" HYDRATED LIME	A DAMP, LOOSE CONDITION
М	3	1	12
S	2	1	9
N	1	1	6
0	1	2	9

SUBMIT ALL SHOP DRAWINGS TO THE ENGINEER FOR REVIEW AND GENERAL CONFORMANCE TO THE CONSTRUCTION DOCUMENTS. STEEL SHOP SHALL DESIGN AND ertDETAIL ALL STEEL CONNECTIONS PER AISC AND SUBMIT TO THE EOR FOR APPROVAL. DO NOT BEGIN FABRICATION OF THE STEEL UNTIL ALL SHOP DRAWINGS HAVE BEEN APPROVED BY THE EOR. PRIOR TO SUBMISSION TO THE ENGINEER, THE GENERAL CONTRACTOR SHALL REVIEW AND APPROVE ALL SHOP DRAWINGS. AN APPROVAL STAMP OF THE SHOP DRAWINGS IS REQUIRED. GC SHALL REVIEW AND APPROVE ALL DIMENSIONS, QUANTITIES AND CONTRACTIBILITY ASPECTS.

FOUNDATION NOTES:

- 1. NO SOIL INVESTIGATION HAS BEEN PERFORMED BY ANAX ENGINEERING, INC. THE BEARING CAPACITY USED FOR THE FOUNDATION DESIGN IS 3.0 KSF AS PER GEOTECHNICAL REPORT PREPARED BY ADVANCED ENGINEERING SERVICES DATED 12/24/20. THE BEARING VALUE SHALL BE VERIFIED IN THE FIELD BY A QUALIFIED TESTING AGENCY PRIOR TO CONSTRUCTION PROCEDURE.
- THE OWNER SHALL PROVIDE THE SERVICES OF A GEOTECHNICAL ENGINEER TO VERIFY THE SOIL BEARING CAPACITIES AT THE BOTTOM OF THE FOOTINGS IF LESSER BEARING VALUES ARE ENCOUNTERED AT THE REQUIRED ELEVATIONS, THE CONTRACTOR SHALL NOTIFY THE ENGINEER BEFORE THE PROCEEDING WITH THE PLACEMENT OF FOUNDATIONS.
- 3. FOOTINGS SHALL BE PLACED ON UNDISTURBED SOIL OR COMPACTED GRANULAR FILL. THE MINIMUM DEPTH FOR FOOTINGS SHALL BE 3'-6" BELOW GRADE, UNLESS SHOWN OTHERWISE ON THE DRAWINGS.
- 4. THE CONTRACTOR IS RESPONSIBLE FOR THE DESIGN, INSTALLATION AND REMOVAL OF ALL EXCAVATION SUPPORT SYSTEMS.
- 5. CONTROL JOINTS IN CURBS, RETAINING AND OTHER WALLS SHALL BE EVERY 15'-0" O.C. (MAX.) OR AT CHANGES IN DIRECTION (UNLESS NOTED OTHERWISE).

GENERAL MASONRY NOTES:

- A. PORTLAND CEMENT SHALL BE IN ACCORDANCE WITH ASTM C-150 LATEST VERSION, TYPE 1, GRAY OR WHITE AS REQUIRED FOR COLOR SELECTED. COLOR FOR COLORED MORTAR TO BE BY GEORGE B. SMITH COLOR COMPANY OR SOLOMON GRIND-CHEM SERVICE, INC.
- B. HYDRATED LIME SHALL BE IN ACCORDANCE WITH ASTM-C-207 LATEST
- VERSION, TYPE S. C. AGGREGATE SHALL BE IN ACCORDANCE WITH ASTM C-144-66T, NATURAL SAND. FOR JOINTS 1/4" THICK OR LESS, ALL OF THE SAND MUST PASS THE NO. 8 SIEVE, AND 95% MUST PASS THE NO. 16 SIEVE.
- D. WATER SHALL BE CLEAN, FREE OF DELETERIOUS MATERIALS. E. MINIMUM BLOCK STRENGTH fm = 1500 PSI U.N.O. AT SHEARWALLS.
- PROPORTIONING: MORTAR SHALL BE PROPORTIONED BY VOLUME PER ASTM C-270-64T FOR TYPE N, S OR M.
- MIXING: MIX CEMENTITIOUS MATERIALS AND AGGREGATE IN A MECHANICAL BATCH MIXER FOR AT LEAST 3 MINUTES WITH THE MAXIMUM AMOUNT OF WATER TO PRODUCE A WORKABLE CONSISTENCY. USE MORTAR WITHIN TWO HOURS AFTER MIXING. DO NOT RETEMPER MORTAR. DO NOT ADD ADMIXTURES WITHOUT WRITTEN APPROVAL. DO NOT ADD LIME TO MASONRY CEMENT MORTAR.
- 4. UNIT MASONRY: IN ADDITION TO THE REQUIREMENTS SPECIFIED HEREIN, COMPLY WITH THE APPLICABLE RECOMMENDATIONS OF THE PORTLAND CEMENT ASSOCIATION CONCRETE MASONRY HANDBOOK.
- 5. HANDLING AND STORAGE: HANDLE AND STORE MATERIALS IN SUCH A MANNER AS TO PREVENT DAMAGE. STORE BRICK, BLOCK, JOINT REINFORCEMENT AND PACKAGED MATERIALS ABOVE GROUND ON WOOD PALLETS OR BLOCKING AND PROTECT FROM THE WEATHER UNTIL USED. ALL DAMAGED OR OTHERWISE UNSUITABLE MATERIAL, WHEN SO ASCERTAINED, SHALL BE IMMEDIATELY REMOVED FROM JOB SITE.
- 6. PROTECTION: DURING CONSTRUCTION, THE TOPS OF ALL WALLS SHALL BE COVERED AT NIGHT, DURING INCLEMENT WEATHER AND DURING DELAYS TO ENSURE AGAINST DAMAGE TO FINISHED WORK. WALLS AT ALL TIMES SHALL BE PROTECTED FROM DRIPPINGS FROM ABOVE. WHERE NECESSARY OR DIRECTED, PROVIDE COVERING TO PROTECT PARTICULAR PORTIONS OF THE WORK. MAINTAIN ALL PROTECTION UNTIL REMOVED FOR FINAL CLEANING.
- REINFORCEMENT: HORIZONTAL JOINT WALL REINFORCEMENT SHALL BE LADDER DESIGN, CRIMPED AT CENTER, GALVANIZED, FABRICATED FROM COLD DRAWN STEEL WIRE CONFORMING TO ASTM-A-82 LATEST VERSION, MINIMUM NO. 9 GAUGE DEFORMED SIDE RODS WITH WELD CONNECTED NO. 9 GAUGE CROSS-RODS @ 16" O.C. WIDTH 2" LESS THAN WALL THICKNESS. INCLUDE PREFABRICATED CORNERS AND TEE SECTIONS. REINFORCING STEEL SHALL CONFORM TO ASTM A-615, GRADE 60. VERTICAL REINFORCEMENT SHALL BE PER PLAN. IF NEEDED, REINFORCEMENT SHALL BE SPLICED PER LAP SPLICE SCHEDULE. WITH BARS BEING SPLICED SIDEWAYS, SO THAT BOTH BARS REMAIN AT THE CENTER OF WALL THICKNESS
- 8. CORRUGATED METAL TIES: GALVANIZED STEEL, MINIMUM 7/8" WIDE, 22 GAUGE AND
- 9. COMPRESSIBLE JOINT FILLERS: ASTM D-1056 LATEST VERSION, CLASS E, CLOSED CELL EXPANDED NEOPRENE, TYPE S, CLASS SCE 41.
- 10. CONCRETE MASONRY UNITS: AUTOCLAVED AND PRESHRUNK, MAXIMUM LINEAR SHRINKAGE OF 0.03 WHEN TESTED IN ACCORDANCE WITH ASTM C-426 LATEST
- A. MAXIMUM MOISTURE CONTENT AT TIME OF DELIVERY SHALL BE 30%. B. HOLLOW LOAD BEARING UNITS SHALL CONFORM TO ASTM C-90 LATEST
- C. SOLID LOAD BEARING UNITS SHALL CONFORM TO ASTM C-145 LATEST VERSION, TYPE 1, GRADE U-1.

VERSION, TYPE 1, P-1.

- D. LIGHTWEIGHT AGGREGATES SHALL CONFORM TO ASTM C-133 LATEST VERSION 3.
- MACHINE EXPANDED SLAG, E. FACES OF UNITS SHALL BE NOMINAL 8" X 16" UNITS, NOMINAL THICKNESS
- SHALL BE AS SHOWN ON PLANS.
- 11. INSTALLATION: BUILD IN BLOCKING, FORM CHASES, SLOTS, CUTOUTS AND PATCH MASONRY WORK AS REQUIRED. SET ALL BUCKS, BLOCKING LINTELS AND ANCHORS AS REQUIRED. FILL ALL HOLLOW METAL FRAMES OCCURRING IN BRICK OR BLOCK WALLS WITH MASONRY MORTAR AND CAREFULLY POINT ALL JOINTS BETWEEN METAL FRAMES AND ADJACENT MASONRY AND OTHER CONSTRUCTION. USE HALF RUNNING BOND, UNLESS OTHERWISE SHOWN FOR BOTH BRICK AND BLOCK. DO NOT USE CHIPPED OR BROKEN BLOCK WHERE EXPOSED TO VIEW. PROVIDE 3/8" WIDE JOINTS, TOOLED CONCAVE UNLESS OTHERWISE SHOWN OR DIRECTED. USE SOLID MASONRY UNITS AS FIRST COURSE UNDER ALL STRUCTURAL MEMBERS BEARING ON WALLS. UNLESS SHOWN OTHERWISE ON THE PLANS, PROVIDE VERTICAL CONTROL JOINTS AT 40'-0" O.C. MAX. WHERE BLOCK WALLS EXTEND TO UNDERSIDE OF ROOF DECK AND WHERE BLOCK INTERSECTS STEEL COLUMNS, PROVIDE STEEL ANCHORS AT 24" O.C. TO SECURE WALL IN PLACE, GROUT JOINT AT ROOF DECK OR BEAM SOLID WITH MORTAR. WHERE FIRE RATED WALLS ARE SHOWN OR REQUIRED, USE UNITS AND INSTALLATION METHODS COMPLYING WITH CODE AND UL REQUIREMENTS.
- 12. FROZEN WORK: DO NOT BUILD UPON FROZEN WORK. DO NOT LAY MASONRY UNITS WHICH HAVE A FILM OR FROST. REMOVE AND REPLACE AS DIRECTED, MASONRY WORK WHICH IS OBSERVED TO BE DAMAGED BY FREEZING. DO NOT ALLOW GROUT TO REACH TEMPERATURE BELOW 40 DEGREES UNTIL FULLY CURED.
- 13. CLEANING: CLEAN EXPOSED BRICK MASONRY SURFACES BY THE BUCKET OF CLEAR WATER AND BRUSH HAND CLEANING METHOD OR BY HIGH PRESSURE WATER METHOD. CLEAN ALL EXCESS MORTAR AND FILM FROM EXPOSED SURFACES. DO NOT USE ACID OR ACID SOLUTIONS. USE COMMERCIAL CLEANING AGENTS IN ACCORDANCE WITH MANUFACTURER'S INSTRUCTIONS. WASH ALL SURFACES AFTER USING AGENTS WITH CLEAR WATER HOSING. CLEAN EXPOSED CMU MASONRY BY DRY BRUSHING AT THE END OF EACH DAYS WORK AND AFTER FINAL POINTING TO REMOVE MORTAR SPOTS AND DROPPINGS.
- 14. SHEAR WALLS: SHEAR WALLS SHALL BE CONSTRUCTED PER STRUCTURAL PLANS AND DETAILS. REINFORCEMENT SHALL BE PER PLANS AND SHEAR WALL SCHEDULE. THERE SHALL BE NO EXPANSION JOINTS OR OTHER DISCONTINUITIES IN THE SHEAR WALLS, UNLESS WRITTEN APPROVAL IS PROVIDED BY THE STRUCTURAL ENGINEER OF RECORD.
- COMPOSITE WALL CONSTRUCTION: FOR WALLS DESIGNATED AS COMPOSITE, FILL 6. JOINTS BETWEEN MASONRY BRICK AND BLOCK WITH TYPE S MORTAR. PROVIDE MINIMUM WALL TIE (WIRE TIE W2.8) EVERY OTHER COURSE. MINIMUM f'm = 1500 PSI.
- 16. TYPICAL WALL REINFORCEMENT IS #4 @ 32" O.C., U.N.O. WITH MINIMUM SPLICE LAP LENGTH OF 24" U.N.O.
- 7. MASONRY DESIGN AND CONSTRUCTION SHALL BE IN ACCORDANCE WITH ACI-530, LATEST EDITION.

REINFORCED CONCRETE NOTES:

- REINFORCED CONCRETE WORK SHALL BE IN ACCORDANCE WITH "BUILDING CODE REQUIREMENTS FOR REINFORCED CONCRETE", ACI 318 LATEST EDITION.
- 2. CONCRETE SHALL NOT BE DROPPED THROUGH REINFORCING STEEL (AS IN WALLS) SO AS TO CAUSE SEGREGATION OF AGGREGATES. IN SUCH CASES, HOPPERS OR VERTICAL CHUTES OR TRUNKS SHALL BE USED. CHUTES OR TRUNKS SHALL BE OF VARIABLE LENGTHS SO THAT THE FREE UNCONFINED FALL OF CONCRETE SHALL NOT EXCEED SIX (6) FEET AND A SUFFICIENT NUMBER OF CHUTES OR TRUNKS SHALL BE USED TO INSURE THAT THE CONCRETE IS KEPT LEVEL AT ALL TIMES.
- 3. ALL DIMENSIONS SHOWN FOR LOCATIONS OF REINFORCING ARE TO BE TAKEN FROM THE FACE OF MAIN BARS AND DENOTE CLEAR MIN. COVERAGE. FOR BEAMS AND TIED COLUMNS, DIMENSIONS ARE TO MAIN BARS. UNLESS SPECIFICALLY NOTED, CONCRETE COVERAGES TO REINFORCING STEEL (NOT PRESTRESSING STEEL) SHALL BE AS FOLLOWS:
- A. 3" WHERE CONCRETE IS DEPOSITED DIRECTLY AGAINST GROUND (EXCEPT
- GRADE SLABS). B. 2" WHERE CONCRETE IS EXPOSED TO GROUND, BUT PLACED IN FORMS.
- C. 2" TO MAIN BARS OF TIED COLUMNS. A. 1-1/2" TO WALL BARS, UNLESS NOTED OTHERWISE
- E. 1" TO BOTTOM BARS AND 2" TO TOP BARS IN SLABS IN FORMS.
- F. 2" TO BARS IN SLABS ON GRADE. G. 2" TO MAIN BARS OF BEAMS.
- 4. THE SPLICES IN ADJACENT BARS SHALL NOT BE LESS THAN FIVE (5') FEET APART VERTICAL WALL BARS SHALL BE SPLICED AT OR NEAR FLOOR LINES. BARS MAY BE WIRED TOGETHER AT SPLICES OR LAPS EXCEPT FOR TOP REINFORCING OF BEAMS AND SLABS OR WHERE DEFINITELY DETAILED TO BE SEPARATED. SEE BEAM DETAILS OR SCHEDULES FOR SEPARATION OF BEAM OR GIRDER BARS OVER SUPPORTS. CONTINUOUS BARS IN SPANDRELS, WALL BEAMS, ETC., SHALL LAP AS FOLLOWS
- A. TOP BARS AT CENTER LINE OF SPAN. B. BOTTOM BARS AT CENTER LINE OF SUPPORTS.
- WALLS SHALL BE DOWELED TO FOOTINGS. WALLS. BEAMS OR SLABS WITH BARS OF THE SAME SIZE AND SPACING AS THE WALL BARS, EXCEPT WHERE SPECIFICALLY INDICATED OTHERWISE.
- 6. SEE ARCHITECTURAL AND MECHANICAL DRAWINGS FOR THE SIZE AND LOCATION OF WALL AND FLOOR OPENINGS. WALL OFFSETS, PROVISIONS FOR FUTURE EQUIPMENT. STAIR DETAILS, PIPE, VENT, DUCT AND OTHER OPENINGS AND DETAILS NOT SHOWN ON STRUCTURAL DRAWINGS. SEE ELECTRICAL DRAWINGS FOR SUPPORTS AND OPENINGS FOR ELECTRICAL EQUIPMENT.
- REINFORCING STEEL DETAILS SHALL BE IN ACCORDANCE WITH THE MANUAL OF STANDARD PRACTICE FOR DETAILING REINFORCED CONCRETE STRUCTURES, ACI LATEST EDITION.
- 8. THE MINIMUM REINFORCEMENT FOR WALLS SHALL BE AS PER ACI 318 CHAPTER 14, SECTION 14.3, UNLESS NOTED OTHERWISE.
- 9. THE MINIMUM TEMPERATURE REINFORCEMENT SHALL BE AS PER ACI 318 CHAPTER 7 SECTION 7.12 UNLESS NOTED OTHERWISE.
- 10. AT A MINIMUM, CONCRETE WALLS SHALL HAVE #4 BARS @ 12" O.C. EA. FACE EA. WAY, UNLESS OTHERWISE SHOWN.

LAP SPLICE SCHEDULE (APPLIES TO REINF. CONC. & MASONRY)					
BAR SIZE CLASS "B" SPLICE					
#4	33				
#5	41				
#6	48				
#7	70				
#8	81				

GENERAL PRECAST NOTES

INSULATION: SHALL BE POLYSTYRENE

- 1. PRE-CAST CONTRACTOR TO REFER TO ARCHITECTURAL DRAWINGS FOR OPENINGS FOR DOOR FLOOR PIVOTS AND MECHANICAL/ELECTRICAL DRAWINGS FOR OPENING
- PRECAST CONCRETE:
- THE PRECAST CONCRETE MANUFACTURER SHALL BE RESPONSIBLE FOR THE DESIGN AND INSTALLATION OF ALL PRECAST INCLUDING REINFORCING, INSERTS AND CONNECTIONS TO THE STRUCTURE NOT SPECIFICALLY CALLED OUT ON THE DRAWINGS. PRECAST CONCRETE SHALL BE PRESTRESSED TO STRUCTURALLY SUPPORT THE FLOOR STRUCTURE AND HANDLING (ERECTING) LOADS, AND SHALL BE DESIGNED SO THAT BOTH WYTHES OF CONCRETE, INNER AND OUTER, SHALL BE KEPT IN COMPRESSION UNDER ALL LOADING CONDITIONS. NO FLEXURAL TENSION IS TO BE ALLOWED IN THE PRE-COMPRESSED TENSILE ZONE. BOTH WYTHES SHALL BE STRESSED TO MINIMIZE ANY BOWING DUE TO ECCENTRICITY OF PRESTRESS FORCE.
- ALL PRECAST SHALL BE DESIGNED FOR ANCHORAGE, ERECTION, REINFORCING, AND APPLIED LOADS BY A STRUCTURAL ENGINEER LICENSED IN THE STATE OF PROJECT LOCATION. THEY SHALL PROVIDE DRAWINGS AND CALCULATIONS TO WHICH THEY SHALL AFFIX THEIR SEAL AND SIGNATURE. THE PRESTRESS CONCRETE AND CONNECTIONS SHALL BE DESIGNED IN ACCORDANCE WITH STANDARDS OF THE PRECAST CONCRETE INSTITUTE MANUAL, ACI-318 AND ACI-308 AND THE AISC MANUAL OF STEEL CONSTRUCTION.
- - ALL MATERIALS TO BE CLEAN AND NEW AND TO COMPLY WITH ARTICLES LISTED BELOW AS A MINIMUM STANDARD.
 - PORTLAND CEMENT: ASTM C-150, TYPE 1, EXCEPT USE TYPE 3 WHERE HIGH EARLY STRENGTH IS REQUIRED. COURSE AGGREGATE AND SAND: ASTM C-33 PRESTRESS STEEL STRANDS: ASTM A-416 REINFORCING STEEL: ASTM A-615, GRADE 60, ASTM A-305 MISCELLANEOUS STEEL: ASTM A-36 COILS AND BOLTS: ASTM A-325, ASTM A-307
 - WATER: CLEAN AND VOID OF ALL DELETERIOUS MATERIALS. FOR MATERIALS NOT SPECIFIED UNDER OTHER SECTIONS OF THESE SPECIFICATIONS, BUT REQUIRED FOR A COMPLETE AND PROPER INSTALLATION,

PROVIDE NEW MATERIALS, FIRST QUALITY OF THEIR RESPECTIVE KINDS, AS

SELECTED BY THE CONTRACTOR SUBJECT TO THE REVIEW OF THE ARCHITECT AND

- THE OWNER'S REPRESENTATIVE. FABRICATION: ALL CONCRETE TO BE DESIGNED AND MANUFACTURED IN ACCORDANCE WITH ACI-301, ACI-304, ACI-311, ACI-318, ACI-347, ACI-533, CRSI MANUAL OF STANDARD PRACTICE, PCI-116, AWS D1.0, AWS D12.1. CONCRETE STRENGTH SHALL BE AT LEAST 5,000 PSI AT 28 DAYS AND SHALL BE AT LEAST 3,000 PSI AT RELEASE. CONCRETE BACK SIDE SHALL BE TROWELED SMOOTH, FREE FROM OIL, GREASE TROWEL MARKS, HONEYCOMBING AND EXPOSED AGGREGATE. MAKE EXPOSED EDGES SHARP, STRAIGHT AND SQUARE. MAKE FLAT SURFACES INTO A TRUE PLANE. ADDITIVES OR MIXTURES CONTAINING CALCIUM CHLORIDE WILL NOT BE PERMITTED
- STORAGE:
- STORE UNITS AT THE JOB SITE IN A MANNER TO PREVENT CRACKING, DISTORTION, WARPING, STAINING AND OTHER PHYSICAL DAMAGE, AND IN A MANNER TO KEEP MARKINGS VISIBLE. GENERAL CONTRACTOR SHALL VERIFY STORAGE AREA(S). LIFT AND SUPPORT THE UNITS ONLY AT DESIGNATED LIFTING POINTS OR SUPPORTING POINTS AS SHOWN ON THE APPROVED SHOP DRAWINGS. NO PRESTRESSING STRAND MAY BE CUT WITHOUT PRIOR APPROVAL OF THE ENGINEER.

IN THE CONCRETE. TOLERANCE SHALL BE 1/8" IN WIDTH, 1/2" IN LENGTH, AND 1/4" IN

DEPTH FOR OVERALL DIMENSIONS. ALL WINDOW AND DOOR TOLERANCES ARE TO BE

7. UNLESS NOTED OTHERWISE, THE PRECAST PLANK SHALL HAVE A 2" BONDED STRUCTURAL 5000 PSI CONCRETE TOPPING.

STEEL JOIST / DECK NOTES:

FOLLOWING NOTES SHALL APPLY IN ADDITION TO THE STRUCTURAL STEEL NOTES:

- 1. THE STEEL JOIST MANUFACTURER SHALL BE RESPONSIBLE FOR THE DESIGN, MANUFACTURE AND INSTALLATION OF THEIR PRODUCTS, INCLUDING ALL BRIDGING, ACCESSORIES AND CONNECTIONS NECESSARY FOR THE COMPLETE INSTALLATION. JOISTS SHALL BE DESIGNED FOR ALL LOADING CONDITIONS REQUIRED BY THE GOVERNING BUILDING CODES IN ADDITION TO ANY SPECIFIC LOADINGS SHOWN ON THE DRAWINGS. THE DESIGN, MANUFACTURE AND INSTALLATION OF ALL JOISTS, BRIDGING, ACCESSORIES, ETC. SHALL BE IN ACCORDANCE WITH THE SPECIFICATIONS, INCLUDING LOAD TABLES, OF THE STEEL JOIST INSTITUTE, LATEST EDITION. IF ANY STEEL JOIST SIZES HAVE BEEN SHOWN ON THESE DRAWINGS, THEY ARE PRELIMINARY ONLY AND SUBJECT TO FINAL DESIGN BY THE STEEL JOIST MANUFACTURER'S STRUCTURAL ENGINEER LICENSED IN THE JURISDICTION OF THIS PROJECT.
- ALL STEEL JOISTS TO BE FABRICATED AND ERECTED IN ACCORDANCE WITH THE STEEL JOIST INSTITUTE SPECIFICATIONS AND SO CERTIFIED. WHERE CONCENTRATED AND/OR NON-UNIFORM LOADS OCCUR. THE JOISTS MUST BE DESIGNED TO CARRY THE FULL COMBINATION OF UNIFORM, NON-UNIFORM AND CONCENTRATED LOADS. THE NON-UNIFORM AND CONCENTRATED LOADS ARE SPECIFIED ON THE PLANS AND/OR LOADING DIAGRAMS SHOWN. THE JOISTS MANUFACTURER SHALL BE RESPONSIBLE FOR THE JOIST DESIGNS BASED ON THE GIVEN LOADINGS AND SHALL SUBMIT CALCULATIONS FOR ALL SPECIAL JOISTS. PREPARED UNDER THE SUPERVISION OF A LICENSED STRUCTURAL ENGINEER.
- ALL JOISTS SHALL BE WELDED TO THEIR STEEL SUPPORT MEMBERS, PER SJI SPECIFICATIONS, UNLESS NOTED OTHERWISE OR IF EXPANSION IS REQUIRED. ALL JOISTS, U.N.O., SHALL BE DESIGNED FOR A LIVE LOAD DEFLECTION. JOIST ENDS AT THE BUILDING PERIMETER SHALL BE DESIGNED TO TRANSFER AN ADDITIONAL HORIZONTAL FORCE, AS SPECIFIED ON THE STRUCTURAL DRAWINGS, TO THE SUPPORTING MEMBER. THIS LOAD SHALL BE APPLIED AT THE TOP OF THE TOP CHORD, ABOVE THE BEARING SEAT AND PERPENDICULAR TO THE JOIST SPAN.
- 4. IF SHOWN ON PLANS, EXTEND BOTTOM CHORDS OF ALL JOISTS AND BOLT TO $\frac{3}{4}$ " STIFFENER PLATE ON BEAM OR CLIP ANGLE L3x3x₄. ALL JOISTS ON COLUMN LINES TO BE BOLTED CONNECTIONS.
- ABSOLUTELY NO HOLES SHALL BE DRILLED OR BURNED INTO TOP OR BOTTOM CHORDS OF OPEN WEB STEEL BAR JOISTS.
- 6. STEEL EQUIPMENT HANGERS ARE TO BE LOCATED AT JOIST PANEL POINTS.
- WHENEVER CONCENTRATED LOAD IS PLACED ON THE STEEL JOISTS AT LOCATIONS OTHER THAN PANEL POINTS, THE STEEL JOISTS SHALL BE REINFORCED PER MANUFACTURER'S DETAILS. AT A MINIMUM, THE JOISTS SHALL BE REINFORCED WITH L2x2x1/2 STRUTS FIELD WELDED BETWEEN THE LOCATION OF THE POINT LOAD AT THE TOP CORD AND BOTTOM CHORD PANEL POINT.
- ROOF DECK TO BE 1-1/2" DEEP WIDE RIB, 20 GAGE GALVANIZED METAL DECK (U.N.O.), CONTINUOUS OVER 3 SPANS MINIMUM. ALL METAL DECKS TO BE FABRICATED AND INSTALLED IN ACCORDANCE WITH THE STEEL DECK INSTITUTE AND SO CERTIFIED.
- CONDUIT, PIPING, FIXTURES OR ANY OTHER ITEMS SHALL NOT BE SUPPORTED FROM THE METAL DECK.

STRUCTURAL STEEL NOTES:

1. ALL STRUCTURAL STEEL SHALL BE AS FOLLOWS

CONSTANTS" FOR NON-COMPOSITE BEAMS.

- A. W-SHAPES SHALL BE ASTM A-992, Fy=50 K.S.I.
- B. HP-SHAPES SHALL BE ASTM A-572, GRADE 50, Fy=50 K.S.I. C. RECTANGULAR HSS-SHAPES SHALL BE ASTM A-500, GRADE B, Fy= 46 K.S.I.
- D. ROUND HSS-SHAPES SHALL BE ASTM A-500, GRADE B, Fy= 42 K.S.I.
- E. PIPES SHALL BE ASTM A-53, GRADE B, Fy=35 K.S.I. F. ALL OTHER SHAPES AND PLATES SHALL BE ASTM A-36, Fy=36 K.S.I.
- ALL FABRICATION AND ERECTION OF STEEL TO BE IN ACCORDANCE WITH A.I.S.C. SPECIFICATION FOR DESIGN, FABRICATION AND ERECTION OF STRUCTURAL STEEL FOR BUILDINGS LATEST EDITION, UNLESS OTHERWISE SHOWN OR NOTED, ALL CONNECTIONS SHALL DEVELOP ONE-HALF OF THE ALLOWABLE UNIFORM LOAD CAPACITY OF THE MEMBER USING WEB ANGLES AND ASTM A-325N H.S. BOLTS AS A MINIMUM.
- 3. STEEL CONNECTIONS ARE DELEGATED DESIGN ELEMENT PER AISC CODE OF STANDARD PRACTICE 303-10 3.12. ALL CONNECTIONS SHALL BE DESIGNED AND DETAILED BY THE FABRICATOR. DETAILING SHALL BE PERFORMED USING RATIONAL ENGINEERING DESIGN AND STANDARD PRACTICE IN ACCORDANCE WITH THE REQUIREMENTS OF THE CONTRACT DOCUMENTS. THE GENERAL DETAILS SHOWN ON THE DRAWINGS ARE CONCEPTUAL ONLY AND DO NOT INDICATE THE REQUIRED NUMBER OF BOLTS OR WELD SIZES, ALL CONNECTIONS SHALL BE SUBMITTED TO THE EOR FOR REVIEW AND SHALL INCLUDE ENGINEERING CALCULATIONS ALONG WITH CONNECTION DETAIL DRAWINGS, PRIOR TO THE SUBMITTAL OF STRUCTURAL STEEL SHOP DRAWINGS. THE DESIGN CALCULATIONS SHALL BE PREPARED AND SEALED BY A QUALIFIED PROFESSIONAL ENGINEER REGISTERED IN THE STATE OF INDIANA. TYPICAL BEAM CONNECTIONS SHALL BE STANDARD AISC FRAMED BEAM CONNECTIONS, UNLESS OTHERWISE SHOWN. ALL FIELD CONNECTIONS, EXCEPT WHERE SHOWN WELDED, SHALL BE BOLTED WITH 3/4" DIAMETER HIGH STRENGTH BOLTS CONFORMING TO ASTM A325 OR A490, UNLESS OTHERWISE NOTED. CONNECTIONS SHALL BE DESIGNED FOR 50% OF THE TOTAL ALLOWABLE UNIFORM LOAD (IN KIPS) DERIVED FROM THE AISC MANUALS TABLE OF "UNIFORM LOAD
- 4. ALL COPED BEAMS TO BE DESIGNED IN ACCORDANCE WITH APPENDIX B OF THE AISC MANUAL "ENGINEERING FOR STEEL CONSTRUCTION". PROVIDE REINFORCING AS REQUIRED. ALL RE-ENTRANT CORNERS TO BE SHAPED, NOTCH-FREE, TO A RADIUS OF AT LEAST 1/2".
- GENERAL CONTRACTOR SHALL PROVIDE AND PAY FOR SERVICES OF A REGISTERED LAND SURVEYOR WHO, AS WORK PROCEEDS, SHALL CHECK EVERY MAJOR ELEMENT FOR LINE, LEVEL AND PLUMB. GENERAL CONTRACTOR SHALL PROMPTLY NOTIFY OWNER AND ARCHITECT UPON DETECTION OF DEVIATIONS WHICH EXCEED STANDARD AISC "SPECIFICATIONS FOR THE DESIGN, FABRICATION AND ERECTION OF STRUCTURAL STEEL FOR BUILDINGS", EXCEPT AS OTHERWISE INDICATED.
- 6. ALL WELDING TO BE IN ACCORDANCE WITH A.W.S. AND AISC SPECIFICATIONS. WELDING ELECTRODES SHALL BE E70XX, Fy=70 KSI.
- 7. ALL ELEVATIONS ARE TO TOP OF STEEL BEAMS UNLESS NOTED OTHERWISE.
- 8. ALL BEAMS SPLICES, NOT INDICATED ON THE CONTRACT DOCUMENTS, SHALL BE PENETRATION WELDED TO RESTORE FULL CAPACITIES OF THE ORIGINAL BEAM, BOLTED CONNECTIONS SHALL BE USED FOR ERECTION PURPOSES ONLY, UNLESS APPROVED IN WRITING BY THE ENGINEER OF RECORD. IF SPLICES ARE REQUIRED FOR CONSTRUCTION PURPOSES, CONTRACTOR SHALL COORDINATE ALL SPLICE LOCATIONS WITH THE ARCHITECT AND THE VARIOUS PROJECT CONSULTANTS TO AVOID ANY INTERFERENCE/CONFLICTS WITH OTHER TRADES.
- 9. SEE ARCHITECTURAL DRAWINGS FOR MISCELLANEOUS STEEL, PLATES, ETC.
- 10. VERIFY ALL OPENINGS FOR MECHANICAL EQUIPMENT, ETC., WITH MECHANICAL CONTRACTORS BEFORE ERECTION OF ANY STEEL. PROVIDE ANGLE FRAMES FOR ALL OPENINGS LARGER THAN 12" SQUARE, AND PROVIDE ALL AUXILIARY FRAMING AS REQUIRED.
- 11. ALL STRUCTURAL STEEL TO HAVE ONE SHOP COAT OF MEDIUM GRAY RUST INHIBITIVE PAINT (INCLUDING ALL MISCELLANEOUS STEEL). FIELD TOUCH-UP AS REQUIRED ON ALL EXPOSED STEEL. STEEL EXPOSED TO WEATHER SHALL BE GALVANIZED. STEEL MEMBERS ARE TO BE CLEANED OF ALL MUD, MARKINGS, ETC., AFTER INSTALLATION.
- 12. STEEL BEAMS TO BE SLOPED UNIFORMLY TO ROOF DRAINS AS INDICATED ON STEEL



SHEET REVISIONS:

DATE NATURE OF REVISION

CHICAGO, IL 60603

PHONE: 847-461-9006


WWW.ANAXENGINEERING.COM

EMAIL: INFO@ANAXENG.COM

_	5-13-22	ISSUED F	OR	PERMIT

STATEMENT OF COMPLIANCE have prepared, or caused to be

prepared under my supervision, the attached plans and specifications and state that, to the best of my knowledge and belief and to the extent of my contractual obligation, they are in compliance with the applicable Codes and Ordinances.

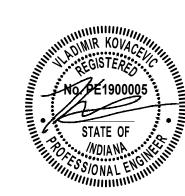

Signature Date: 5-13-2022 License Expires: 07-31-2022

PROJECT NAME:

Public Works Building Lake County Lowell. IN


PROJECT No.: 21024

ISSUED FOR PERMIT

GENERAL NOTES

SHEET NAME:

SHEET No.:

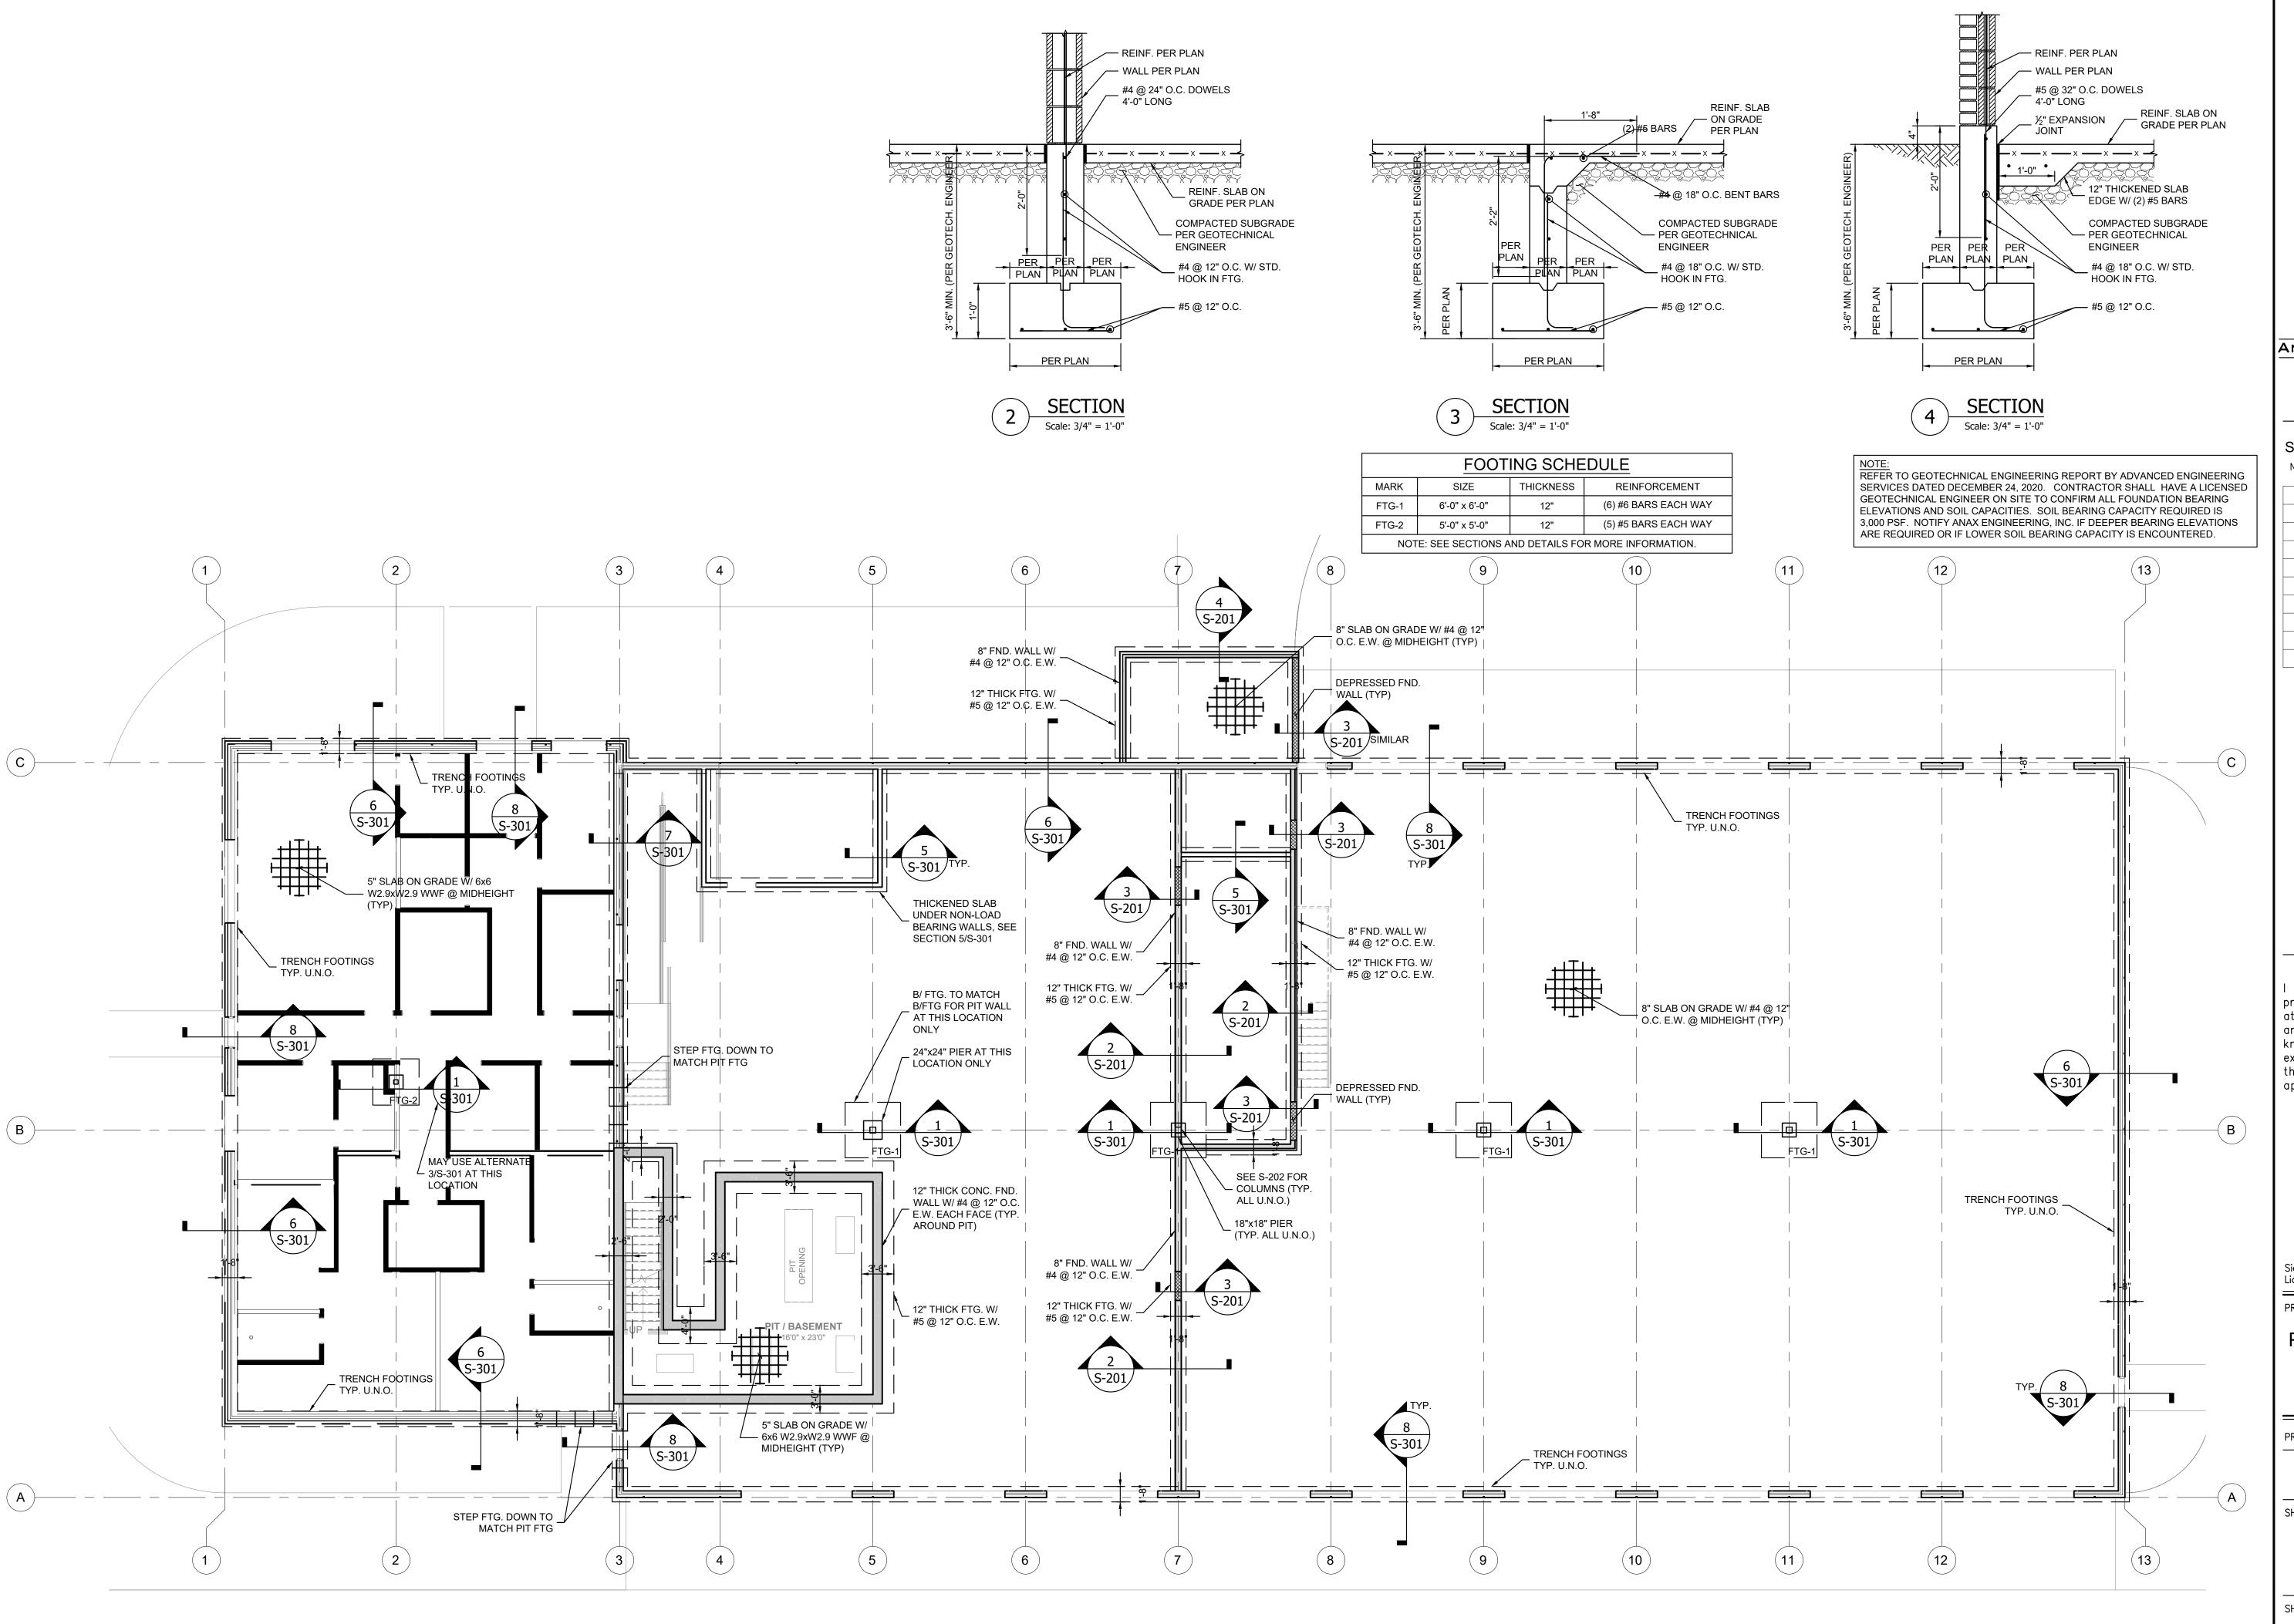



PHONE: 847-461-9006 EMAIL: INFO@ANAXENG.COM

WWW.ANAXENGINEERING.COM

SHEET REVISIONS:

No. DATE NATURE OF REVISION

1101	57112	TWITTE OF	1121101011
_	5-13-22	ISSUED FOR	PERMIT

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Public Works Building Lake County Lowell, IN


PROJECT No.: 21024

ISSUED FOR PERMIT

SHEET NAME:

FOUNDATION PLAN

SHEET No.:

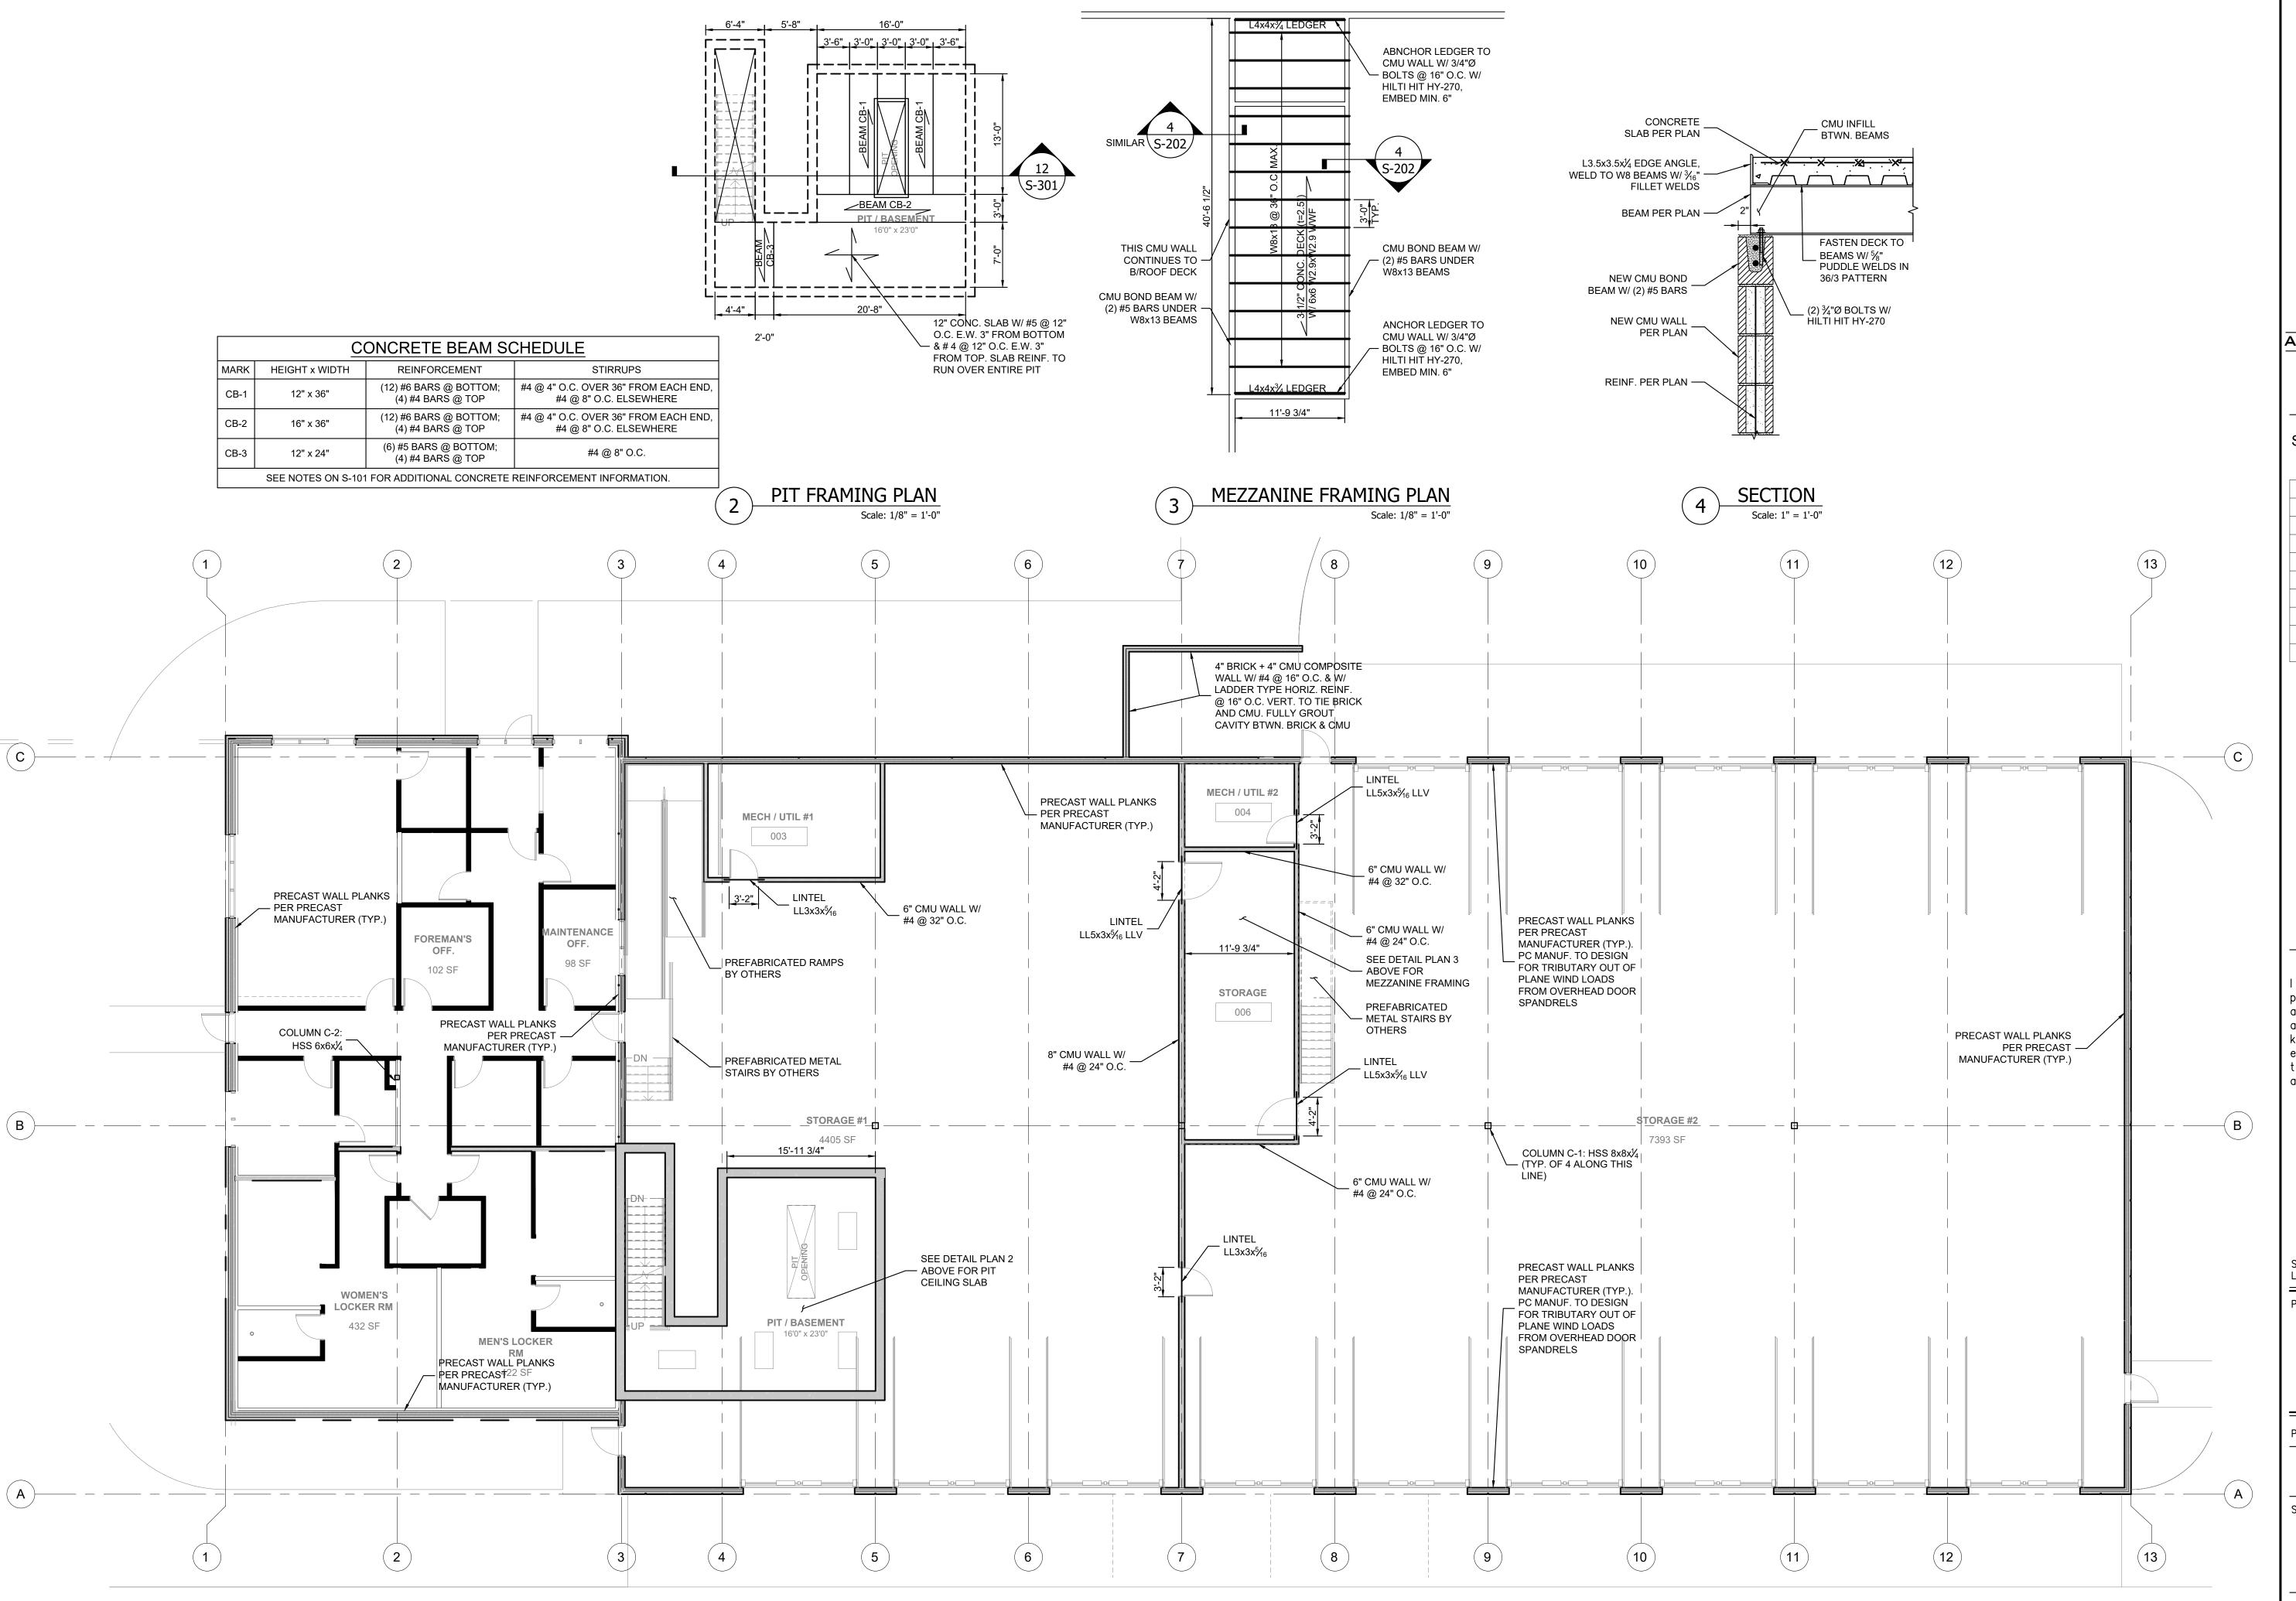



ANAX ENGINEERING, INC.

A STRUCTURAL ENGINEERS A
122 S. MICHIGAN AVE., SUITE 1390
CHICAGO, IL 60603
PHONE: 847-461-9006
EMAIL: INFO@ANAXENG.COM


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SHEET REVISIONS:

No. DATE NATURE OF REVISION

_	5-13-22	ISSUED FOR PERM	IIT

STATEMENT OF COMPLIANCE
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Signature Date: 5-13-2022 License Expires: 07-31-2022

PROJECT NAME:

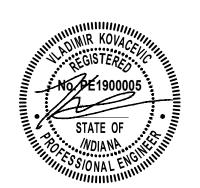Public Works Building Lake County Lowell, IN

PROJECT No.: 21024


ISSUED FOR PERMIT

SHEET NAME:

FLOOR PLAN

SHEET No.:

	STEEL BEAM SCHEDULE										
MARK	SECTION SIZE	MATERIAL	END CONDITION								
B-1	W24x62	Fy=50 ksi	AISC STD. SHEAR TAB								
B-2	W24x68	Fy=50 ksi	AISC STD. SHEAR TAB / P.C. EMBED PLATE								
B-3	W21x48	Fy=50 ksi	AISC STD. SHEAR TAB / P.C. EMBED PLATE								
B-4	W21x48	Fy=50 ksi	AISC STD. SHEAR TAB / P.C. EMBED PLATE								
B-5	W16x26	Fy=50 ksi	AISC STD. SHEAR TAB / P.C. EMBED PLATE								

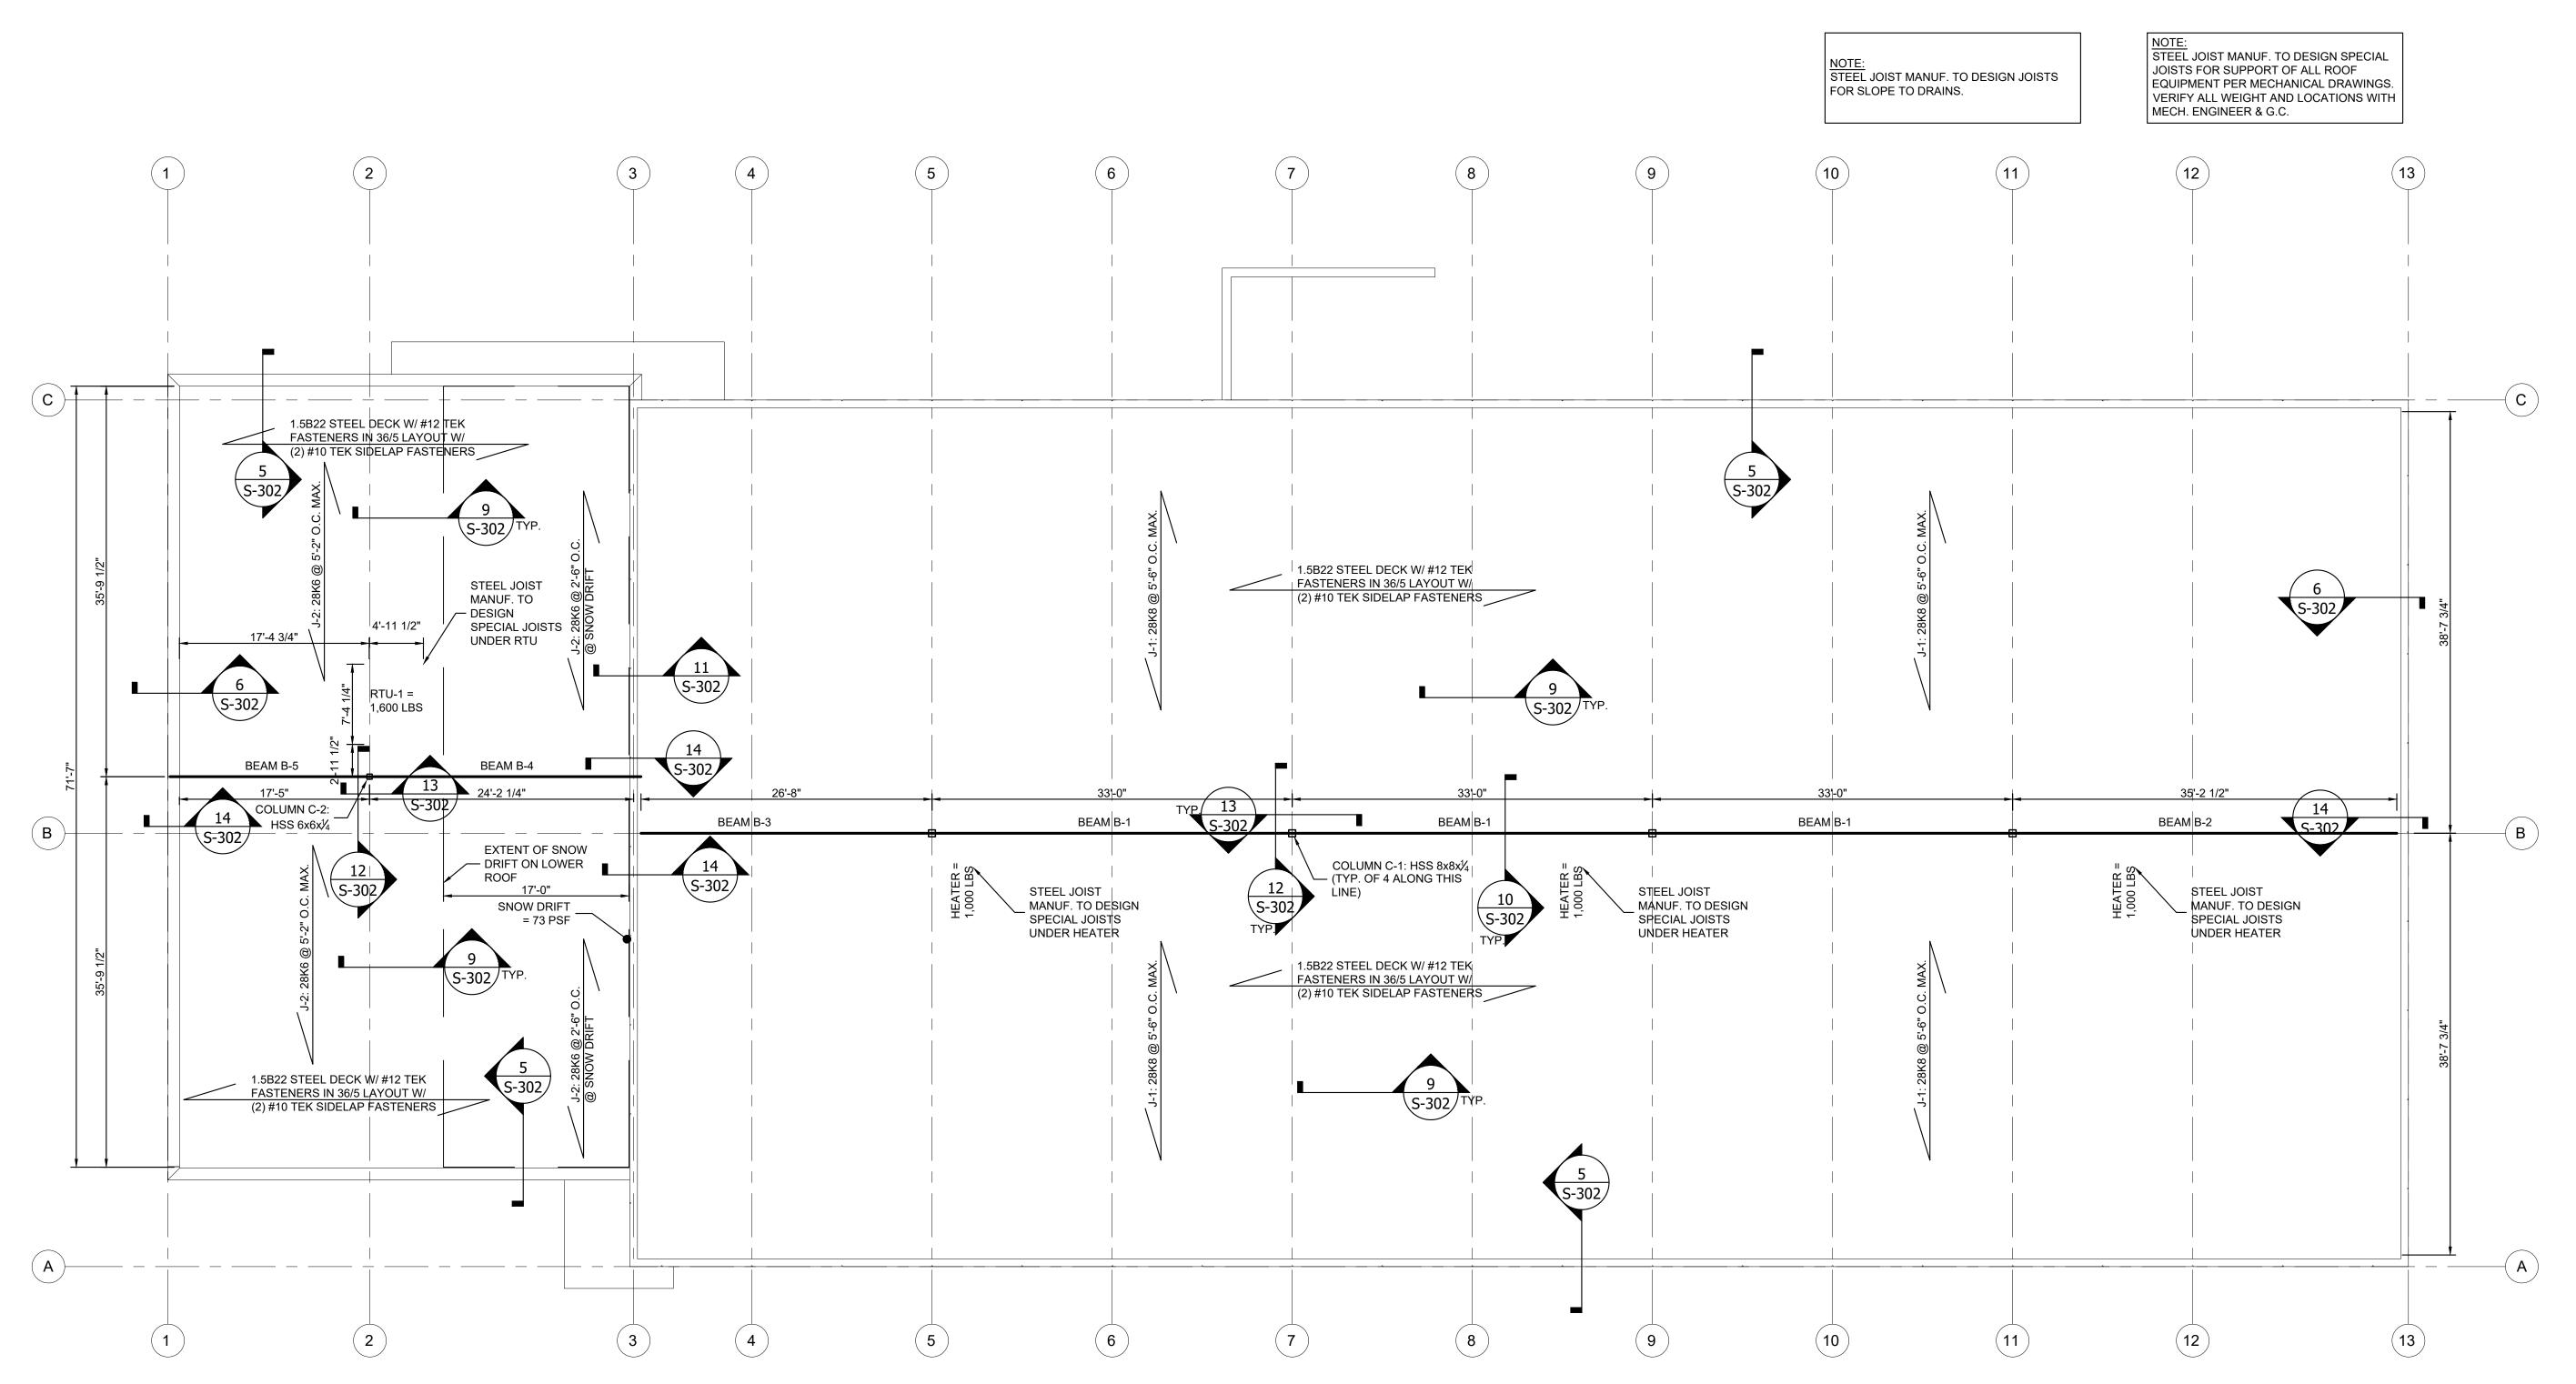



SHEET REVISIONS:

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	0-13-22

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Signature Date: 5-13-2022 License Expires: 07-31-2022

PROJECT NAME:

Public Works Building Lake County Lowell, IN


PROJECT No.: 21024

ISSUED FOR PERMIT

SHEET NAME:

ROOF PLAN

SHEET No.:

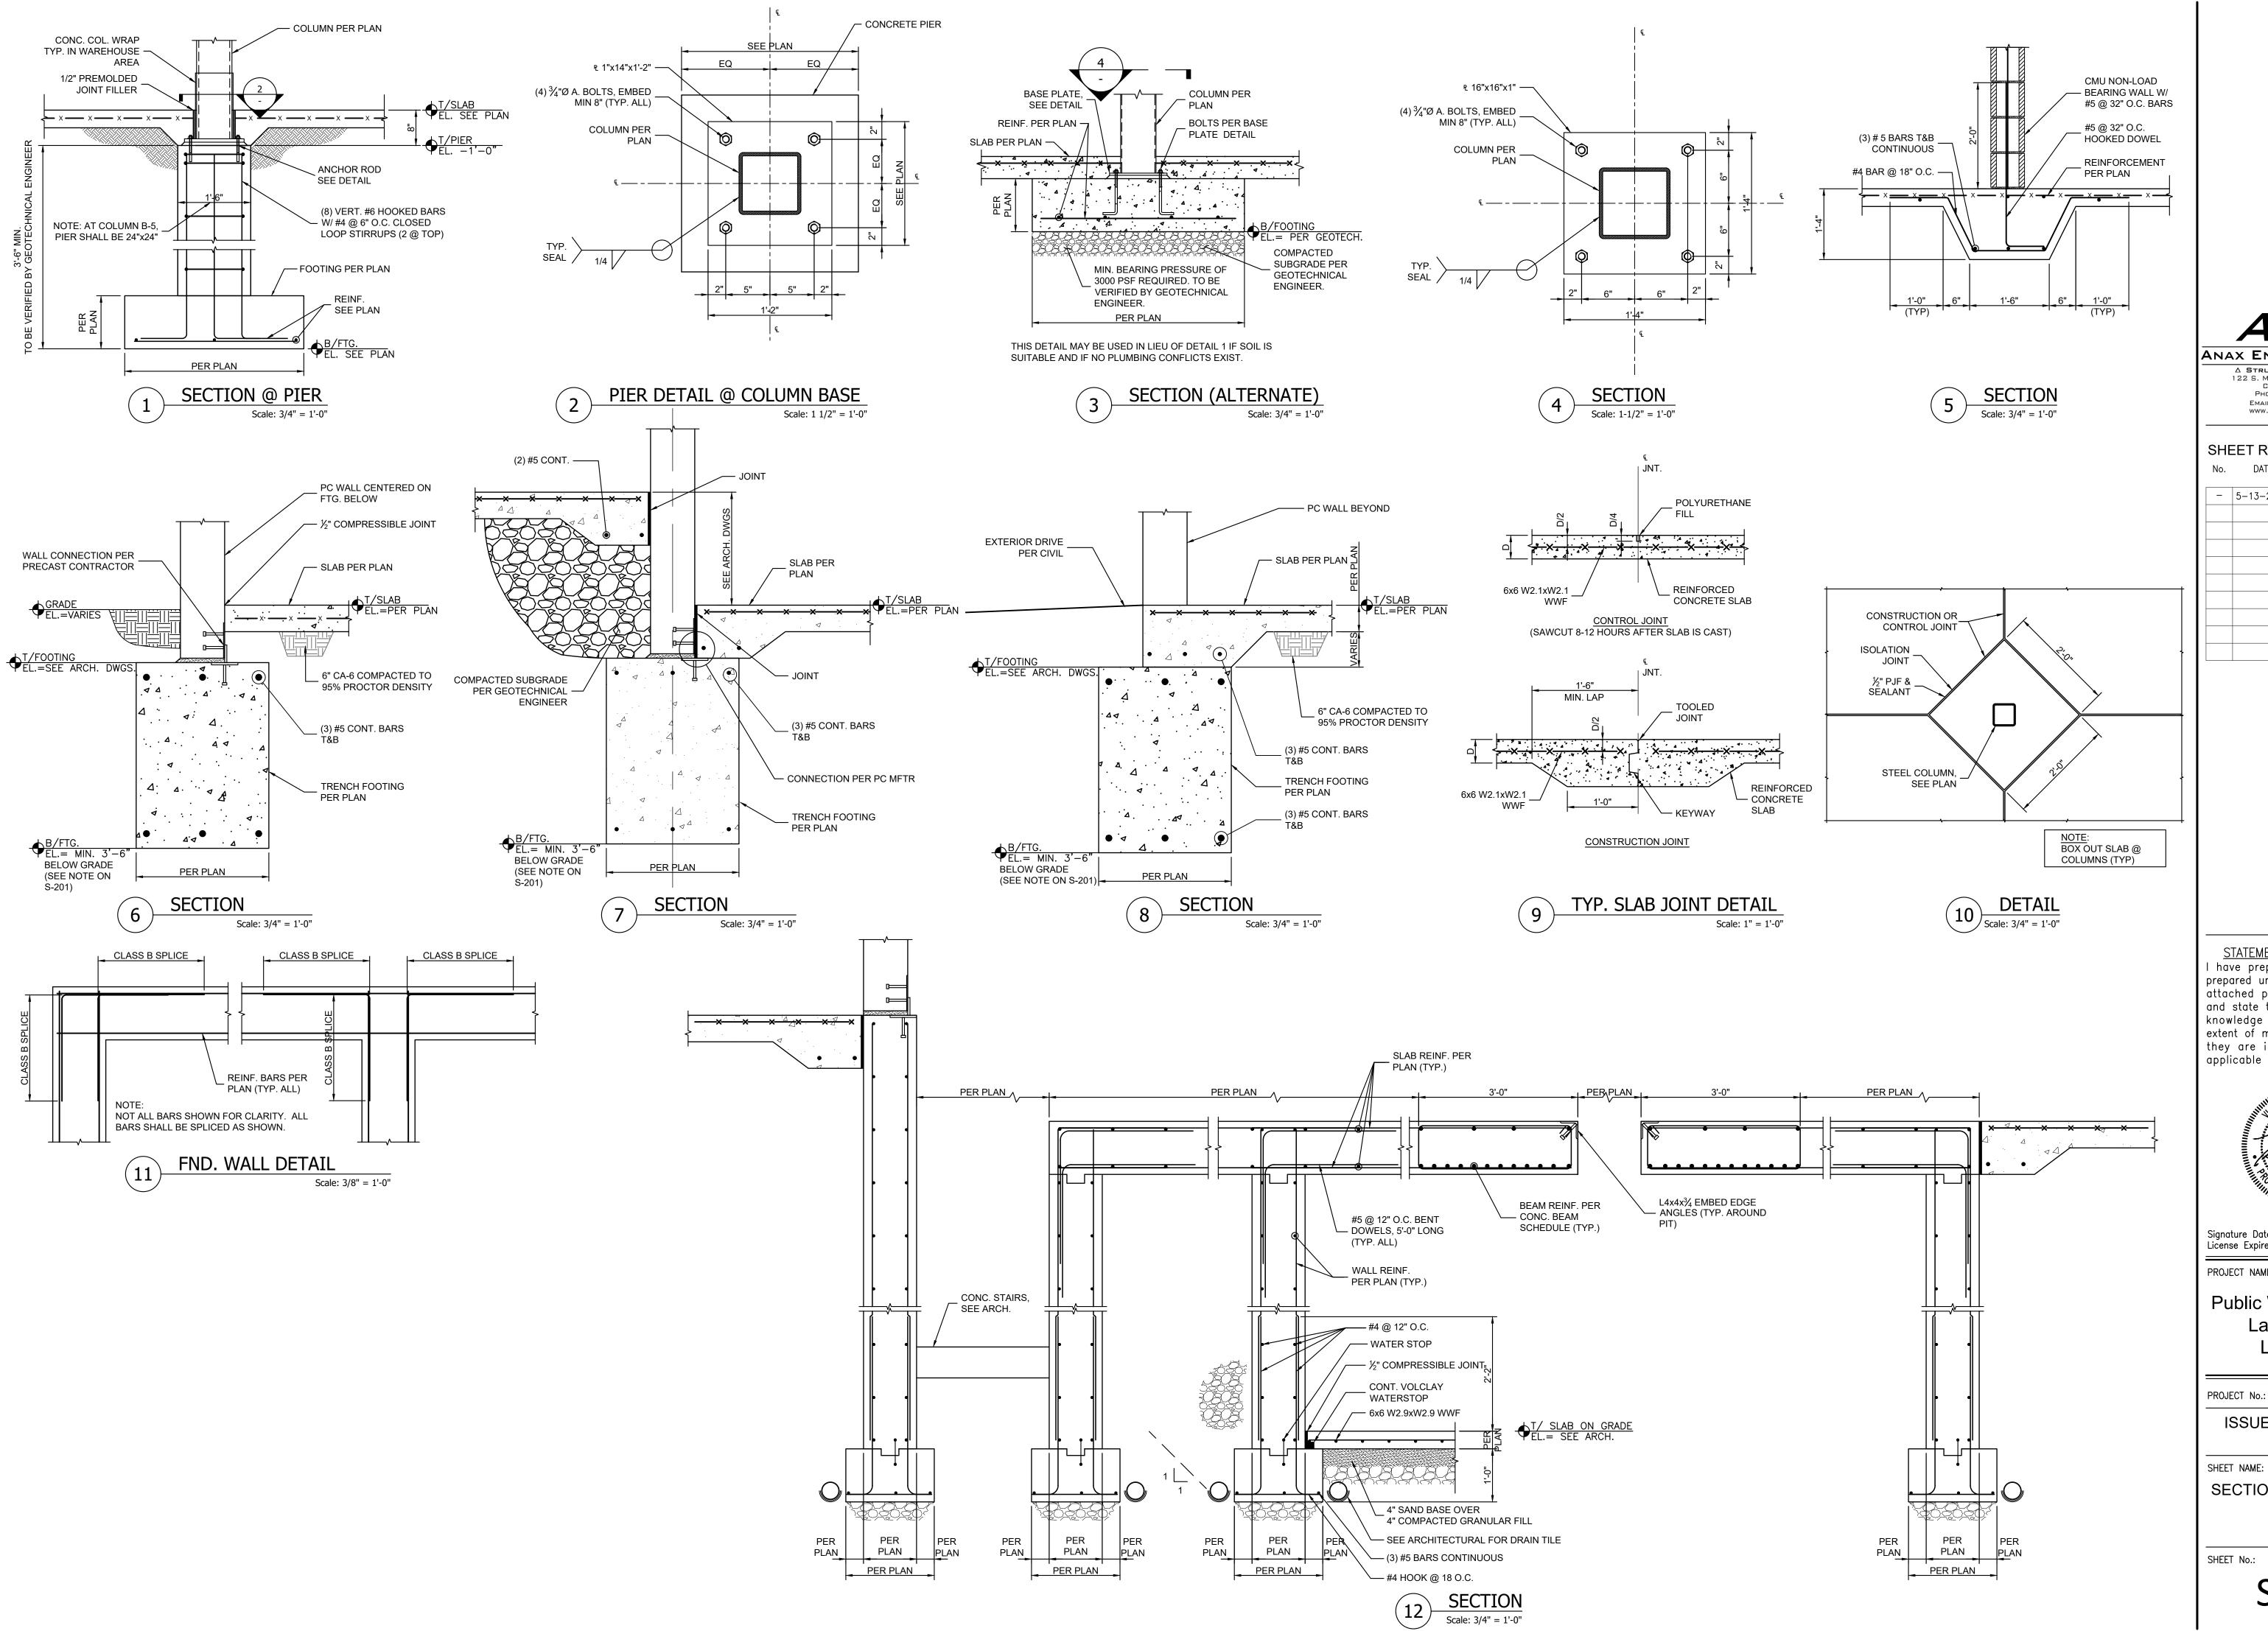



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SHEET REVISIONS:

DATE NATURE OF REVISION

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and state that, to the best of my knowledge and belief and to the extent of my contractual obligation, they are in compliance with the applicable Codes and Ordinances.



Signature Date: 5-13-2022 License Expires: 07-31-2022


PROJECT NAME:

Public Works Building Lake County Lowell, IN

PROJECT No.: 21024

ISSUED FOR PERMIT

SECTIONS AND DETAILS

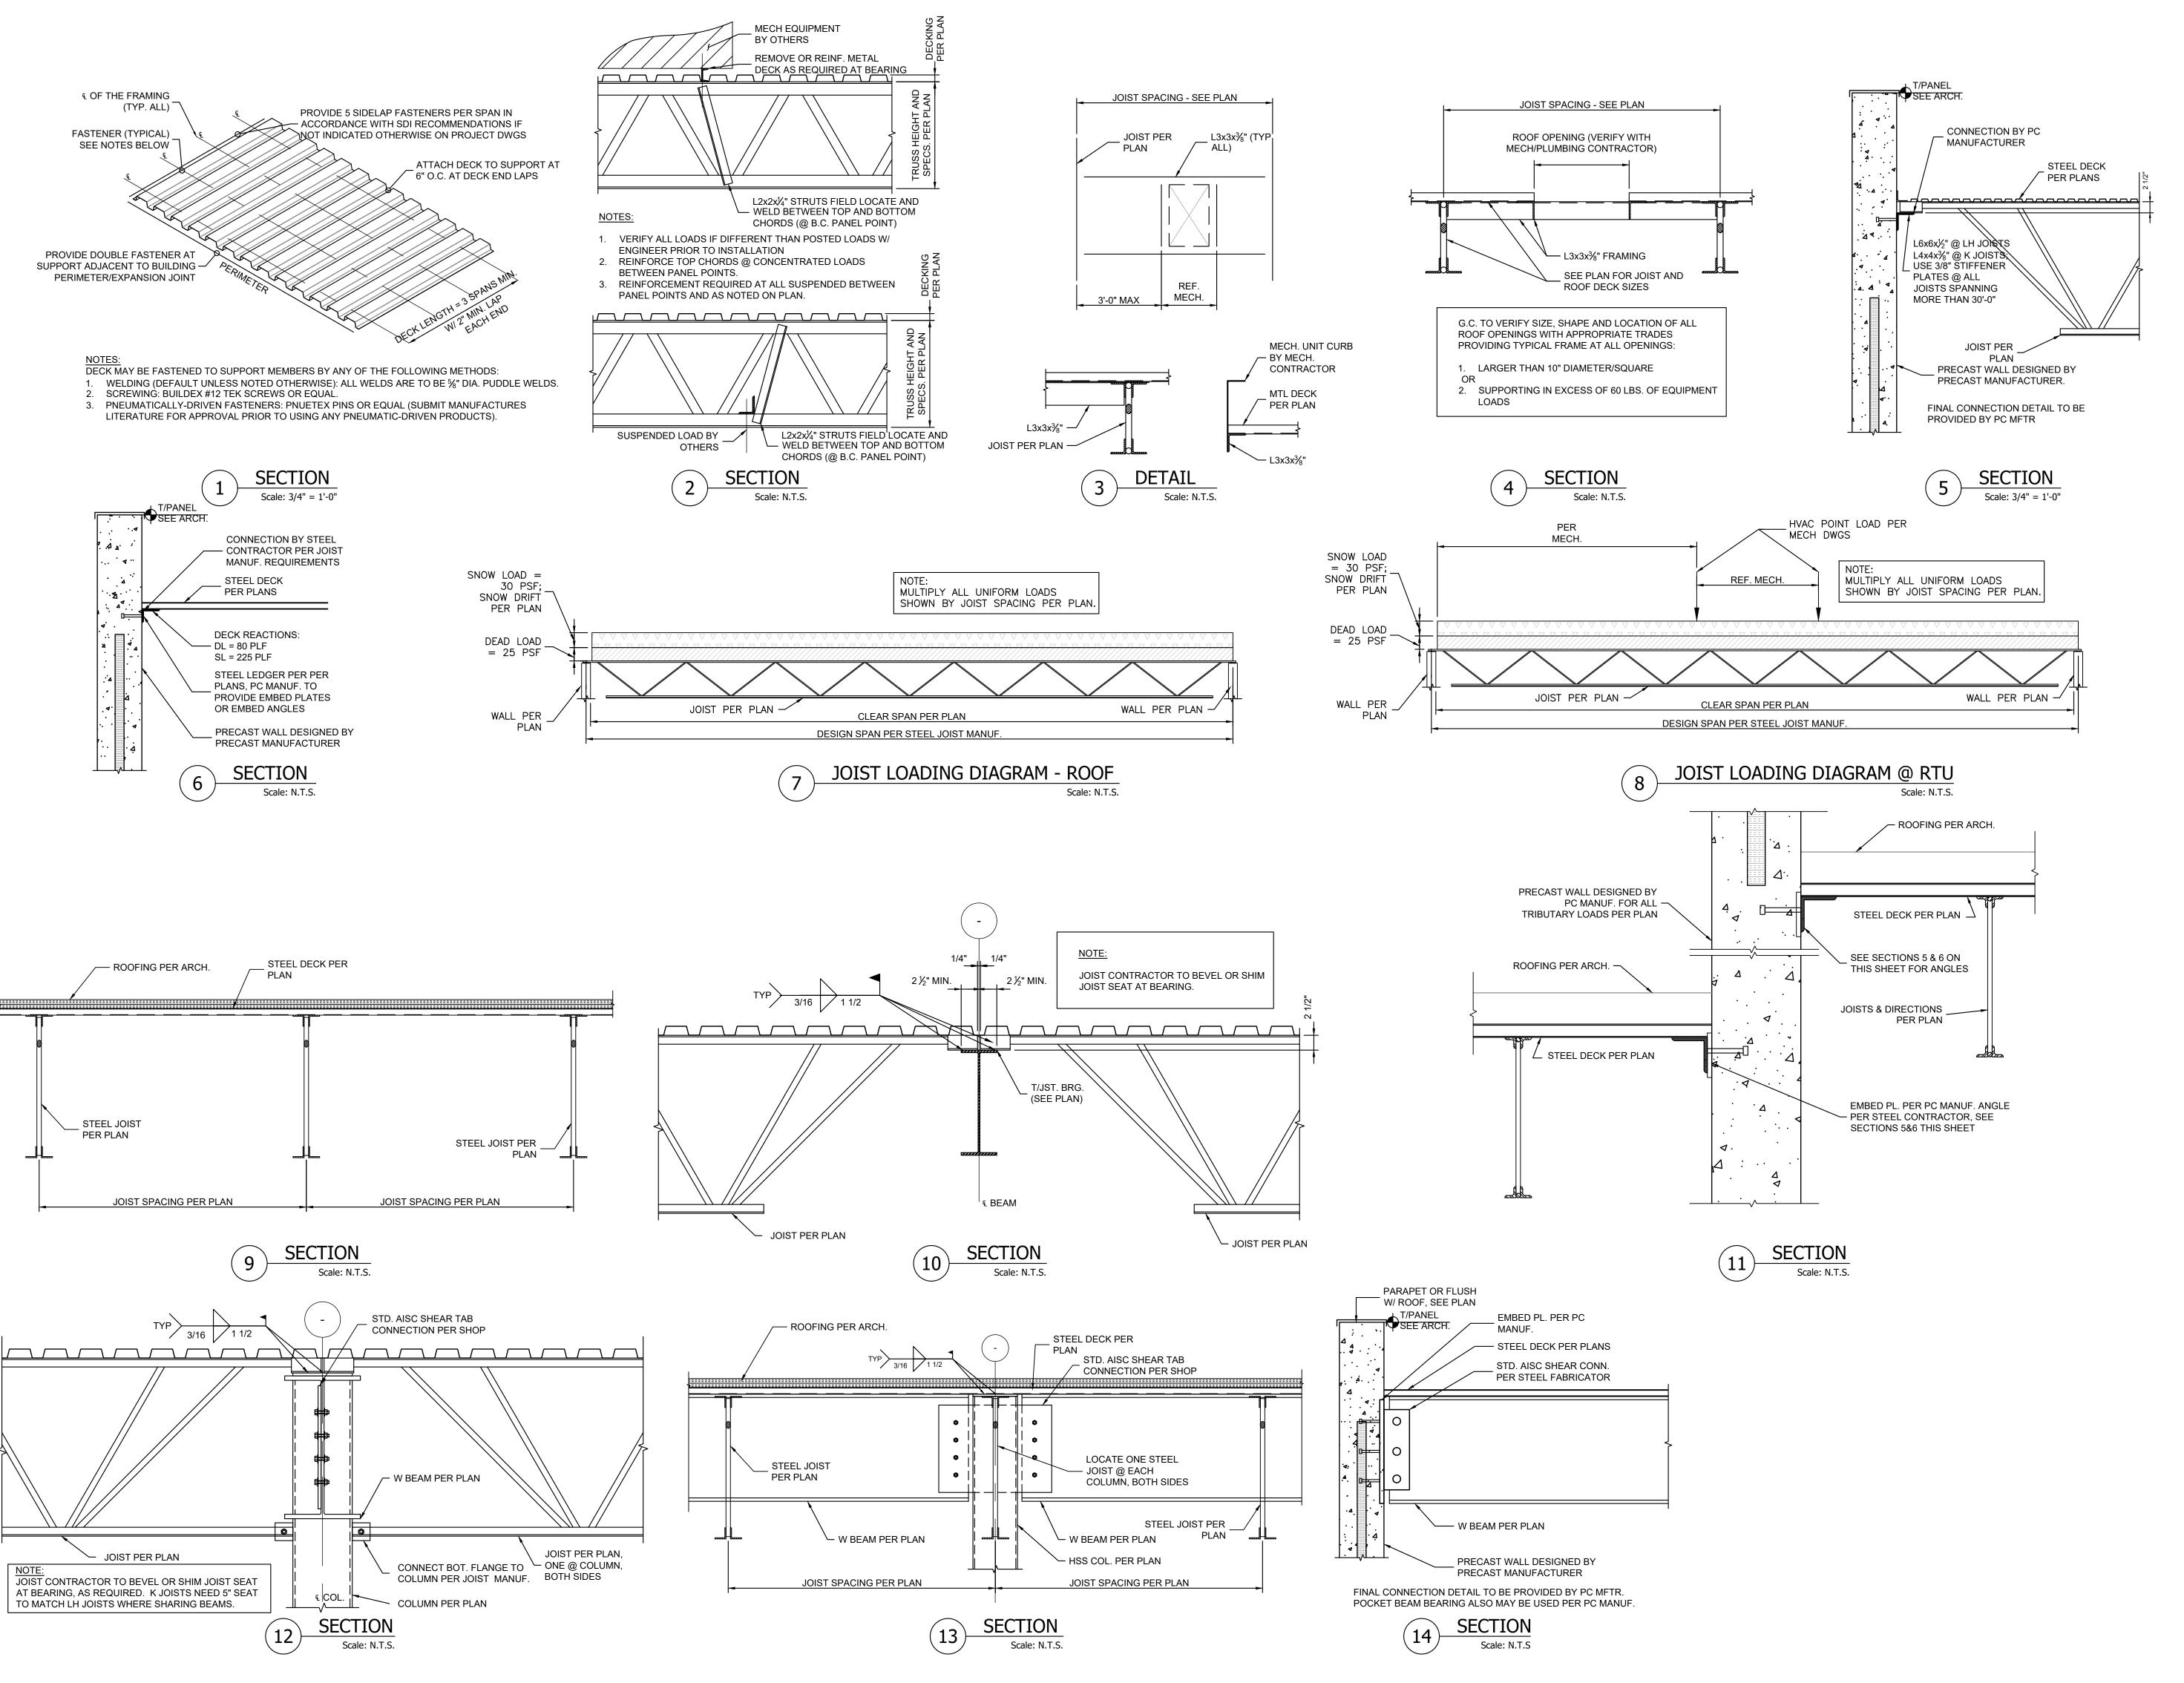



PHONE: 847-461-9006

EMAIL: INFO@ANAXENG.COM

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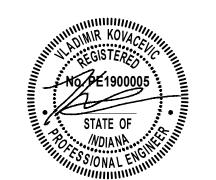
SHEET REVISIONS:

No. DATE NATURE OF REVISION

-	5-13-22	ISSUED FOR PERMIT

STATEMENT OF COMPLIANCE
I have prepared, or caused to be prepared under my supervision, the attached plans and specifications and state that, to the best of my knowledge and belief and to the extent of my contractual obligation,

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Signature Date: 5-13-2022 License Expires: 07-31-2022

PROJECT NAME:

Public Works Building Lake County Lowell, IN


PROJECT No.: 21024

ISSUED FOR PERMIT

SHEET NAME:

SECTIONS AND DETAILS (CONT.)

SHEET No.:

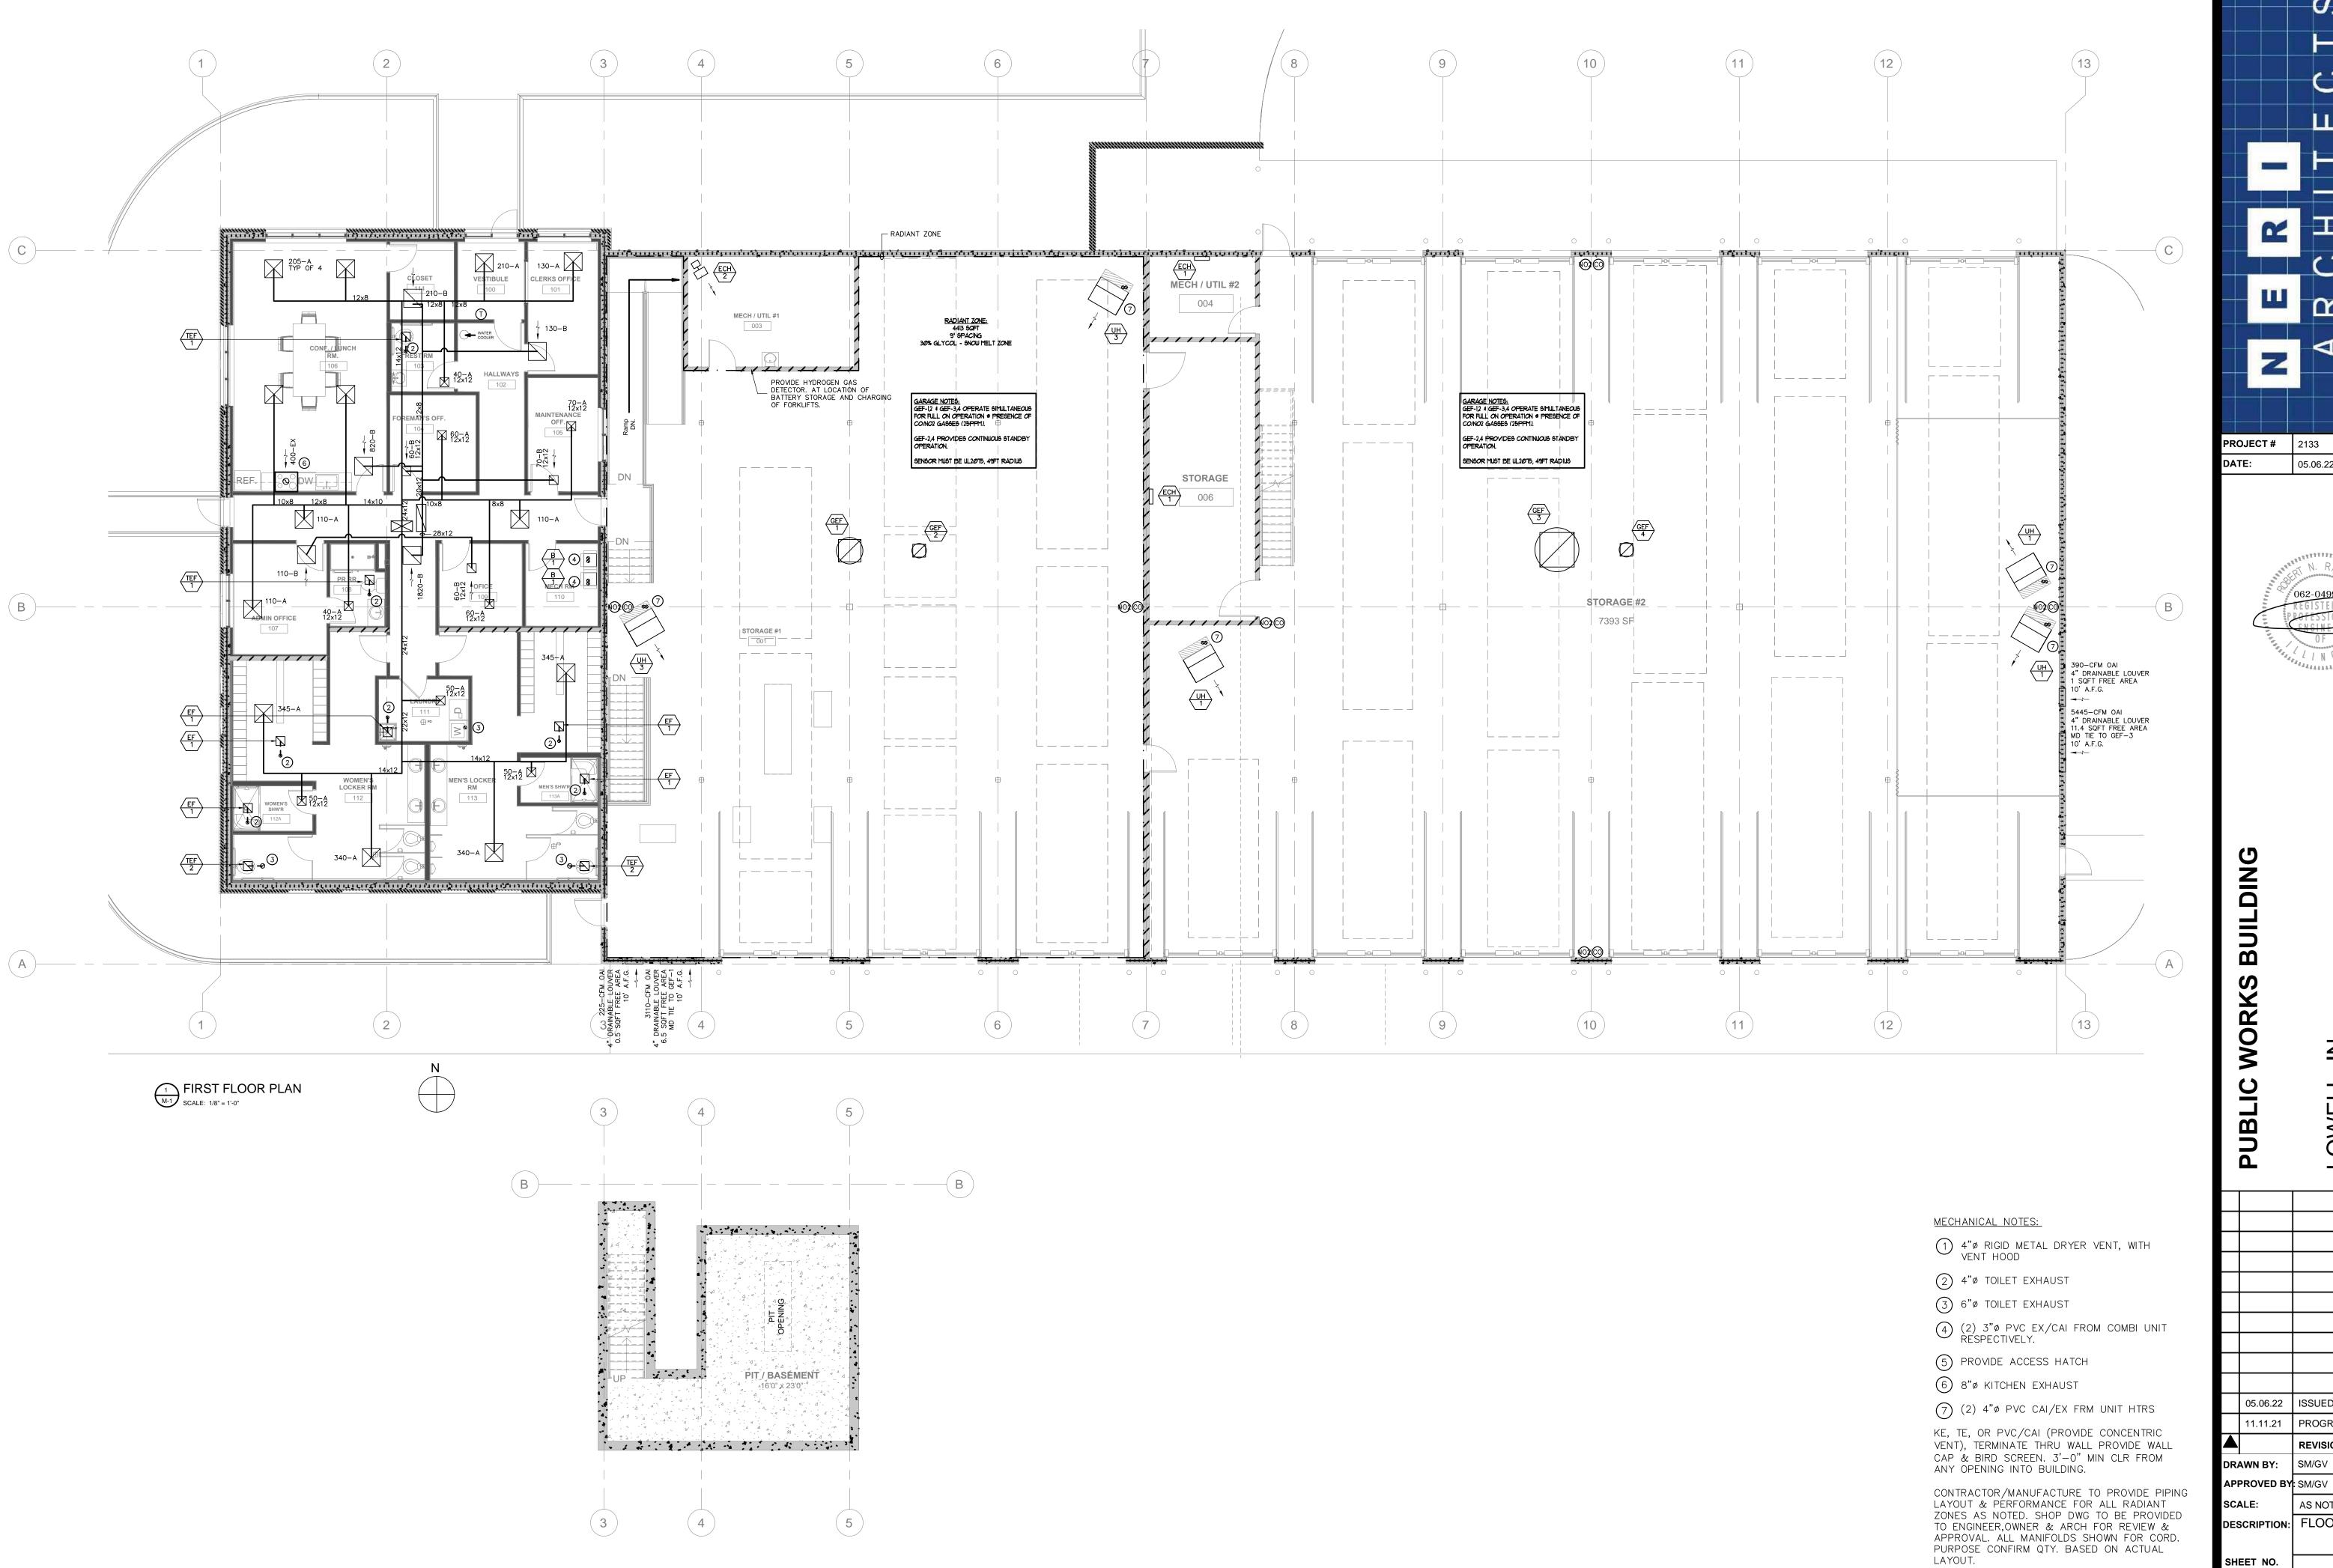

BASEMENT PIT
SCALE: 1/8" = 1'-0"

05.06.22




FOR REFERENCE LOWELL, IN LAKE COUNT

05.06.22 ISSUED FOR PERMIT 11.11.21 PROGRESS SET REVISIONS

SM/GV

AS NOTED DESCRIPTION: FLOOR PLAN(S)

M-1

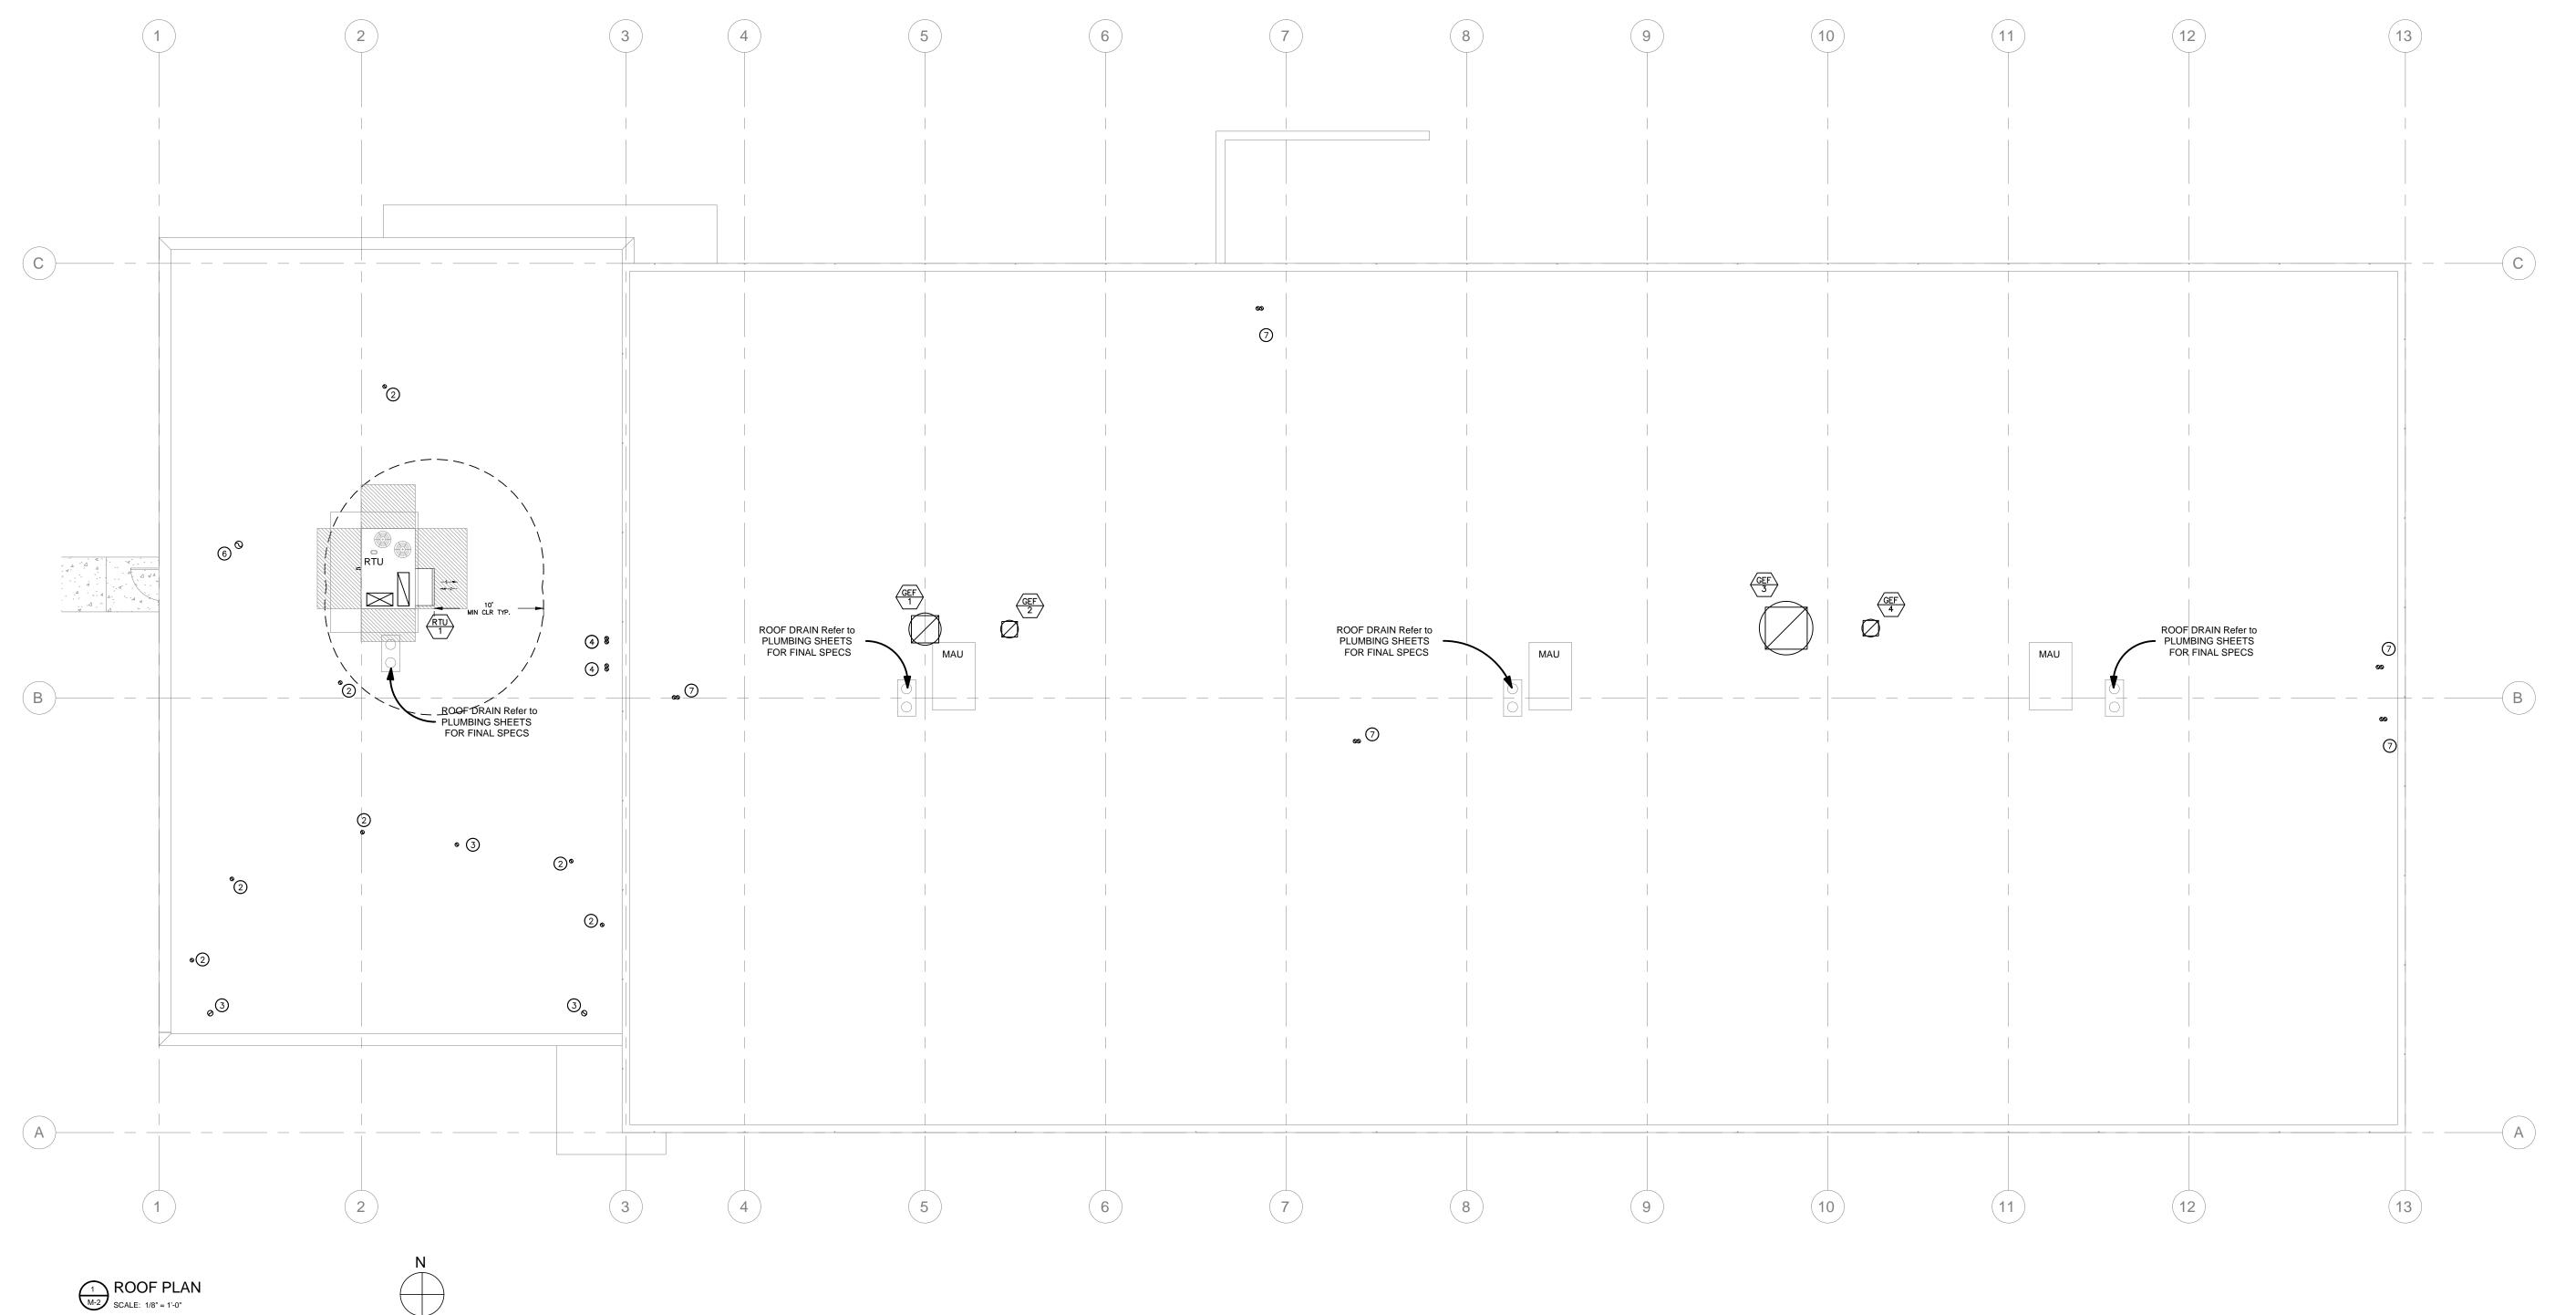


MECHANICAL NOTES:

- 1) 4"Ø RIGID METAL DRYER VENT, WITH VENT HOOD
- 2 4"ø TOILET EXHAUST
- 3 6"ø TOILET EXHAUST
- (2) 3"Ø PVC EX/CAI FROM COMBI UNIT RESPECTIVELY.
- 5 PROVIDE ACCESS HATCH
- 6 8"ø KITCHEN EXHAUST
- (2) 4"ø PVC CAI/EX FRM UNIT HTRS

KE, TE, OR PVC/CAI (PROVIDE CONCENTRIC VENT), TERMINATE THRU WALL PROVIDE WALL CAP & BIRD SCREEN. 3'-0" MIN CLR FROM ANY OPENING INTO BUILDING.

CONTRACTOR/MANUFACTURE TO PROVIDE PIPING LAYOUT & PERFORMANCE FOR ALL RADIANT ZONES AS NOTED. SHOP DWG TO BE PROVIDED TO ENGINEER, OWNER & ARCH FOR REVIEW & APPROVAL. ALL MANIFOLDS SHOWN FOR CORD. PURPOSE CONFIRM QTY. BASED ON ACTUAL LAYOUT.

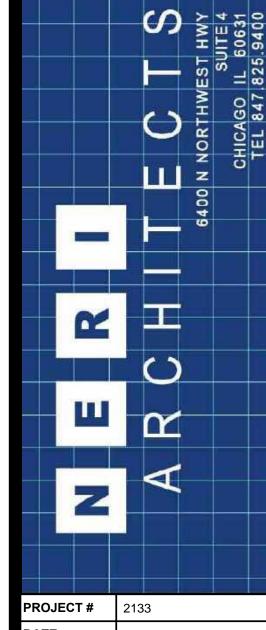

05.06.22



WORKS

OR REFERENCE LOWELL, IN LAKE COUNT

										
	05.06.22	ISSUED FOR PERMIT								
	11.11.21	PROGRESS SET								
		REVISIONS								
DR	AWN BY:	SM/GV								
API	PROVED BY	: SM/GV								
sc	ALE:	AS NOTED								
DES	SCRIPTION:	ROOF PLAN								

M-2

DIFFU	DIFFUSERS, REGISTERS, GRILLES, AND LOUVERS.										
REFER TO	REFER TO DRAWINGS FOR: A EXT AIR EXTRACTOR REFER TO ROOM FINISH										
1. DUCT SIZE OR NECK SIZE. ALB AIR LIGHT BOOT, PLENUM SCHEDULE AND REFLECTED											
2. FACE SIZE — i.e.: 8"(24x24). AND VOLUME DAMPER CEILING PLAN FOR PROPER											
3. PATTER	3. PATTERN (3-WAY,etc.) IF APPLICABLE. ASR ANTI-SMUDGE RING COORDINATING OF DIFFUSERS,										
4. CFM			AV	D AUTOM.	ATIC VOLU	ME DAMPER	GRILLES, AND REGISTERS.				
5. SYMBO	L		BW	E BAKED	WHITE EN	AMEL					
			EQ	E EQUALI	ZING GRID						
			FR-	-1 WITH 1-	-HOUR DA	MPER					
			MS	D MULTI :	SHUTTER [DAMPER					
			OB	D OPPOSE	ED BLADE	DAMPER					
			P	C PRIME	COAT						
SYBMOL	TYPE	MODEL	FRAME	DAMPER	FINISH		REMARKS				
А	SUPPLY	TITUS OMNI	LAYIN	OBD	BWE	24X24 SEE	NECK SCHEDULE				
В	RETURN	TITUS PAR	LAYIN	OBD	BWE	24x24 SEE I	NECK SCHEDULE				
С	C SUPPLY TITUS FTI-10 LAY IN OBD BWE 1"SLOT,1SLOT, 2FT LENGTH, 6"INLET/PLENUM										

CORDINATE LOCATIONS OF ALL DIFFUSERS, REGISTERS, GRILLES AND LOUVERS WITH ARCH PRIOR TO INSTALL, SS IN ALL WET AREAS

FOR OMNI 1	YPE DIFFUS	SER:			F	OR PAR T	YPE DIFFUSE	ER:				
SUPPL	Y AIR DIFFU	JSER NECK	SIZE SCHEE	DULE		SUPPLY AIR DIFFUSER NECK SIZE SCHEDULE						
FM RANGE	NECK	SIZE	TOTAL	DEMARKS	CF	M RANGE	NECK	SIZE	TOTAL			
T W TOTAL	SQUARE	ROUND	PRESSURE	REMARKS		W TOTAL	SQUARE	ROUND	PRESSURE	REMARK		
50-100	6" × 6"	6"ø	0.04	1		50-175	6" × 6"	6"ø	0.04	1		
100-200	9" x 9"	8"ø	0.04	1	1	75-275	8" x 8"	8"ø	0.04	\bigcirc		
200-300	10" x 10"	10"ø	0.04	1	2	275-375	10" × 10"	10"ø	0.04	\bigcirc		
300-450	12" x 12"	12"ø	0.04	1	1	375–600	12" x 12"	12"ø	0.04	\bigcirc		
500-750	15" x 15"	14"ø	0.04	1	6	500-750	15" x 15"	14"ø	0.04	\bigcirc		
500-1000	18" x 18"	16"ø	0.04	1	7	750-950	_	16"ø	0.04	$(\overline{})$		
			CEILING TYF	PE.	9	50-1350	18" x 18"	_	0.04	1		
COORI	DINATE WITH	l DIFFUSER	SCHEDULE.			(1) DIFFUSER SHALL BE LAY-IN CEILING TYPE.						

	CFM RANGE	NECK	SIZE	TOTAL	
RKS	OF WE TO WOL	SQUARE	ROUND	PRESSURE	REMARKS
	50-175	6" × 6"	6"ø	0.04	1
	175-275	8" x 8"	8"ø	0.04	1
	275-375	10" x 10"	10"ø	0.04	\bigcirc
	375-600	12" x 12"	12"ø	0.04	\bigcirc
	600-750	15" x 15"	14"ø	0.04	1
	750-950	_	16"ø	0.04	1
	950-1350	18" x 18"	<u> </u>	0.04	1

(1)	DIFFUSER SHALL BE LAY—IN CEILING TYPE. COORDINATE WITH DIFFUSER SCHEDULE.	
\circ	COORDINATE WITH DIFFUSER SCHEDULE.	

	EXHAUST FAN SCHEDULE											
UNIT	MODEL	AREA	CFM	S.P. IN	FPM	FAN	DRIVE		МОТ	OR		REMARKS
No.		SERVED		W.G.		RPM		HP	RPM	VOLT	PHASE	
TEF/EF-1	Panasonic FV0511VK1	TOILET RMS	80	0.10	_	659	DD	16.1W	1205	120	1	NOTE 1
TEF-2	Panasonic FV1115VK1	Toilet RMS	150	0.5	_	832	DD	21.7W	904	120	1	NOTE 1
GEF-1	GREENHECK G180VG	GARAGE	3110	0.2	_	861	DD	3/4	861	208	1	NOTE 2
GEF-2	GREENHECK G070VG	GARAGE	225	0.2	_	1334	DD	1/15	1334	115	1	NOTE 2
GEF-3	GREENHECK GB330VG	GARAGE	5445	0.2	_	293	BD	1	291	208	1	NOTE 2
GEF-4	GREENHECK G095VG	GARAGE	390	0.2	_	984	DD	1/6	984	208	1	NOTE 2
KEF-1	OWNER PROVIDED	BREAK RM	<400	_	_	_	DD	_	_	_	_	8"ø

NOTE 1: WALL SW, HUMIDITY SENSOR, ROOF CAP,INSULATED DAMPER & PROVIDE FABRIC FLEX CONNECTION FOR THERMAL BREAK AT EXTERIOR PENETRATION, WIRED TO TIMER NOTE 2: BS,DS
NOTE 3: PROVIDE 4" VENT/WALL LOUVER

		CABINET/UNIT HEATER SCHEDULE											
	LFV — LOUVER FIN (VERTICAL) H — HORIZONTAL TYPE FG — FAN GUARD LFH — LOUVER FIN (HORIZONTAL) P — PROTECTION TYPE LCD — LOUVER CONE DIFFUSER										SER		
•	UNIT No.	UNIT DESCRIPTION	LOCATION	HP	RPM	MOTOR VOLT	PHASE	TOTAL KW	AMPS	CFM @ FINAL AIR	G/ INPUT	AS OUTPUT [BTU]	REMARKS
-	ECH-1	MARKEL F3422	VARIES	9.6A	1400	208	1	2.0	_	TEMP. 245	-	_ [BIO]	124
	ECH-2	MARKEL UH Series	VARIES	9.2A	_	208	3	3.3	_	400	_	-	1 2 4 WALL BRACKET
	UH-1	MODINE PTC 260	VARIES	3/4	1125	208	3	ı	6.06	4585	260	252.2	1 2 4 5 6 ISOLATION HANGERS
	UH-2	MODINE PTC 215	VARIES	1/2	1075	208	3	ı	5.06	3865	215	202.1	1 2 4 5 6 ISOLATION HANGERS
	UH-3	MODINE PTC 156	VARIES	1/8	1440	208	3	_	3.73	2600	155	144	1 2 4 5 6 ISOLATION HANGERS

1) UNIT MTD. THERMOSTAT. 3 4-WIRE SERVICE

(5) 60° DEFLECTOR HOOD

MCFS-MIN. CIRCUIT FUSE SIZE FLA—FULL LOAD AMP *CORD COLOR W/ARCH

② UNIT MTD. DISCONNECT SW 4 LOW-VOLTAGE CONTACTOR 6 4"Ø CAI AND EX PVC, PROVIDE DRIP LEG AND CONDENSATE DRAIN CONNECTION (VERTICAL 2PIPE FOR FLAT ROOFS)

UNIT HEATERS SHALL BE INSTALLED IN ACCORDANCE WITH THE LISTING AND THE MANUFACTURER'S INSTALLATION INSTRUCTIONS. SUSPENDED TYPE HEATERS SHALL BE SUPPORTED BY ELEMENTS TAHT ARE DESIGNED TO ACCOMMODATE THE WEIGHT AND DYNAMIC LOADS. HANGERS AND BRACKETS SHALL BE OF NON—COMBUSTIBLE MATERIAL. IMC 2012 SECTION 920


SYMBOL 8 8 8	DESCRIPTION DIGITAL INPUT ANALOG INPUT	SINGLE LINE	VEN TOUBLE LINE	TILATION SYMBOLS		CHANICAL SYMBOLS
8 8	DIGITAL INPUT	SINGLE LINE	DOUBLE LINE			
8			BOODLE LINE	DESCRIPTION	SYMBOL	DESCRIPTION
8	ANALOG INPUT	20 x 12	20 x 12	NEW DUCTWORK — WxD AIRWAY DIMENSIONS	Ψ	PRESSURE GAUGE AND COCK
88				DUCT SECTION — SUPPLY UP		STRAINER
<u></u> ♣	DIGITAL OUTPUT			SOFTET OF		STRAINER W/BLOW-OFF VALVE
晃 │	ANALOG OUTPUT			DUCT SECTION — SUPPLY DOWN		THERMOMETER
_	CONTROL VALVE (ELECTRICAL)			DUCT SECTION — RETURN OR EXHAUST UP	P/T †	PRESSURE / TEMPERATURE SENSOR
	CONTROL VALVE (PNEUMATIC) DIFFERENTIAL PRESSURE SWITCH			DUCT SECTION — RETURN OR EXHAUST DOWN	 	CAP UNION
	VARIABLE SPEED CONTROLLER			DUCT SECTION — SUPPLY UP/DN	= <u>×</u> =	ANCHOR W/ALIGNMENT GUIDES
	NORMALLY OPEN	$+ R \longrightarrow +$	- R	INCLINED RISE W/RESPECT TO AIR FLOW		EXPANSION JOINT FLEXIBLE CONNECTION
	NORMALLY CLOSED	 	<u></u>	INCLINED DROP W/RESPECT TO AIR FLOW		PRESSURE RED. VALVE
ES	END SWITCH	 	11 /2 11	INCLINED DIVOL WYNESI ECT TO AIR TEOW		RELIEF VALVE
-m	MOTOR OPERATED DAMPER			FLEXIBLE CONNECTION TO EQUIPMENT		TRIPLE DUTY VALVE
	VELOCITY SENSOR	48x24 📆	48x24	LOUVER & SCREEN WXD GROSS OPENING		CHECK VALVE (SP) SPRING BALANCING VALVE
\sim				FLEXIBLE DUCT		GLOBE VALVE
	TEMPERATURE SENSOR HUMIDITY SENSOR		ļ <u> </u>	PLEXIBLE DOCT 		GATE VALVE
\simeq	DIFFERENTIAL PRESSURE SENSOR	L M	 	·	⊸ 5 —	BUTTERFLY VALVE - WHEN DIA. >
_	SMOKE DETECTOR	—		MOTORIZED DAMPER	. F.M	BALL VALVE - WHEN DIA. < 2
	BBREVIATIONS	—		SPLITTER DAMPER	<u> </u>	VALVE WITH MEMORY STOP GAS COCK
SYMBOL	DESCRIPTION	— ¬BDD	BDD	BACK DRAFT DAMPER (GRAVITY)		CONTROL VALVE, 2-WAY
	FIRE DAMPER		FD }	FIRE DAMPER, SLEEVE & ACCESS DOOR		CONTROL VALVE, 3-WAY
	HORSE POWER			AIR EXTRACTING VANES		CIRCUIT SETTER
	EXPANSION VAVLE	r _{kk}		TURNING VANES DOUBLE THICKNESS	BF	CODE BACKFLOW PREVENTOR UNIT HEATER — HORIZONTAL
	THOUSAND BRITISH THERMAL UNITS	_ '		TURNING VANES. DOUBLE THICKNESS AIRFOIL TYPE.		PIPE DOWN
	MANUFACTURER MOUNTED	SYSTEM RISER NO.	SYSTEM RISER NO.	RISER MARK	<u> </u>	PIPE UP
	PHASE			THERMOSTAT 7-DAY PROGRAMMABLE (G) W/GUARD		NEW PIPING
	REVOLUTIONS PER MINUTE	S	S	SENSOR		PIPING ASSEMBLY — SEE DETAIL
T-STAT	THERMOSTAT	\bigcirc	\bigcirc	HUMIDISTAT		VENT (MANUAL OR AUTOMATIC)
	VOLTS VELOCITY	700-R 20x12	700-R 20x12	EXHAUST OR RETURN AIR REGISTER		FLOW CONTROL FITTING
W.C.	INCHES IN WATER COLUMN				□ FI	FLOW INDICATOR
	TRANSFER GRILLE DOWN	700-S 20* di a.	700-S 20" di a.	ROUND CEILING SUPPLY DIFFUSER	 O-FS	FLOW SWITCH
	CUBIC FEET PER HOUR	700-S 20x12	700-S 20x12	RECTANGULAR CEILING SUPPLY DIFFUSER	PS	PRESSURE SWITCH
	GEOEXCHANGE PIPE SUPPLY			SIDE WALL SUPPLY RECISTER W///OLLIME		BASE MOUNTED PUMP - SEE DETAIL
	GEOEXCHANGE PIPE RETURN	700-S 20x12	700-S 20x12	SIDE WALL SUPPLY REGISTER W/VOLUME DAMPER	P——	IN-LINE PUMP - SEE DETAIL
	COMBUSTION AIR INTAKE ROUND BACKDRAFT DAMPER	24×18 DG	24×18 DG	DOOR GRILLE W/BUILT-IN FIRE DAMPER		EQUIPMENT (SPECIFIED BY TAG BELOV
TYP	TYPICAL			IF LOCATED ON A FIRE DOOR.	TAG #	EQUIPMENT TAG W/NUMBER
	SUPPLY AIR DUCT		<i>"</i> """""""""""""""""""""""""""""""""""	LINEAR DIFFUSER W/BOOT. NO VOLUME DAMPER IN BOOT.		DRAIN LINE
	RETURN AIR DUCT EXHAUST AIR DUCT	\bowtie	\bowtie	AIR VALVE	G	GAS LINE VENT LINE
	OUTSIDE AIR		₽ ■	TERMINAL UNIT-VARIABLE VOLUME INTEGRAL DIFFUSER	нws	HOT WATER HEATING SUPPLY
	CEILING DIFFUSER	₩		UNDERCUT DOOR MINIMUM 1"	—HWR —	HOT WATER HEATING RETURN CHILLED WATER HEATING SUPPLY
	CUBIC FEET PER MINUTE			BOOK MOUNTED BOWER OF CONTRA	——CHWR—	CHILLED WATER HEATING RETURN
	ABOVE FINISHED FLOOR			ROOF MOUNTED POWER OR GRAVITY ROOF VENTILATOR	——SL ——	REFRIGERANT SUCTION LINE
A.F.G.	ABOVE FINISHED GRADE			ROOF MOUNTED AIR INTAKE	—LL ——	REFRIGERANT LIQUID LINE CONDENSATE RETURN LINE
	CAPACITY				CDW	CONDENER WATER LINE
CAP.	CEILING		 	ELECTRIC DUCT HEATER		

NOTE: NOT ALL SYMBOLS ARE APPLICABLE TO THIS PROJECT.

											ROOF	TOP U	NIT SO	CHEDU	LE								
TAG	LOCATION		SUPPLY ,	AIR DATA		POW	VER EX. D	ATA			С	COOLING CO	OIL DATA			HEATING COIL DATA		ELECTRIC	AL DATA		MODEL	WEIGHT	REMARKS
RTU-	LOCATION	CFM	O.A.	ESP	BHP	CFM	ESP	HP	EAT/DB	EAT/WB	LAT/DB	LAT/WB	TMBH	SMBH	NOM.CAP. TON	INP/OUT (MBH)	MCA	MOCP	VOLT	PH	MODEL	WEIGHT [LBS]	REMARKS
1	ROOF	3400	604	0.7	1.43	3400	0.25	1	95	78.6	55.8	54.8	100.5	83.7	8.5	120/148	42	50	208	3	Carrier 48TC09	1347	SEE NOTES 1

NOTE 1: COOLING CAPACITY AT 95F AMBIENT, ASHRAE 90.1 COMPLIANT, GAS FIRED, FILTER INDICATOR, CO2 CONTROLS, MODULATING CENTRIFUGAL POWER EXHAUST, SS DRAIN PAN, DISCONNECT SWITCH, CONVENIENCE OUTLET. 7-DAY PROGRAMMABLE T-STAT., VFD CONTROLLER, ECONOMIZER FAULT DETECTION,

THE EQUIPMENT SHALL BE INSTALLED IN ACCORDANCE WITH THE MANUFACTURER'S INSTALLATION INSTRUCTIONS. THESE INSTRUCTIONS SHALL BE ON-SITE AND AVAILABLE FOR ALL INSPECTIONS.

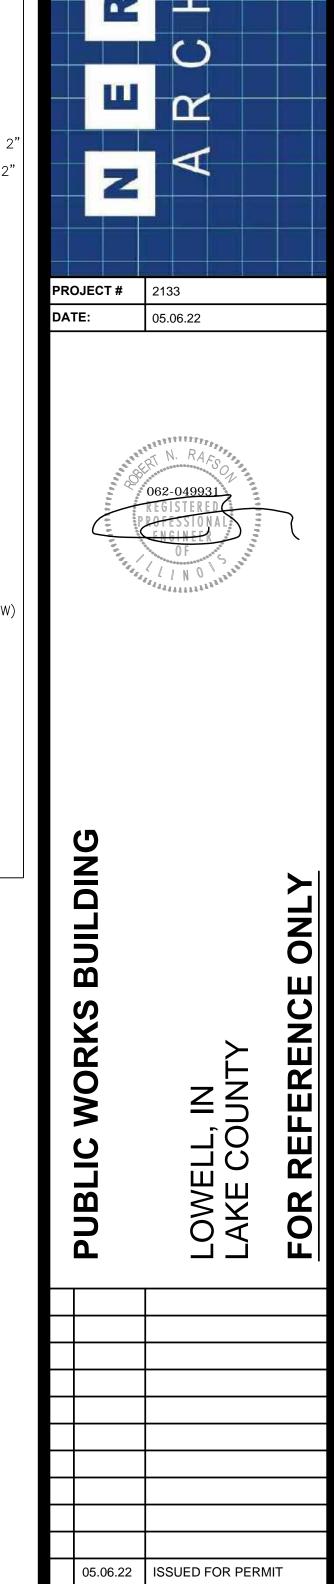

11.11.21 PROGRESS SET

DRAWN BY:

SHEET NO.

APPROVED BY: SM/GV

REVISIONS

AS NOTED

DESCRIPTION: MECH SCHEDULES,

NOTES & DETAILS

M-3

MGC2 SERIES CONTROL PANEL & AT-1130/LC-1112 GAS TRANSMITTERS

PART 1 - GENERAL

- 1.1 SCOPE: WORK UNDER THIS SECTION OF THE SPECIFICATIONS SHALL INCLUDE THE FURNISHING AND INSTALLATION OF A COMPLETE GAS MONITORING AND CONTROL SYSTEM INCLUDING ALL RELATED ACCESSORIES.
- 1.2 SUBMITTALS: FURNISH SUBMITTAL DATA FOR THE FOLLOWING MATERIALS AND EQUIPMENT
- 1. GAS MONITORING AND CONTROL SYSTEM.
- 2. ALL RELATED DEVICES.

PART 2 - PRODUCT SPECIFICATIONS

- 2.1 CONTROL PANEL
- A. THE CONTROL PANEL SHALL PROVIDE CONTINUOUS MONITORING OF THE DESIGNATED GAS LEVELS IN THE ASSIGNED AREA AND CONTROL THE VENTILATION SYSTEM VIA DIGITAL OUTPUTS IN ACCORDANCE WITH ALL APPLICABLE CODES AND STANDARDS.
- B. THE CONTROL PANEL SHALL HAVE THE ABILITY TO INTERFACE VIA ANALOG OR DIGITAL OUTPUTS TO ANY COMPATIBLE ELECTRONIC ANALOG CONTROL, DDC/PLC CONTROL OR AUTOMATION SYSTEM. THE CONTROL PANEL SHALL HAVE THE CAPABILITY TO ACCEPT ANY COMBINATION OF 4-20 MA TRANSMITTERS PROVIDED BY INTEC CONTROLS (A RELEVANT SOLUTIONS BRAND)
- C. THE CONTROL PANEL SHALL ACCEPT UP TO 12 ANALOG INPUTS WITH FOUR (4) DIGITAL INPUTS. EACH ANALOG INPUT CAN HAVE FIVE (5) TRIP/SET-POINTS.
- D. THERE SHALL BE FIVE (5) RELAY OUTPUTS FOR EVERY FOUR (4) ANALOG INPUTS AND TWO (2) INDEPENDENT 4—20 MA OUTPUTS AVAILABLE. THE OUTPUTS SHALL BE PROGRAMMABLE IN THE FIELD. EACH OF THE SENSING POINTS IS READILY ADDRESSABLE TO EITHER OF THE (2) ANALOG OUTPUTS BY SELECTING THE MINIMUM, MAXIMUM, OR AVERAGE VALUE.
- E. THE ALARM SHALL BE ACKNOWLEDGED BY AN EXTERNAL MANUAL RESET SWITCH VIA THE DIGITAL INPUT OR THROUGH THE CONTROL PANEL MENU.
- F. THE CONTROL PANEL SHALL HAVE STATUS INDICATOR LED'S LOCATED ON THE FRONT; RED = FAIL, YELLOW = ALARM.
- G. THE CONTROL PANEL SHALL INCLUDE A TWO LINE, BACKLIT LCD DISPLAY OF 16 CHARACTERS, AT 1 DIGIT RESOLUTION.
- H. THE CONTROLLER SHALL BE NRTL PERFORMANCE TESTED AND CERTIFIED TO ANSI/UL 2017.
- I. THE CONTRACTOR SHALL SUPPLY THE POLYGARD® SERIES MGC2-12-1500US ANALOG CONTROLLER, BY INTEC CONTROLS (A RELEVANT SOLUTIONS BRAND); PHONE (858) 761-9319; FAX (858) 578-4633.

2.2 CARBON MONOXIDE (CO) SENSOR/TRANSMITTER

- A. THE CARBON MONOXIDE SENSOR/TRANSMITTER SHALL PROVIDE MONITORING OF THE CARBON MONOXIDE LEVELS IN THE PARKING GARAGE AND CONTROL THE VENTILATION SYSTEM VIA THE CONTROL PANEL IN ACCORDANCE WITH ALL APPLICABLE CODES AND STANDARDS.
- THE SENSORS SHALL BE ELECTROCHEMICAL TYPE. THE SENSOR/TRANSMITTER SHALL HAVE PLUG—IN TECHNOLOGY FOR EASE OF TROUBLESHOOTING AND REPLACEMENT OF BOTH THE ELEMENT AND THE PRINTED CIRCUIT BOARD. SOLID-STATE SENSING DEVICES SHALL NOT BE ACCEPTABLE.

THE SENSOR RANGE SHALL BE 0-250 PPM CARBON MONOXIDE. A MICROPROCESSOR-BASED TRANSMITTER SHALL GENERATE A PROPORTIONAL 4-20 MA OUTPUT SIGNAL. THE WIRING BETWEEN THE TRANSMITTER AND THE CONTROL PANEL SHALL BE A 2-WIRE, TWISTED AND SHIELDED, 4-20MA, 17-28 VDC CONFIGURATION. EACH SENSOR/TRANSMITTER SHALL COVER BETWEEN 5,000 AND 10,000 SQUARE FEET OF THE GARAGE FLOOR AND PLACEMENT SHALL BE APPLIED STRATEGICALLY AND APPROPRIATELY PER FLOOR PLAN REQUIREMENT

- C. THE SENSOR SHALL HAVE STABILITY AND RESOLUTION OF \pm 3 PPM OF READING, REPEATABILITY OF \pm 3% OF READING, AND A RESPONSE TIME OF 50 SECONDS TO A 90% STEP CHANGE. THE LONG-TERM OUTPUT DRIFT SHALL NOT EXCEED MORE THAN 0.4% OF SIGNAL LOSS PER MONTH. THE PERMISSIBLE AMBIENT WORKING TEMPERATURE SHALL BE 14F TO 122F (-10C TO 50C) AND PERMISSIBLE AMBIENT HUMIDITY SHALL BE 15 TO 95% RH, NON-CONDENSING. THE SENSOR SHALL REQUIRE NO ROUTINE MAINTENANCE OTHER THAN PERIODIC CALIBRATION. ITS LIFE EXPECTANCY SHALL BE 5 YEARS OF NORMAL SERVICE. THE MANUFACTURER SHALL PROVIDE A TWO 2-YEAR WARRANTY FOR MATERIALS AND WORKMANSHIP, AND A 12-MONTH WARRANTY ON THE SENSING ELEMENT UNDER NORMAL EXPOSURE.
- D. THE SENSOR/TRANSMITTER PRINTED CIRCUIT BOARD SHALL HAVE THE CAPABILITY OF ADDING UP TO (2) ALARM RELAYS WITH INDIVIDUAL SETPOINTS FOR LOCAL CONTROL OR STATUS INDICATION.
- E. THE SENSOR/TRANSMITTER SHALL BE CONTAINED IN A NEMA 4X METAL ENCLOSURE. THE ENCLOSURE FOR THE SENSOR/TRANSMITTER SHALL BE INSTALLED ON WALLS OR COLUMNS APPROXIMATELY 5 FEET ABOVE THE FLOOR
- F. THE OUTPUT SIGNAL FROM THE SENSOR/TRANSMITTER SHALL BE A DIRECT INPUT TO THE CONTROL PANEL. ALL SEQUENCES OF FAN AND ALARM CONTROL, INCLUDING TIME DELAY FUNCTIONS TO PREVENT HUNTING OF VENTILATION FANS SHALL BE A PART OF THE CONTROL PANEL.
- G. IF THE LEVEL OF CARBON MONOXIDE REACHES 25 PPM IN THE AREA OF DETECTION, THE LOW ALARM SHALL ACTIVATE AND THE EXHAUST FANS WILL BE STARTED. IF THE LEVEL OF CO INCREASES TO 100 PPM, THE HIGH ALARM SHALL ACTIVATE.
- H. THE SENSOR/TRANSMITTER SHALL BE NRTL PERFORMANCE TESTED AND CERTIFIED TO ANSI/UL 2075.
- I. THE CONTRACTOR SHALL SUPPLY THE POLYGARD® SERIES LC-1112 CO SENSOR/TRANSMITTER, BY INTEC CONTROLS

2.3 NITROGEN DIOXIDE (NO2) SENSOR/TRANSMITTER

- THE NITROGEN DIOXIDE SENSOR/TRANSMITTER SHALL PROVIDE MONITORING OF THE NITROGEN DIOXIDE LEVELS PRESENT IN DIESEL EXHAUST IN THE PARKING GARAGE AND CONTROL THE VENTILATION SYSTEM VIA THE CONTROL PANEL IN ACCORDANCE WITH ALL APPLICABLE CODES AND STANDARDS.
- THE SENSORS SHALL BE ELECTROCHEMICAL TYPE. THE SENSOR/TRANSMITTER SHALL HAVE PLUG-IN TECHNOLOGY FOR EASE OF TROUBLESHOOTING AND REPLACEMENT OF BOTH THE SENSING ELEMENT AND THE PRINTED CIRCUIT BOARD. SOLID-STATE SENSING DEVICES SHALL NOT BE ACCEPTABLE.

THE SENSOR RANGE SHALL BE 0-10 PPM NITROGEN DIOXIDE. A MICRO-PROCESSOR-BASED TRANSMITTER SHALL GENERATE A POLARITY PROTECTED, PROPORTIONAL 4-20 MA OUTPUT SIGNAL. THE WIRING BETWEEN THE TRANSMITTER AND THE CONTROL PANEL SHALL BE A 2-WIRE, TWISTED AND SHIELDED, 4-20MA, 17-28 VDC CONFIGURATION. EACH SENSOR/TRANSMITTER SHALL COVER BETWEEN 4,000 AND 6,000 SQUARE FEET OF THE GARAGE FLOOR AND PLACEMENT SHALL BE APPLIED STRATEGICALLY AND APPROPRIATELY PER FLOOR PLAN REQUIREMENT.

- THE SENSOR SHALL HAVE AN ACCURACY AND RESOLUTION OF ± 0.1 PPM OF READING, REPEATABILITY OF $\pm 2\%$ OF READING, AND A RESPONSE TIME OF LESS THAN 40 SECONDS TO A 90% STEP CHANGE. THE SENSOR DRIFT SHALL NOT EXCEED MORE THAN 2% SIGNAL LOSS PER MONTH. THE PERMISSIBLE AMBIENT WORKING TEMPERATURE SHALL BE 14F TO 104F (-20C TO 40C) AND THE PERMISSIBLE AMBIENT HUMIDITY SHALL BE 15 TO 95% RH, NON-CONDENSING. THE SENSOR SHALL REQUIRE NO ROUTINE MAINTENANCE OTHER THAN PERIODIC CALIBRATION. ITS LIFE EXPECTANCY SHALL BE 2 YEARS OF NORMAL SERVICE. THE MANUFACTURER SHALL PROVIDE A TWO 2-YEAR WARRANTY FOR MATERIALS AND WORKMANSHIP, AND A 12-MONTH WARRANTY ON THE SENSING ELEMENT UNDER NORMAL EXPOSURE.
- D. THE SENSOR/TRANSMITTER SHALL BE CONTAINED IN A NEMA 4X ENCLOSURE. THE ENCLOSURE WITH THE SENSOR/TRANSMITTER SHALL BE INSTALLED ON WALLS OR COLUMNS APPROXIMATELY 1.5 FT. ABOVE THE FLOOR.
- E. THE SENSOR/TRANSMITTER SHALL HAVE THE CAPABILITY OF ADDING UP TO (2) RELAYS AS A SEPARATE COMPONENT TO THE PRINTED CIRCUIT BOARD OF THE SENSOR.
- F. THE OUTPUT SIGNAL FROM THE SENSOR/TRANSMITTER SHALL BE A DIRECT INPUT INTO THE DIGITAL CONTROL BUILDING AUTOMATION SYSTEM. ALL SEQUENCES OF FAN AND ALARM CONTROL, INCLUDING TIME DELAY FUNCTIONS TO PREVENT HUNTING OF VENTILATION FANS SHALL BE A PART OF THE CONTROL PANEL.
- G. IF THE LEVEL OF NO2 REACHES 2 PPM, THE LOW ALARM SHALL ACTIVATE. IF THE LEVEL OF NO2 INCREASES TO 5 PPM, THE HIGH ALARM SHALL
- ACTIVATE. THE CONTRACTOR SHALL SUPPLY THE POLYGARD® SERIES AT-1130 NO2 SENSOR/TRANSMITTER, BY INTEC CONTROLS 2.4 SUPPLIER: THE CONTRACTOR SHALL SUPPLY THE MGC-SERIES CONTROL PANEL AND ALL ASSOCIATED GAS TRANSMITTERS, BY INTEC CONTROLS
- 2.5 WARRANTY: THE MANUFACTURER SHALL PROVIDE A TWO 2-YEAR WARRANTY FOR MATERIALS AND WORKMANSHIP, AND A 12-MONTH WARRANTY
- ON THE SENSING ELEMENT UNDER NORMAL EXPOSURE.

PART 3 - EXECUTION

- 3.1 INSPECTION: GENERAL: EXAMINE AREAS AND CONDITIONS UNDER WHICH GAS MONITORING AND CONTROL SYSTEM SHALL BE INSTALLED. RELATED ITEMS SHALL BE EXAMINED AS WELL.
- 3.2 CONTROL SEQUENCE: THE CONTROLLER SHALL OPERATE ACCORDING TO THE SPECIFICATIONS RECOMMENDED BY THE MANUFACTURER. THE OPERATION SHALL BE AS FOLLOWS:
- 1. THE CONTROLLER SHALL BE CALIBRATED TO THE DESIRED SET-POINTS BEFORE OPERATION.
- 2. THE CONTROLLER SHALL CONTINUOUSLY DETECT THE SURROUNDING AIR FOR ANY TRACES OF THE GAS DETECTED.
- 3. WHEN THE FIRST SET-POINT IS REACHED, THE SENSOR SHALL ACTIVATE THE LOW ALARM ON THE CONTROLLER AND THE CORRESPONDING DEVICES, SUCH AS THE EXHAUST FANS, DAMPERS, ETC.
- 4. IF THE GAS LEVEL CONTINUES TO INCREASE TO THE SECOND SET—POINT, THE HIGH ALARM SHALL ACTIVATE WITH THE CORRESPONDING DEVICES, SUCH AS THE AUDIO/VISUAL ALARM, ETC.
- 5. THE SENSOR SHALL CONTINUE TO TRACE THE SPECIFIED GAS AND WILL NOT DISABLE THE ALARM UNTIL THE GAS LEVEL IS DROPPED A SIGNIFICANT PERCENTAGE BELOW THE ALARM SET-POINTS.
- 3.3 OPERATION AND MAINTENANCE MANUALS: THE OPERATION AND MAINTENANCE MANUALS SHALL CONTAIN ALL INFORMATION NECESSARY FOR THE OPERATION, MAINTENANCE, REPLACEMENT, INSTALLATION, AND PARTS PROCUREMENT FOR THE ENTIRE GAS DETECTION SYSTEM. THIS DOCUMENTATION SHALL INCLUDE SPECIFIC PART NUMBERS.
- 3.4 AS-BUILT DOCUMENTATION: FOLLOWING PROJECT COMPLETION AND TESTING, THE CONTRACTOR WILL SUBMIT AS-BUILT DRAWINGS REFLECTING THE EXACT INSTALLATION OF THE SYSTEM.
- 3.5 CALIBRATION: CALIBRATION SHALL NOT BE NECESSARY TO VERIFY SYSTEM OPERATION. THE USER SHALL VERIFY SIGNAL TRANSMISSION FROM THE SENSOR TO THE CONTROL PANEL BY APPLYING THE APPROPRIATE TEST GAS TO THE CORRESPONDING SENSOR. THE CALIBRATION KIT CAN BE USED FOR SYSTEM VERIFICATION OR SENSOR CALIBRATION WHEN REQUIRED. ONE CALIBRATION KIT SHALL BE PROVIDED BY THE CONTRACTOR SUPPLIED BY INTEC CONTROLS

PERMIT NOTES:

- 1. EQUIPMENT NOISE LEVEL NOT TO EXCEED 55 DB AT THE LOT LINE.
- 2. ALL EXPANSION VALVES, DEVICES AND CONNECTIONS SHALL BE REMOVED FROM THE AIRSTREAM OF ALL MECHANICAL EQUIPMENT AS PER LOCAL CODES.
- 3. THE MECHANICAL CONTRACTOR SHALL GUARANTEE, AS APPLICABLE, THAT THE PLENUM CHAMBER USED FOR RECIRCULATION OF AIR WILL BE OF TIGHT CONSTRUCTION AND THAT ALL SOURCES OF AIR CONTAMINANTS FROM TRAPS, SOIL STACKS, DOWN SPOUTS, VENTS. EXHAUST DISCHARGES AND OTHER SOURCES WILL BE ENCLOSED SO THAT NO CONTAMINATED AIR WILL BE RECIRCULATED.
- 4. THE MECHANICAL CONTRACTOR SHALL FURNISH AND INSTALL A SAFETY RELIEF VALVE DESIGNED TO RELIEVE AND/OR PREVENT THE BUILDUP OF EXCESSIVE REFRIGERANT PRESSURE WITHIN THE DIRECT EXPANSION SYSTEMS. THE PRESSURE RELIEF DEVICE SHALL BE SET AT 400 PSI AND SHALL BE INSTALLED ON THE HIGH PRESSURE SIDE AT THE DISCHARGE OF THE COMPRESSOR AND UPSTREAM OF THE COMPRESSOR SHUTOFF (STOP) VALVE.
- 5. ALL FRESH AIR INTAKE OPENINGS SHALL BE A MINIMUM OF 15'-0" (CHICAGO) 10'-0" (OUTSIDE CHICAGO) AWAY FROM ANY EXHAUST OR POINT OF CONTAMINATE DISCHARGE.
- 6. ALL DUCTWORK SHALL BE IN ACCORDANCE WITH "SMACNA" LOW VELOCITY DUCT MANUAL AND "ASHRAE" RECOMMENDATIONS.
- 7. THE EQUIPMENT IN THE VENTILATING AND HEATING SYSTEM SHALL BE SUFFICIENT TO MAINTAIN 72 DEGREES F WITHIN THE AREA SERVED AT ALL TIMES WHEN 33-1/3 PERCENT OF CODE REQUIRED AIR IS SUPPLIED FROM OUTDOORS AT -10 DEGREES
- 8. VOLUME DAMPERS OF LOCKING TYPE SHALL BE PLACED IN EACH FORCED WARM AIR RUN.

VENTILATION NOTES:

- 1. CLEARANCES FOR FORCED AIR FURNACES MUST CONFORM TO MANUFACTURERS REQUIREMENTS (OR SHOW CLEARANCES ON THE DRAWINGS).
- 2. ALL DUCTWORK MUST BE GALVANIZED STEEL OR STAINLESS STEEL., INTAKE MUST BE INSULATED.
- SMOKE DETECTORS AND CARBON MONOXIDE DETECTORS ARE SHOWN ON ELECTRICAL DRAWING(S).
- 4. IF THE PROJECT INCLUDES A PLENUM CEILING OR FLOOR: THE CONTRACTOR SHALL GUARANTEE THAT THE PLENUM CHAMBER USED FOR RECIRCULATION OF AIR WILL BE OF TIGHT CONSTRUCTION AND THAT ALL SOURCES OF AIR CONTAMINATION FROM TRAPS, SOIL STACKS, DOWNSPOUTS, VENTS AND ALL OTHER SOURCES OF CONTAMINATION WILL BE ENCLOSE SUCH THAT NO CONTAMINATED AIR WILL BE RECIRCULATED.

GENERAL COORDINATION NOTES:


- EACH TRADE CONTRACTOR SHALL VISIT CONSTRUCTION SITE PRIOR TO BIDDING, EXAMINE SCOPE AND CONDITIONS OF OTHER CONTRACT WORK, EXAMINE EXISTING CONDITIONS AND ALL INTERFERENCES AND REQUIRED COORDINATION IN ORDER TO INCLUDE EFFECT OF SAID CONDITIONS IN THEIR BID. BID DRAWINGS ARE DIAGRAMMATIC AND DO NOT INDICATE ALL REQUIRED RELOCATIONS, OFFSETS, CHANGE IN ASPECT RATIOS, OR ROUTING CHANGES REQUIRED TO INTEGRATE WORK WITH ALL OTHER CONDITIONS OR TRADES. WORK INSTALLED BEFORE COORDINATING SO AS TO CAUSE INTERFERENCES WITH OTHER TRADES SHALL BE REMOVED AND REWORKED WITHOUT COST TO OWNER. COST OF PROVIDING SUCH RELOCATIONS, OFFSETS, SIZE, CHANGES, REROUTING, ETC. SHALL BE INCLUDED IN BID. CODE CONFORMING SCALED (1/4") COORDINATED DRAWINGS SHALL BE PREPARED BY EACH TRADE TO FACILITATE AND VERIFY FIT AND CONGRUENCE OF THEIR INSTALLATION WITH OTHER TRADES.
- WHERE ADDITIONAL DETAILS, DIAGRAMS, EQUIPMENT DATA, AND ISOMETRICS ARE REQUIRED BY BUILDING DEPARTMENT OR CODE AUTHORITIES FOR PERMIT OR APPROVAL, CONTRACTOR SHALL PROVIDE SAME AT NO ADDITIONAL COST.
- 3. BUILDING PLANS SHOWN ARE COMPILED FROM SOURCES BELIEVED TO BE ACCURATE. HOWEVER, THE INFORMATION SHOWN ON THESE PLANS IS SCHEMATIC AND CONTRACTOR SHALL BE RESPONSIBLE FOR ALL PROPER DIMENSIONS, SIZES, SYSTEM VOLTAGES, QUANTITIES AND EXTENT OF WORK.
- THE CONTRACTOR SHALL REFER TO THE ARCHITECTURAL, STRUCTURAL, PLUMBING, FIRE PROTECTION, MECHANICAL AND ELECTRICAL DRAWINGS AND SPECIFICATIONS FOR COORDINATION AND EXTENT OF THE WORK OF THE VARIOUS TRADES AND IMPACT ON THEIR WORK.
- WITH THE APPROVAL OF THE ARCHITECT AND WITHOUT ADDITIONAL COST TO THE OWNER, MAKE MODIFICATIONS IN THE WORK, INCLUDING REROUTING AS REQUIRED BY INTERFERENCE WITH STRUCTURAL, GENERAL AND WORK OF OTHER TRADES FOR PROPER EXECUTION OF THE WORK.
- 6. REFER TO THE ARCHITECTURAL DRAWINGS, FIELD CONDITIONS AND DETAILS FOR EXACT LOCATION OF PARTITIONS.
- 7. CUTTING AND PATCHING FOR THEIR WORK SHALL BE PERFORMED BY EACH TRADE CONTRACTOR UNLESS NOTED OTHERWISE. GENERAL MECHANICAL NOTES:
- 1. ALL WORK SHALL BE FURNISHED AND INSTALLED IN ACCORDANCE WITH BUILDING STANDARDS AND ALL APPLICABLE CODES.
- 2. MEDIUM/LOW PRESSURE DUCTWORK SHALL BE CONSTRUCTED IN ACCORDANCE WITH THE LATEST SMACNA STANDARDS.
- 3. PROVIDE MANUAL DAMPER ON ALL LOW PRESSURE SUPPLY BRANCH TAKE-OFFOF DUCTWORK
- 4. ALL DUCT SIZES SHOWN SHALL BE CLEAR INSIDE DIMENSIONS.
- 5. DIFFUSERS, REGISTERS ARE AS SCHEDULED IN THE DRAWING. CONTRACTOR TO VERIFY AND COORDINATE WITH ARCHITECT TYPE OF CEILING TO DETERMINE FRAME TYPE.
- 6. BLANK-OFF WITH BLACK PAINTED PANEL WHERE SHOWN. DO NOT PAINT EXPOSED DUCTS OR REGISTERS.
- 7. PROVIDE UL APPROVED FIRE DAMPERS. PROVIDE UL APPROVED FIRE DAMPERS IN ALL DUCT PENETRATIONS THRU FIRERATED ASSEMBLIES WHETHER INDICATED OR NOT.
- 8. FLEXIBLE DUCTWORK: NOT TO BE USED
- 10. PROVIDE LINNING ON ALL SUPPLY AND RETURN AIR DUCTWORK AT A MIN. OF 15'-0" FROM THE HEAT PUMPS/FURNACES.
- 11. INSULATE ALL DUCTWORK LOCATED IN UNCONDITIONED SPACES. PER IECC C403.2.9
- INSULATE HVAC DUCTWORK AS FOLLOWS: UNLESS INDICATED OTHERWISE, NEW HVAC SUPPLY AND RETURN AIR DUCTWORK SHALL BE EXTERNALLY INSULATED.
- INSULATE COLD ROOM SUPPLY AND EXHAUST DUCTS. • IF DUCTS ARE INTERNALLY INSULATED, THEY ARE NOT EXTERNALLY INSULATED UNLESS SPECIFICALLY DIRECTED.
- TRANSFER AND EXHAUST DUCTS ARE INTERNALLY INSULATED ONLY IF SPECIFICALLY DIRECTED.
- INSTALL AN INSULATION JACKET ON EXTERNALLY-INSULATED HVAC DUCTWORK LOCATED OUTDOORS; AND INDOORS EXCEPT IN MECHANICAL ROOMS AND ABOVE CEILINGS.
- INSULATE OUTSIDE AIR INTAKE DUCTS IF LOCATED IN NON-MECHANICAL ROOM INDOORS SPACE.
- 12. ALL LONGITUDINAL AND TRANSVERSE JOINTS, SEAMS AND CONNECTIONS IN METALLIC AND NONMETALLIC DUCTS SHALL BE CONSTRUCTED AS SPECIFIED IN SMACNA HVAC DUCT CONSTRUCTION STANDARDS——METAL AND FLEXIBLE AND NAIMA FIBROUS GLASS DUCT CONSTRUCTION STANDARDS. ALL JOINTS, LONGITUDINAL AND TRANSVERSE SEAMS AND CONNECTIONS IN DUCTWORK SHALL BE SECURELY FASTENED AND SEALED WITH WELDS, GASKETS, MASTICS (ADHESIVES), MASTIC-PLUS-EMBEDDED-FABRIC SYSTEMS, LIQUID SEALANTS OR TAPES. CLOSURE SYSTEMS USED TO SEAL DUCTWORK LISTED AND LABELED IN ACCORDANCE WITH UL 181A SHALL BE MARKED "181A-P"FOR PRESSURE-SENSITIVE TAPE, "181 A-M"FOR MASTIC OR "181 A—H"FOR HEAT—SENSITIVE TAPE. CLOSURE SYSTEMS USED TO SEAL FLEXIBLE AIR DUCTS AND FLEXIBLE AIR CONNECTORS SHALL COMPLY WITH UL 181B AND SHALL BE MARKED "181B-FX" FOR PRESSURE-SENSITIVE TAPE OR "181B-M" FOR MASTIC. DUCT CONNECTIONS TO FLANGES OF AIR DISTRIBUTION SYSTEM EQUIPMENT SHALL BE SEALED AND MECHANICALLY FASTENED. MECHANICAL FASTENERS FOR USE WITH FLEXIBLE NONMETALLIC AIR DUCTS SHALL COMPLY WITH UL 181B AND SHALL BE MARKED "181B-C." CLOSURE SYSTEMS USED TO SEAL METAL DUCTWORK SHALL BE INSTALLED IN ACCORDANCE WITH THE MANUFACTURER'S INSTALLATION INSTRUCTIONS. UNLISTED DUCT TAPE IS NOT PERMITTED AS A SEALANT ON ANY DUCT.
 - EXCEPTION: CONTINUOUSLY WELDED AND LOCKING-TYPE LONGITUDINAL JOINTS AND SEAMS IN DUCTS OPERATING AT STATIC PRESSURES LESS THAN 2 INCHES OF WATER COLUMN (500 PA) PRESSURE CLASSIFICATION SHALL NOT REQUIRE ADDITIONAL CLOSURE SYSTEMS.
- 13. DUCTS SHALL BE SUPPORTED AT INTERVALS NOT TO EXCEED 10 FEET AND SHALL BE IN ACCORDANCE WITH SMACNA HVAC DUCT CONSTRUCTION STANDARDS-METAL AND FLEXIBLE. FLEXIBLE AND OTHER FACTORY-MADE DUCTS SHALL BE SUPPORTED IN ACCORDANCE WITH THE MANUFACTURER'S INSTRUCTIONS.
- 14. ALL EQUIPMENT AND APPLIANCES, INCLUDING THE AIR CONDITIONER, WATER HEATER AND FURNACE, SHALL BE INSTALLED IN ACCORDANCE WITH THEIR LISTINGS AND THE MANUFACTURER'S INSTALLATION INSTRUCTIONS. A COPY OF THE MANUFACTURER'S INSTALLATION INSTRUCTIONS MUST BE PROVIDED ON SITE AT THE TIME OF INSPECTION.
- 15. ALL SYSTEMS >4.5 TONS REQUIRE ECONOMIZER FAULT DETECTION AND DIAGNOSIS. PER IECC C403.2.4.7
- 16. INSULATE ALL PIPING PER TABLE IECC C403.2.1
- 17. SYSTEM ADJUST AND BALANCE PROVIDE TEST AND BALANCE REPORT PER IECC C408.2.5.3
- 18. PROVIDE DRAIN PAN FOR ALL UNITS THAT MAY CAUSE DAMAGE TO BLDG COMPONENTS AS A RESULT OF OVERFLOW FROM CONDENSATE REMOVAL (COOLING COIL OR FUEL BURNING EQUIP.). EXCEPTION IF THE APPLIANCE AUTOMATICALLY SHUT DOWN IN EVENT OF STOPPAGE IN CONDENSATE DRAINAGE SYSTEM.


Material	, ,,		terial Matrix(Based on IFGC 403) Istandards to
Material		Not Permitted	Follow
Wrought-Iron	Schedule 40 or better		ASME B 36.10.10M or ASTM A35 or ASTM A106


N.G. DISTRIBUTION PIPING SHALL BE SCHEDULE 40 STEEL PIPE MEETING THE REQUIREMENTS OF ASTM A 53/A 53M WITH 150# MALLEABLE IRON FITTINGS. GAS PIPING LARGER THAN 3"OR MORE THAN 5 PSIG TO BE WELDED TO BE SCHEDÜLE 40 STEEL PIPING.

Note: The gas piping design shall conform to all the requirements of IFGC 403. GENERAL GAS PIPING NOTES:

- 1. ALL WORK SHALL BE FURNISHED AND INSTALLED IN ACCORDANCE WITH BUILDING STANDARDS AND ALL APPLICABLE CODES.
- 2. FUEL GAS PIPING AND CONTROLS MUST CONFORM TO THE INTERNATIONAL FUEL GAS CODE(IFGC), CHAPTER 4 (WITH MODIFICATIONS AS NOTED IN ARTICLE 14). [18-28-1400]
- 3. GAS PIPING MUST BE SIZED IN ACCORDANCE WITH IFGC TABTES 402.(1) THROUGH 402.3(34). [IFGC 402.3]
- 4. THE MAXIMUM DESIGN OPERATING PRESSURE FOR GAS PIPING SYSTEMS LOCATED INSIDE BUILDINGS SHALL NOT EXCEED 5 PSIG (SOME EXCEPTIONS ARE NOTED). [TFGC 402.5]
- 5. GAS PIPING MATERIALS MUST CONFORM TO THE GAS PIPING & TUBING MATERIAL MATRIX (LFGC 403 REQUIREMENTS). [IFGC 403]
- 6. PIPING IN CONCEALED LOCATIONS MUST CONFORM TO THIS IFGC 404.3. [IFGC 404.3]
- 7. MINIMUM REQUIRED BURIAL DEPTH FOR UNDERGROUND PIPING SYSTEMS MUST CONFORM TO IFGC 404.9. (MINIMUM 12 INCHES BELOW GRADE). [IFGC 404.9]
- 8. GAS PIPES MUST BE SLOPED AT 1/4 INCH IN EVERY 15 FEET. [IFGC 408.1]
- 9. GAS PIPING GREATER THAN 2" INSIDE DIAMETER OR CARRYING MORE THAN 5 POUNDS(PSIG) SHALL BE SCHEDULE 40 STANDARD WELD FITTINGS.
- 10. PIPING METER IDENTIFICATION SHALL BE MARKED WITH AN APPROVED PERMANENT IDENTIFICATION AND BE READILY IDENTIFIABLE.
- 11. PAINT ALL GAS PIPING THAT IS EXPOSED TO THE ELEMENTS.
- 12. UNDERGROUND PIPING SHALL BE A MIN OF 18" BELOW GRADE. [IFGC 404.12]

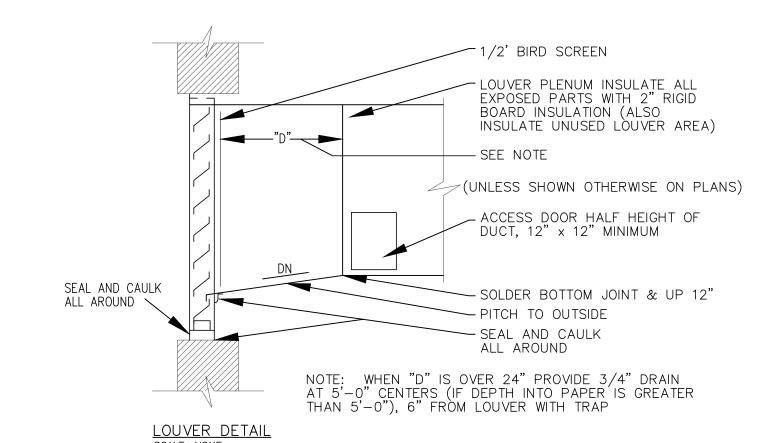

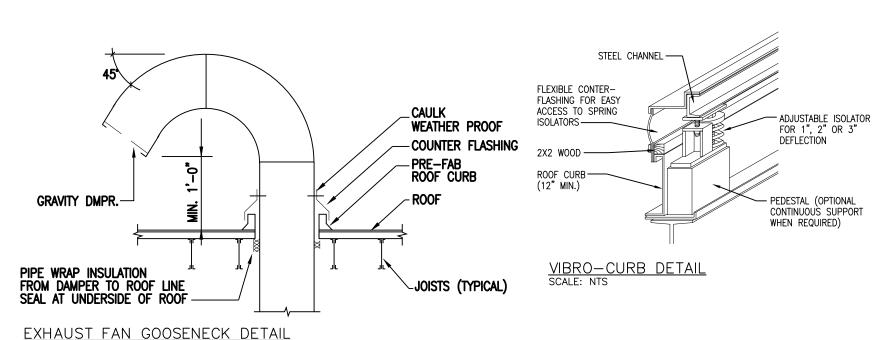

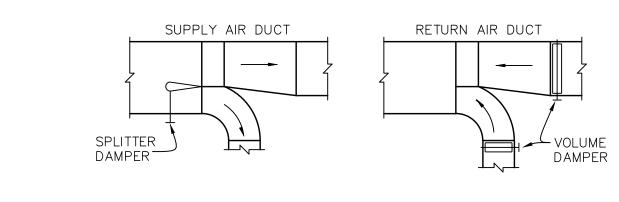

– HVAC UNIT CLEANOUT PLUGS 4"TO 6"DEEP TRAP 16"x8"x1-5/8" THICK CONCRETE BLOCK BY HVAC TRADES UNIT CURB - FLOOR LINE

PICAL DUCT BRANCH

PROJECT # 05.06.22

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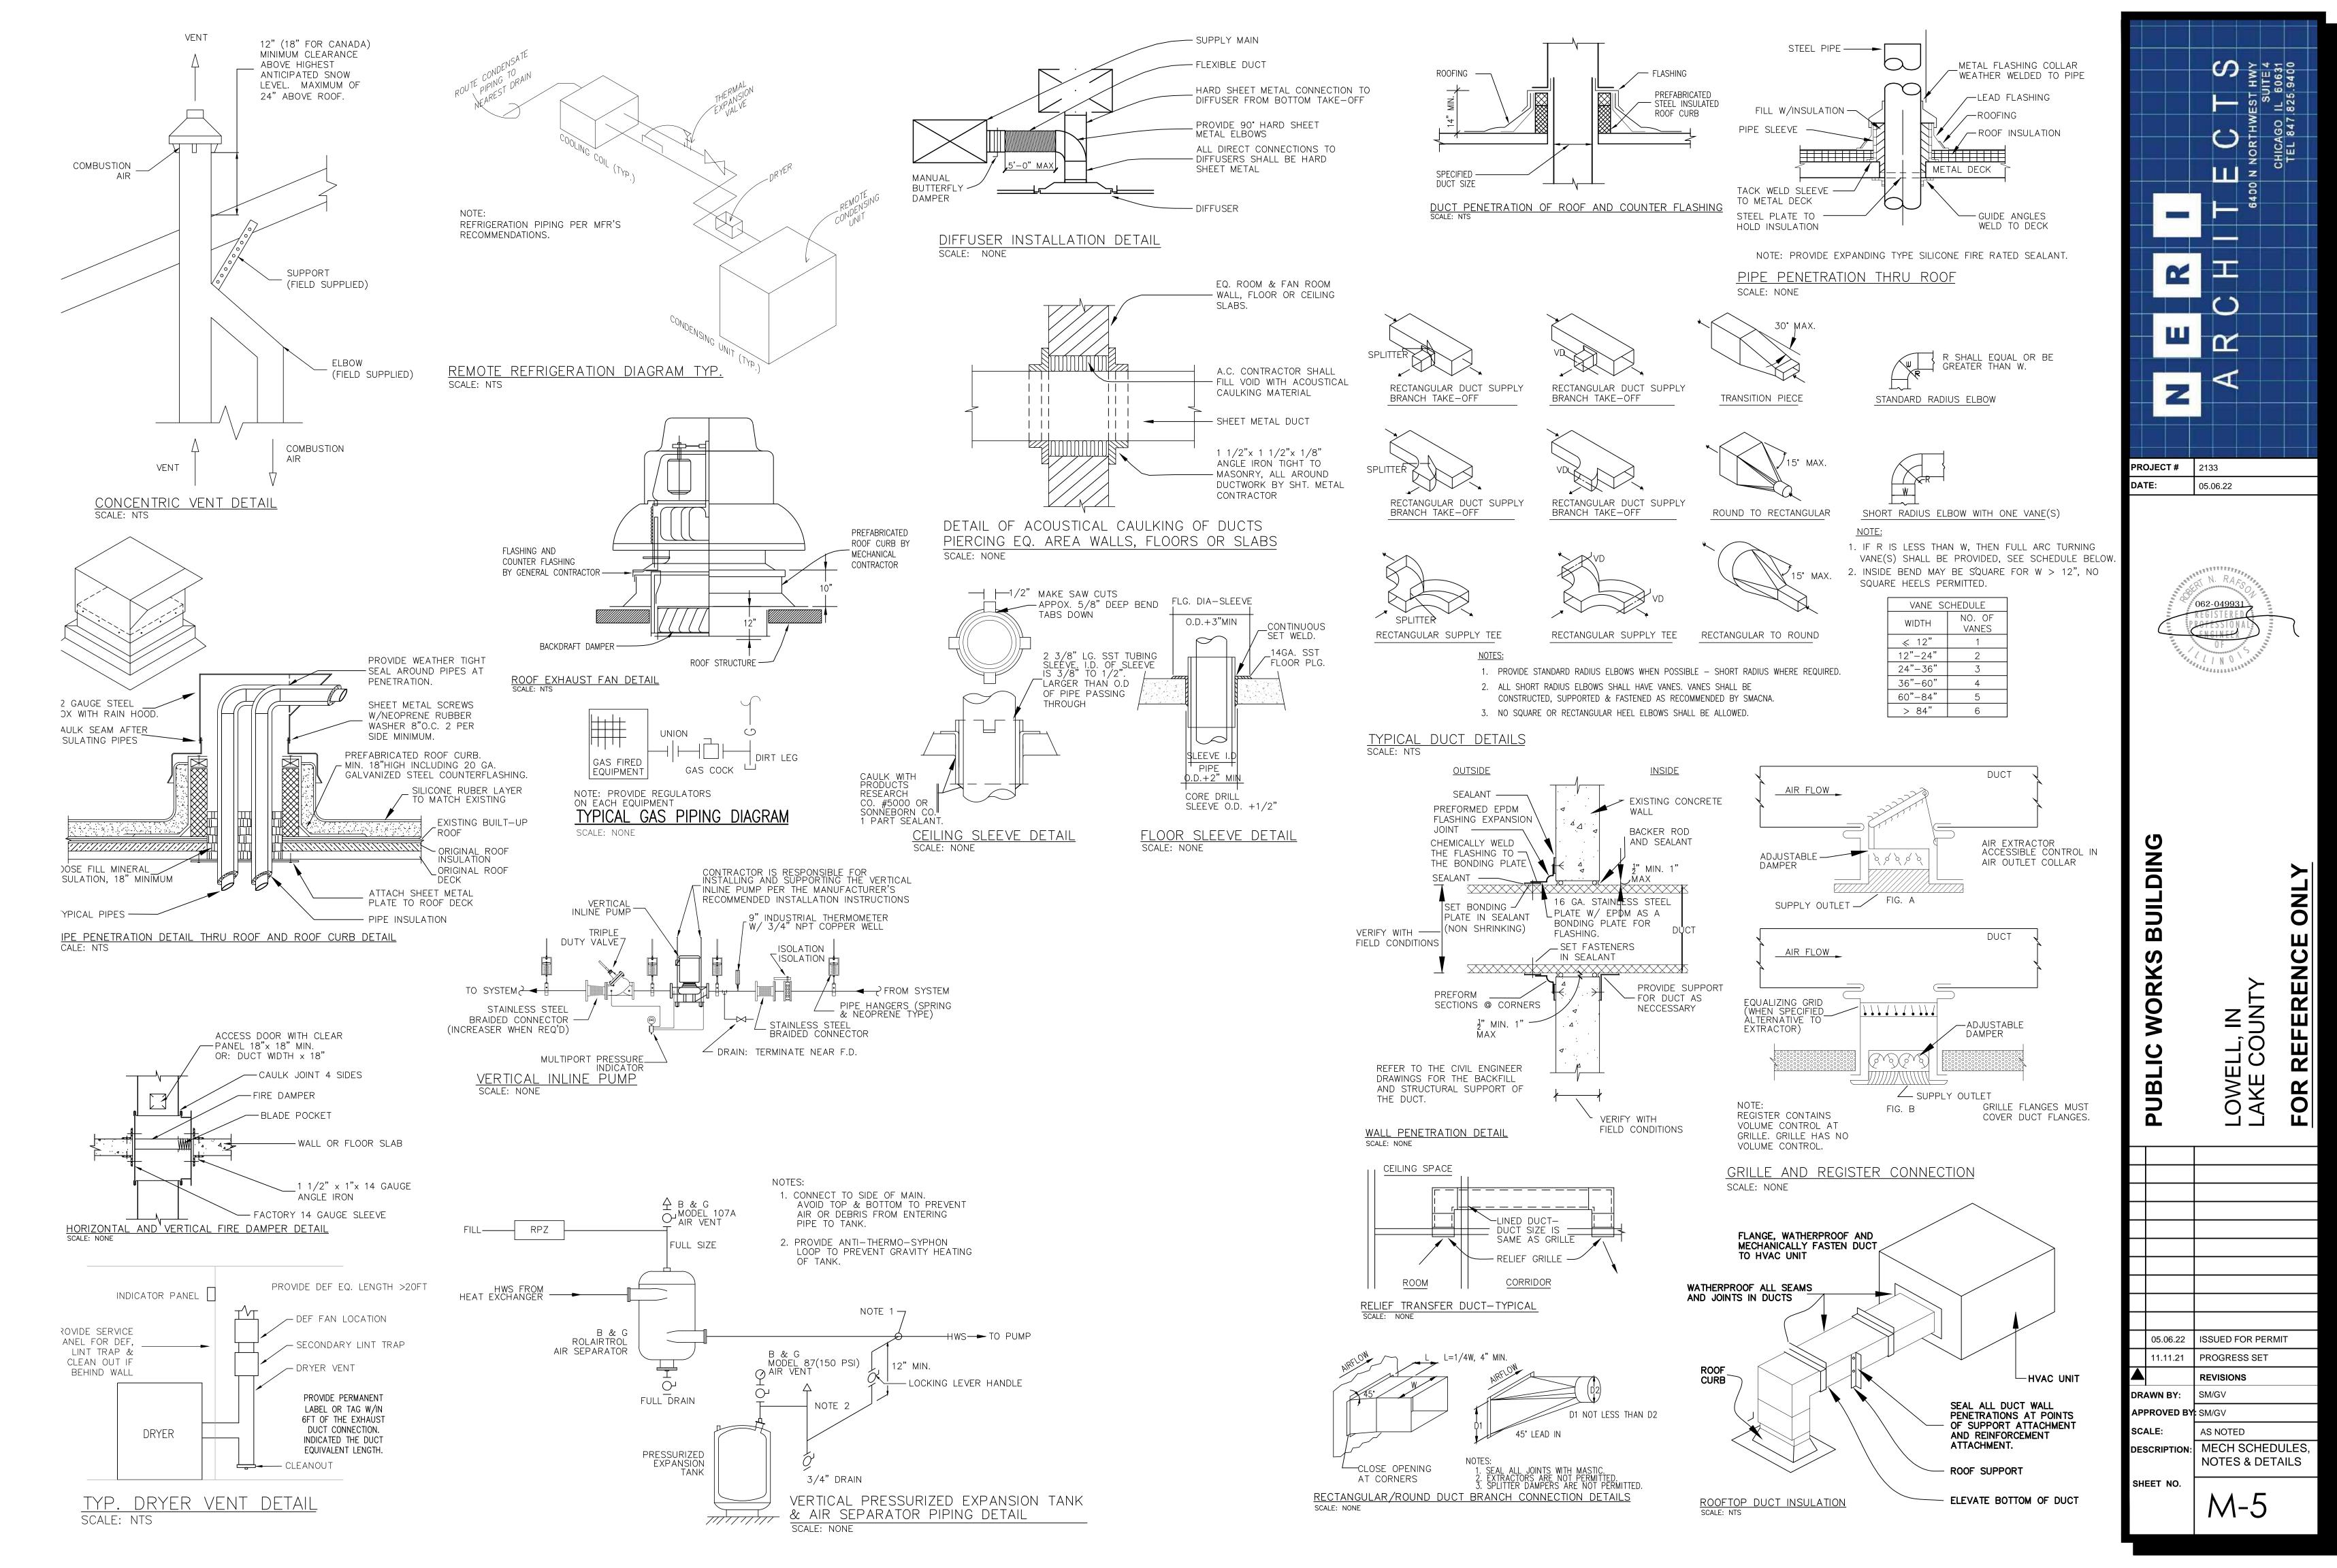
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05.06.22 | ISSUED FOR PERMIT PROGRESS SET 11.11.21 DRAWN BY: APPROVED BY: SM/GV SCALE: **AS NOTED**

SHEET NO.

/V\-4

DESCRIPTION: MECH SCHEDULES NOTES & DETAILS



					ВС	ILER SCHE	EDULE								
TAG	MANUFACTURER & MODEL No.	BOILER TYPE	GAS TYPE	INLET GAS PRES. IN.	CAPACITY INPUT (MBH)	CAPACITY OUTPUT (MBH)	OPER. EFF. (%)	EWT (°F)	LWT (°F)	MAX FLOW RATE (GPM)	MAX P.D. (FT.)	MAX WORKING PRES. (PSI)	VOLTAGE/ PHASE	AMPS	REMARKS
B-1	NAVIEN NFC-250/200H	CONDENSING	NG	1/2	199*	183*	95	180	160	4.5	1.42	80	120	<15	SEE NOTE1

*COMBI BOILER HTG ONLY LISTED

NOTE 1: STAINLESS STEEL HEAT EXCHANGER, FLOW SW, LOW WEAR CUTOFF W/ MANUAL RESET AND ST, MODULATING BURNER W 5:1 TURNDOWN, 50PSI RELIEF VALVE, AUTOMATIC RESET LIMIT, LOW Nox OPERATION, LOW GAS PRESSURE OPERATION, OUTDOOR RESET, PUMP RELAY W/ FREEZE PROTECTION, LOW WATER FLOW INDICATION, ON/OFF SW, CONTACTS ON ANY FAILURE, CONDENSATE NEUTRALIZATION KIT, SMART SYSTEM CONTROL PACKAGE. BOILER RECIRCULATING PUMP PROVIDED BY MANUFACTURER. 3" AIR INLET/3"VENT PROVIDE CONCENTRIC VENT KIT.


HYDRONIC NOTES:

- 1. ALL OPENINGS IN CONCRETE OR MASONRY SHALL BE SLEEVED.
- 2. ALL HYDRONIC PIPING SHALL BE HYDROSTATICALLY TESTED FOR 15MIN. AND 30 MIN. FOR CONCRETE EMBEDDED PIPING AT 100 PSI MIN. IN WITNESS OF
- 3. MECHANICAL SYSTEM PIPING CAPABLE OF CARRYING FLUIDS ABOVE 105°F (41°C) OR BELOW 55°F (13°C)
- SHALL BE INSULATED TO A MINIMUM OF R-34. PROVIDE RADIANT THERMAL BARRIER BELOW TUBING
- MIN. R-11. MANIFOLD BOX - APPROPRIATE SIZE TO ALLOW FOR MANIFOLDS, ISOLATION AND BALANCE VALVES, CONNECTIONS TO MAIN SUPPLY AND RETURN PIPES, AND SUPPORTS FOR MANIFOLD HEADERS. HOT SUPPLY TUBING IS PLACED NEXT TO COOLER (MANIFOLD BOXES ARE TO BE FIELD REPRICATED AND RETURN TUBING TO BETTER AVERAGE THE COORDINATED) SURROUNDING SLAB TEMPERATURE. THIS IS DONE REGARDLESS OF THE EXACT PATTERN. BANDED TUBING AREA - TUBING SPACING PER SCHEDULE, BANDED AREA TUBE SPACING WILL TYPICALLY BE TIGHTER THAN THE PRIMARY AREA TUBE SPACING BANDED AREAS SHALL BE AS NOTED SCHEDULED ON DRAWINGS OR TO NUMBER OF MEET A REQUIRED SQUARE FOOTAGE. TUBES. TYPICAL BANDED AREAS WILL BE EACH TUBE LOCATED ALONG OUTER WALLS SHOULD BE AND/OR THE SLABS BOUNDRIES. THE SAME LENGTH AND PRIMARY TUBING AREA - TUBING SPACING DIAMETER PER SCHEDULE, PRIMARY AREA TUBE SPACING AS SCHEDULED. WILL TYPICALLY BE WIDER THAN THE BANDED AREA TUBE SPACING.


CONCRETE SLAB, CONCRETE CAP, THIN SLAB, MUDSET


SLAB SNOWMELT, OR BRICK PAVERS SNOWMELT INSTALLATION

RADIANT TUBING LAYOUT — ENCAPSULATED TUBING INSTALLATION — DOUBLE SERPENTINE LAYOUT SCALE: NTS

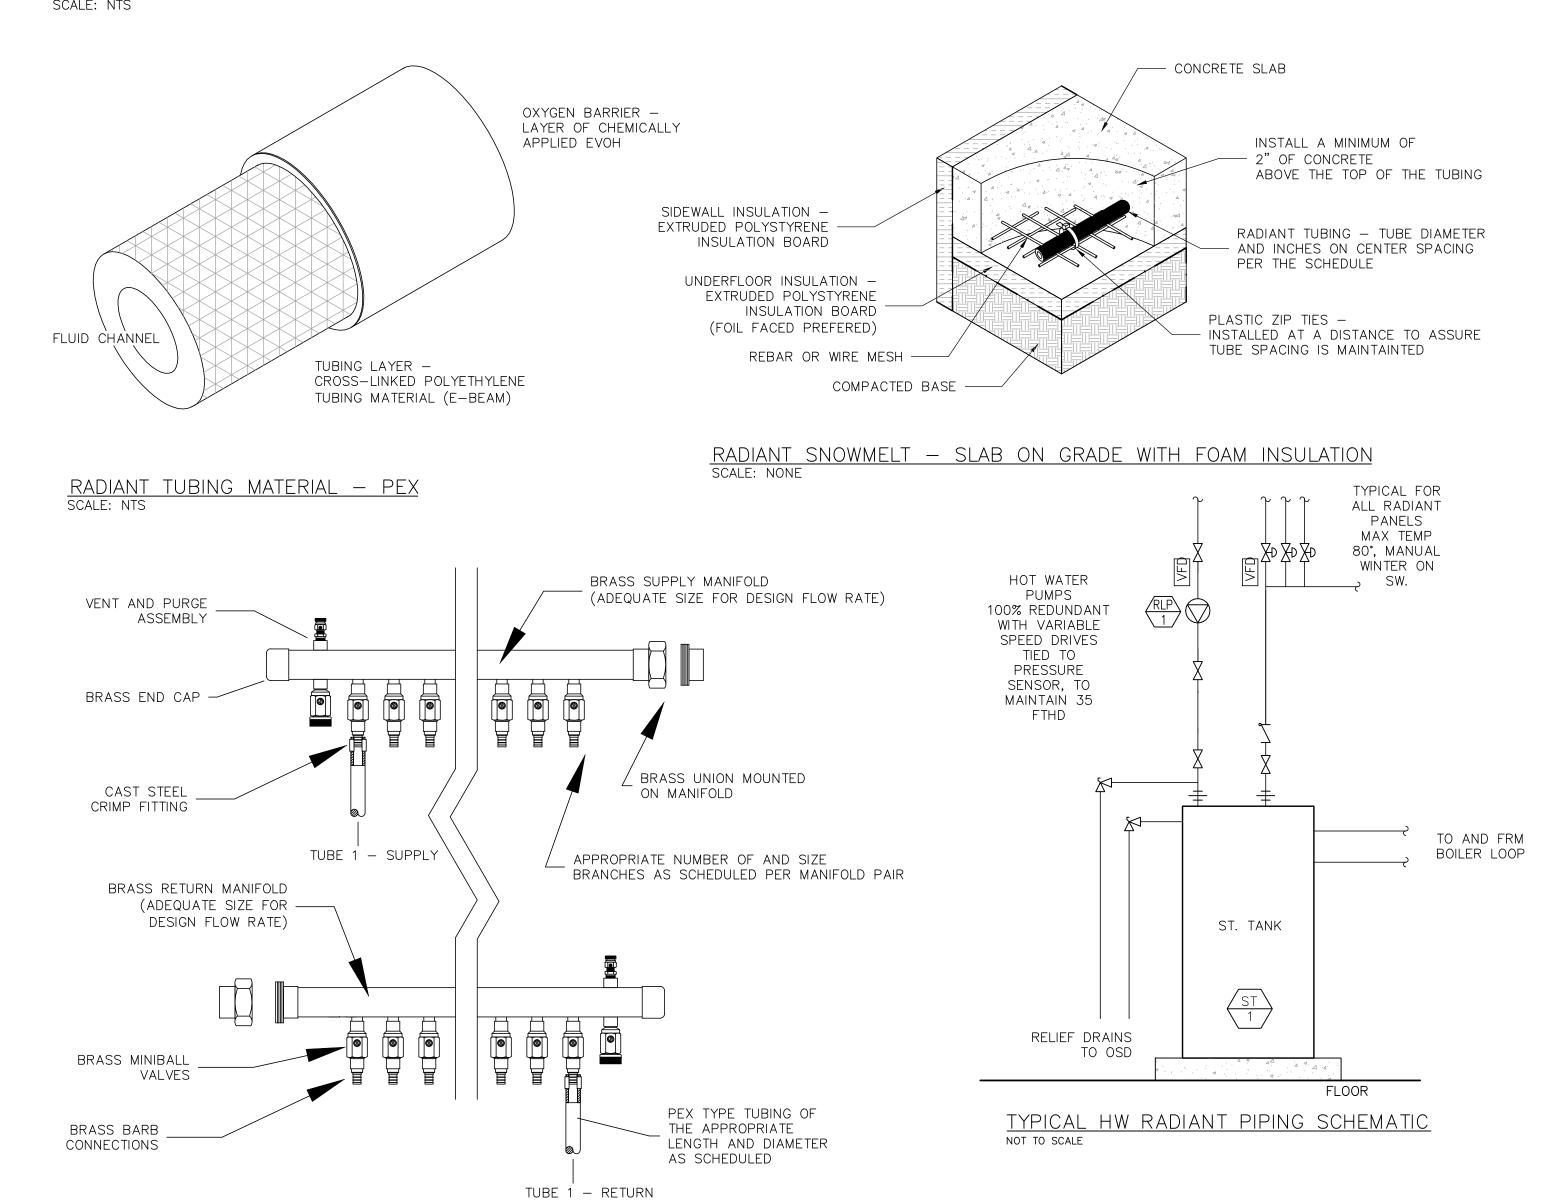


RADIANT TUBING MANIFOLD — PEX TUBING (CRIMP LOCK DESIGN)
SCALE: NTS

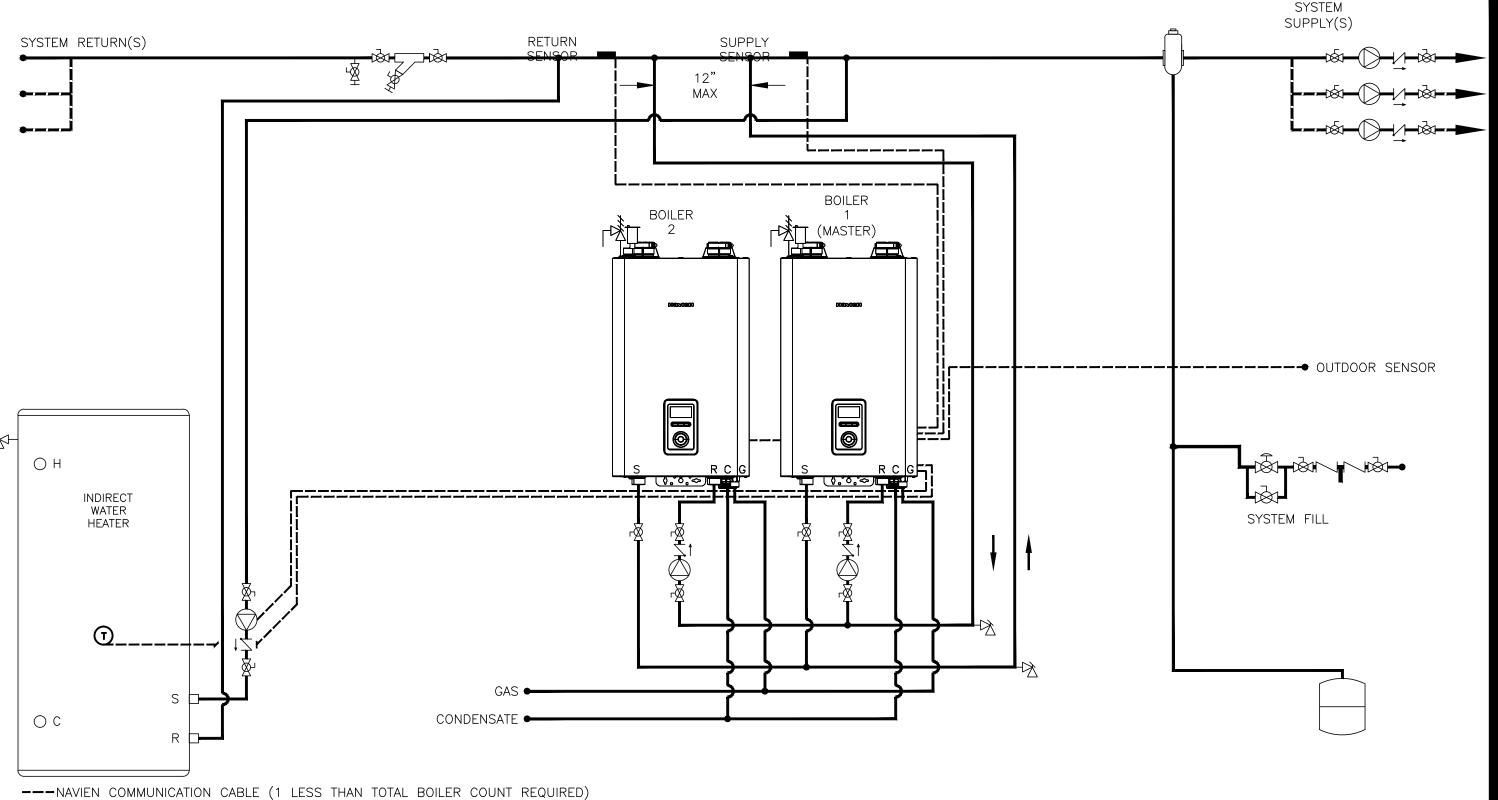

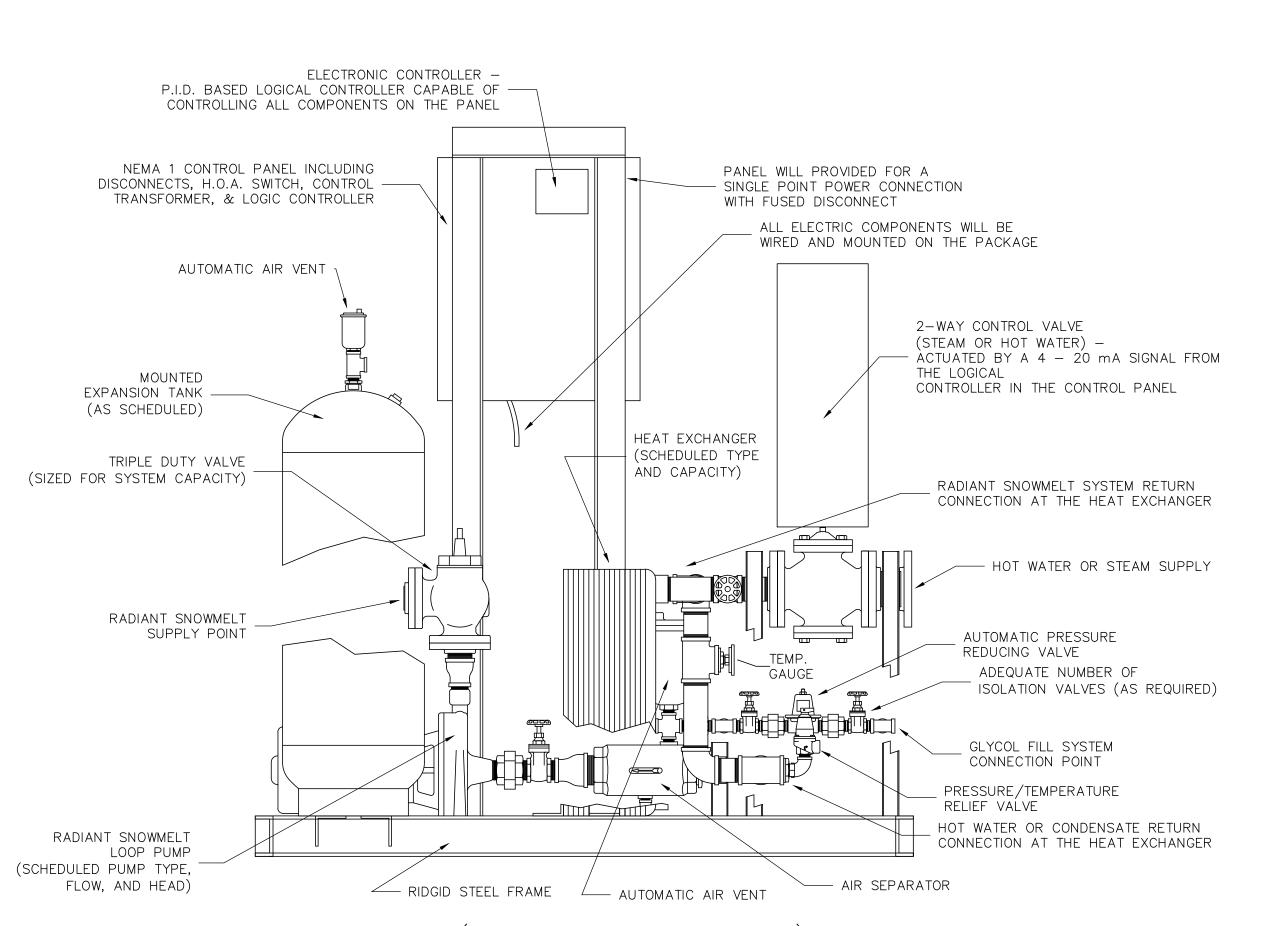

RADIANT SNOWMELT PACKAGE DETAIL (HEAT TRANSFER AND CONTROL)
SCALE: NONE

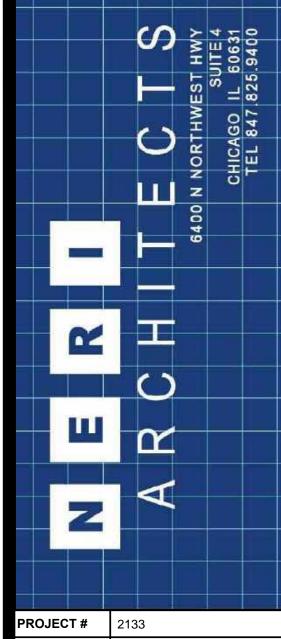

05.06.22



WORKS


LOWELL, IN LAKE COUNT 05.06.22 | ISSUED FOR PERMIT 11.11.21 PROGRESS SET DRAWN BY: APPROVED BY: SM/GV AS NOTED DESCRIPTION: MECH SCHEDULES


NOTES & DETAILS

M-6

SHEET NO.

REFERE

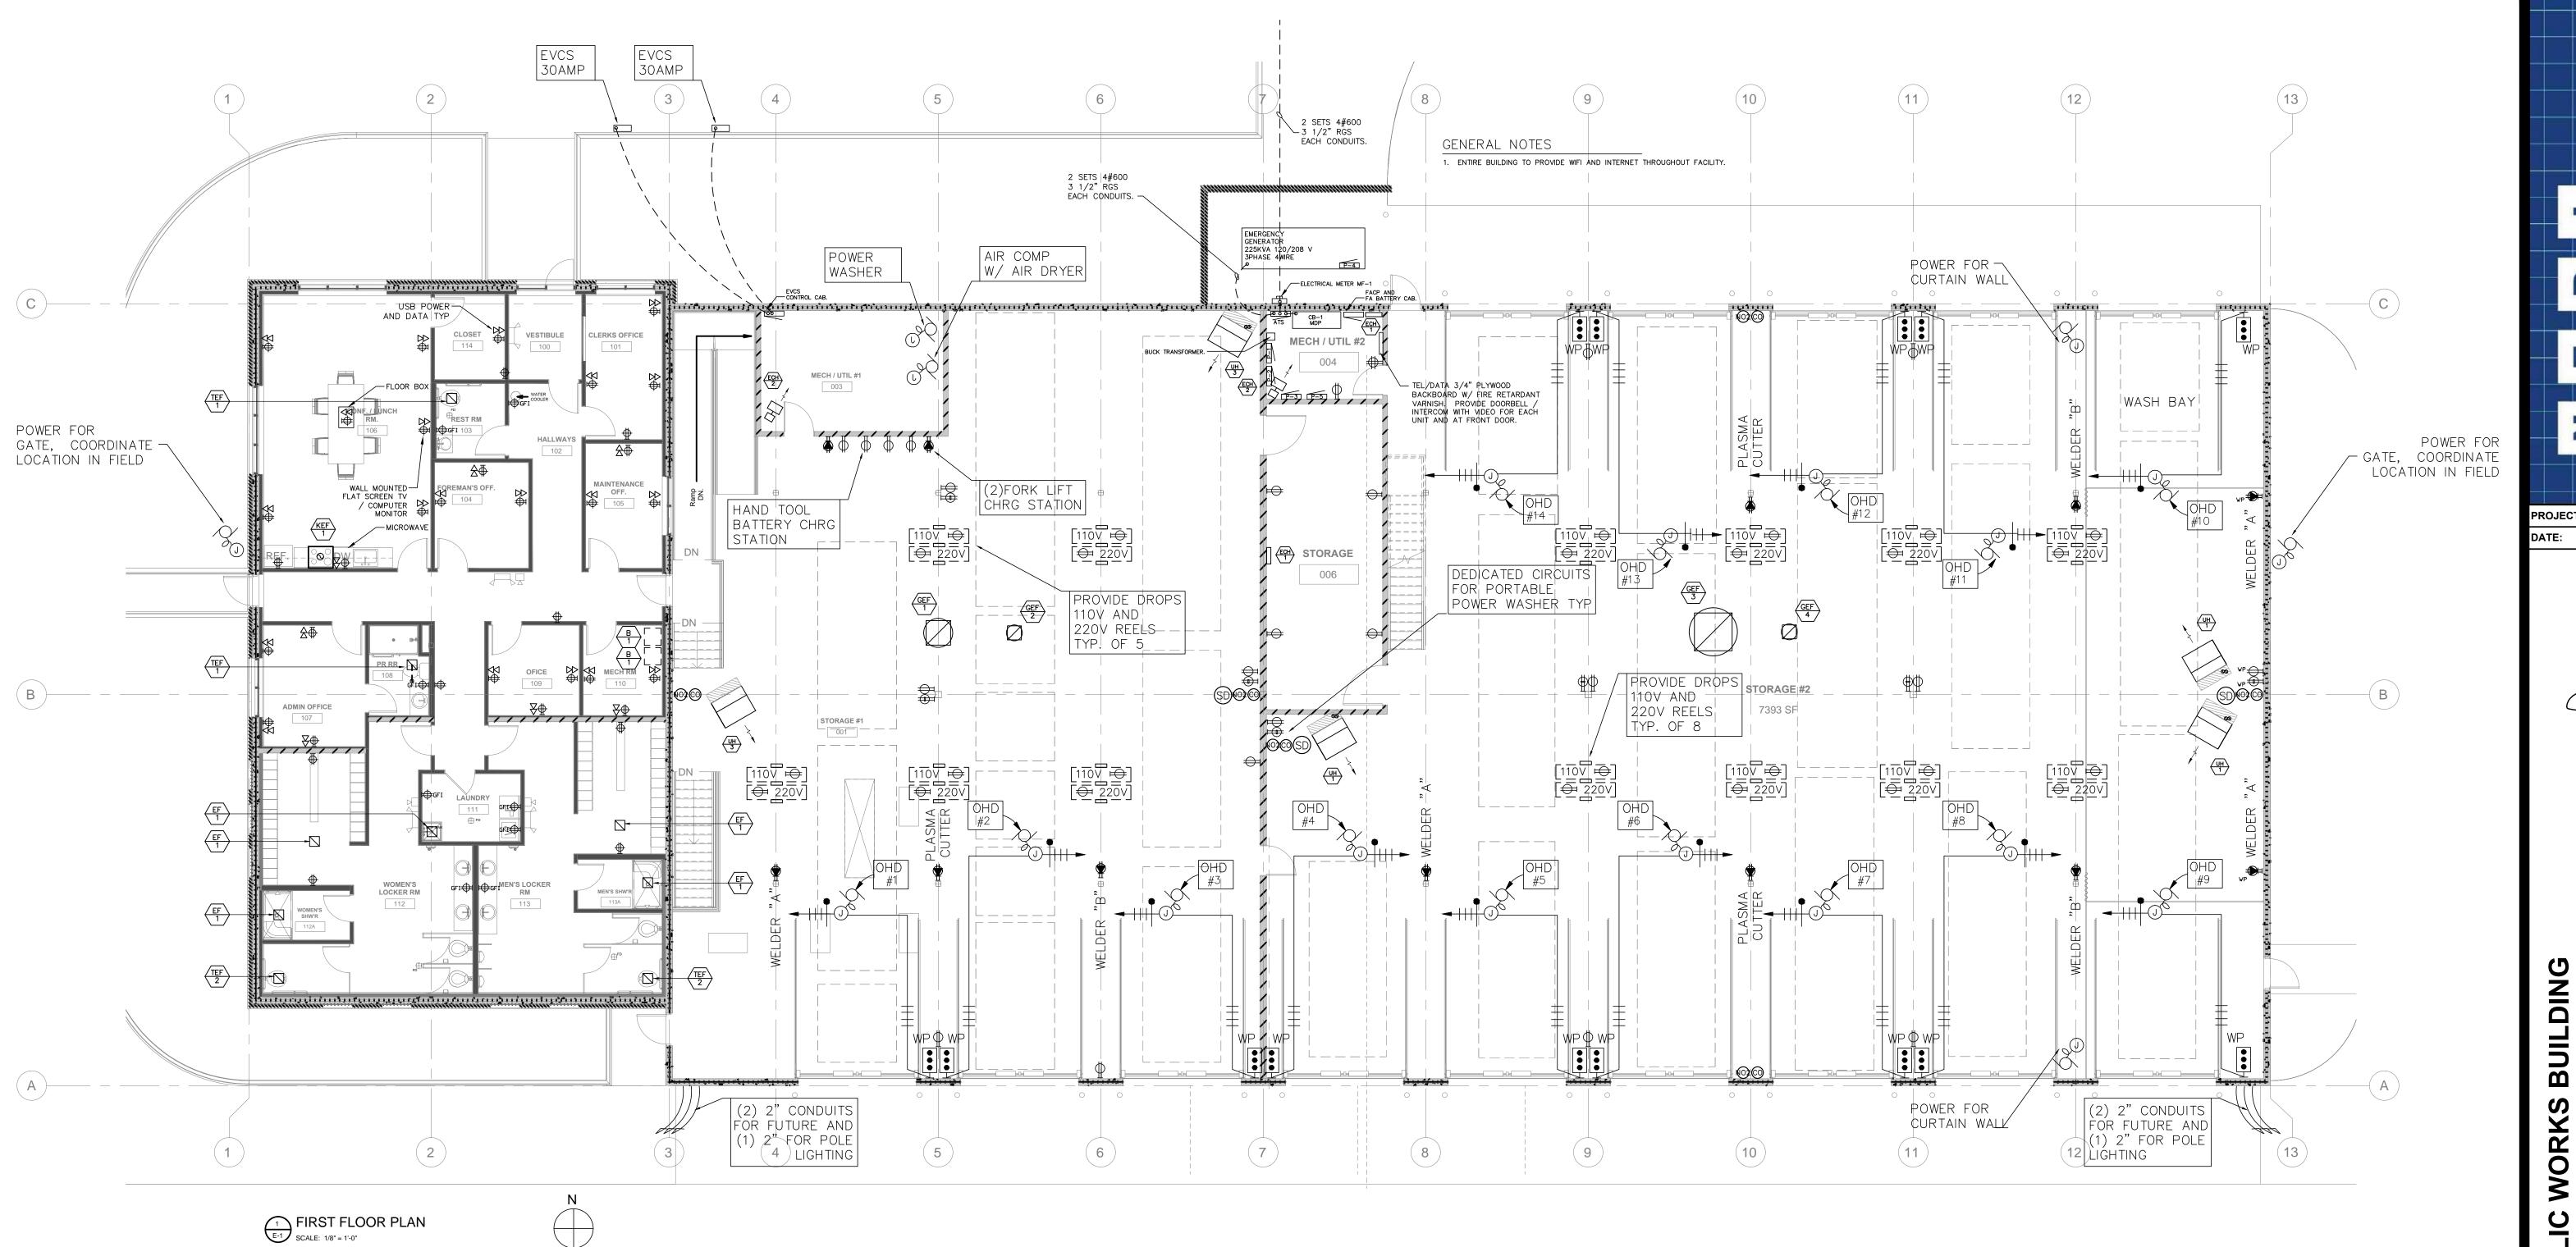

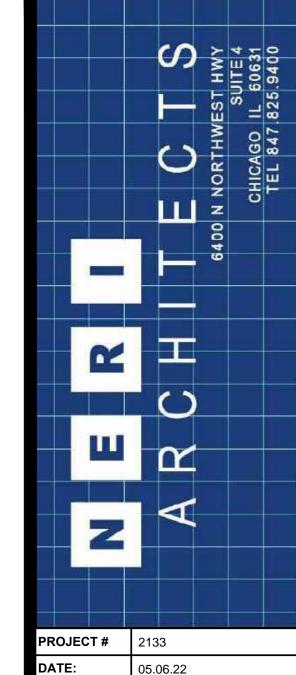

05.06.22





BUILDING


ONLY OR REFERENCE OWELL, IN AKE COUNTY


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		REVISIONS	
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DESCRIPTION: FLOOR PLAN(S)

E-1

SHEET NO.




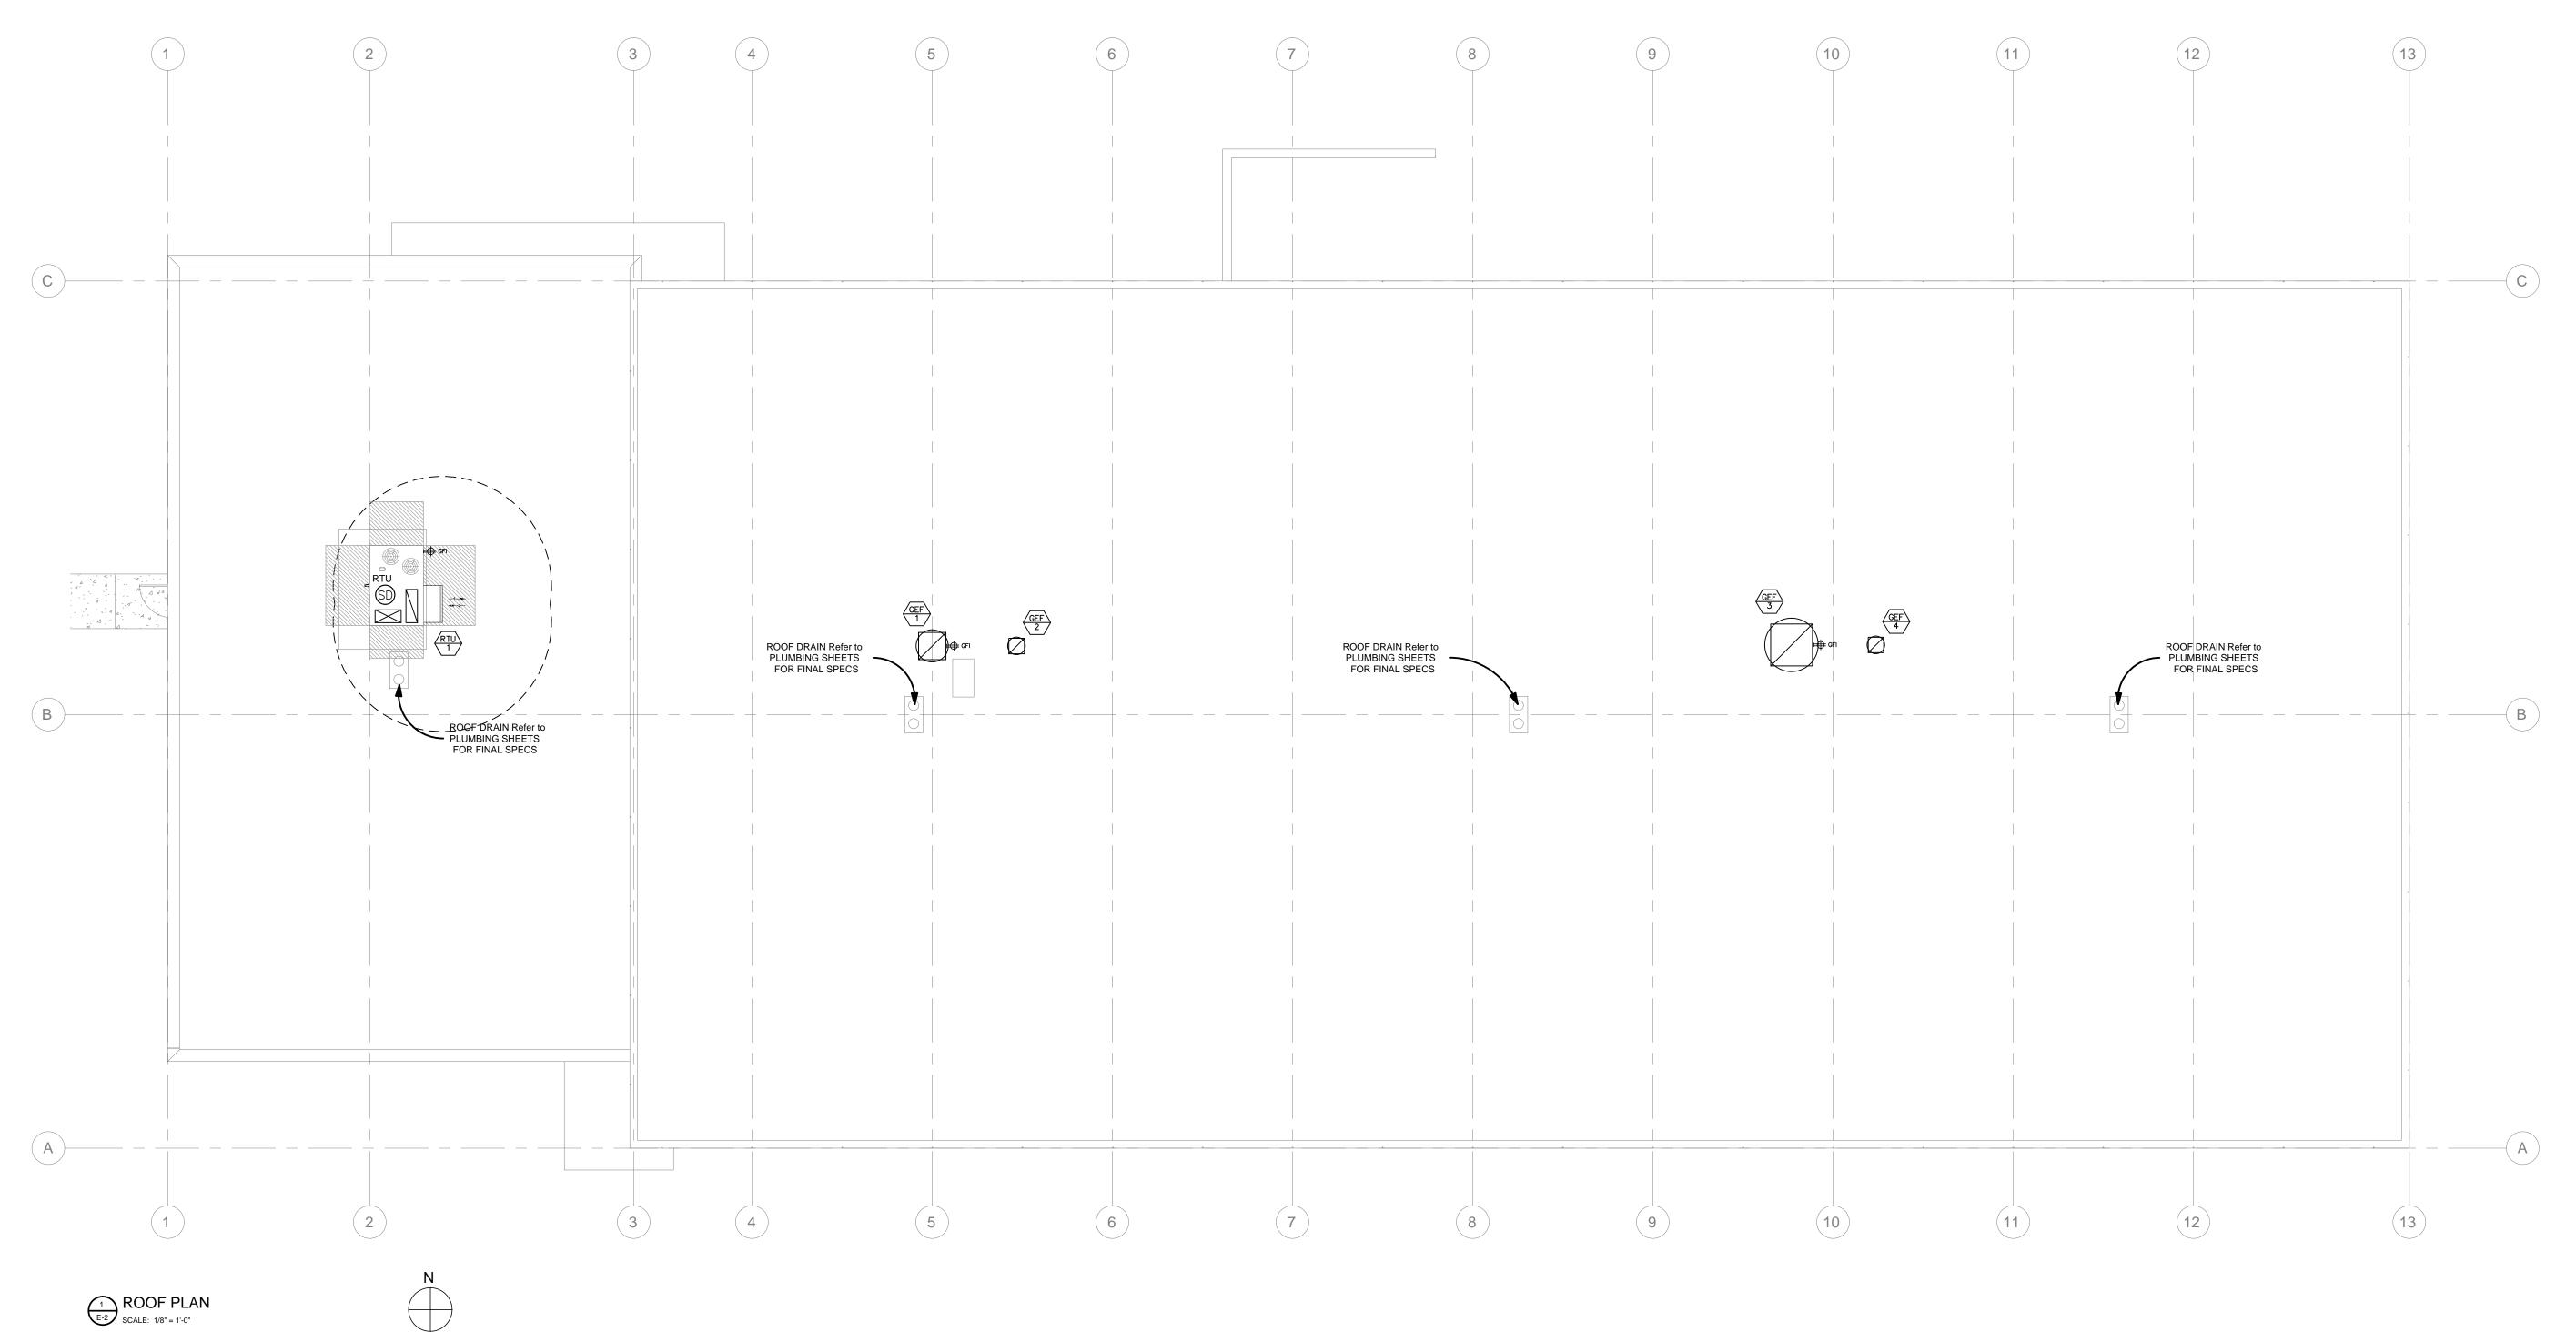

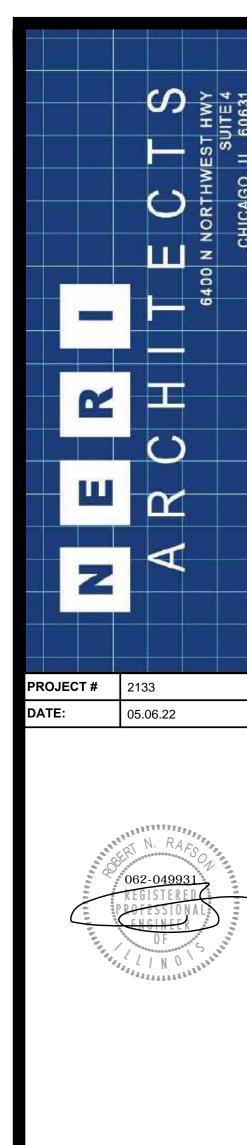
JBLIC WORKS BUILDING

LOWELL, IN LAKE COUNTY FOR REFERENCE ONLY


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	11.11.21	PROGRESS SET								
		REVISIONS								
R	AWN BY:	SM/GV								
۱P	PROVED BY	: SM/GV								
SC/	ALE:	AS NOTED								
ES	SCRIPTION:	ROOF PLAN								
SHI	EET NO.									

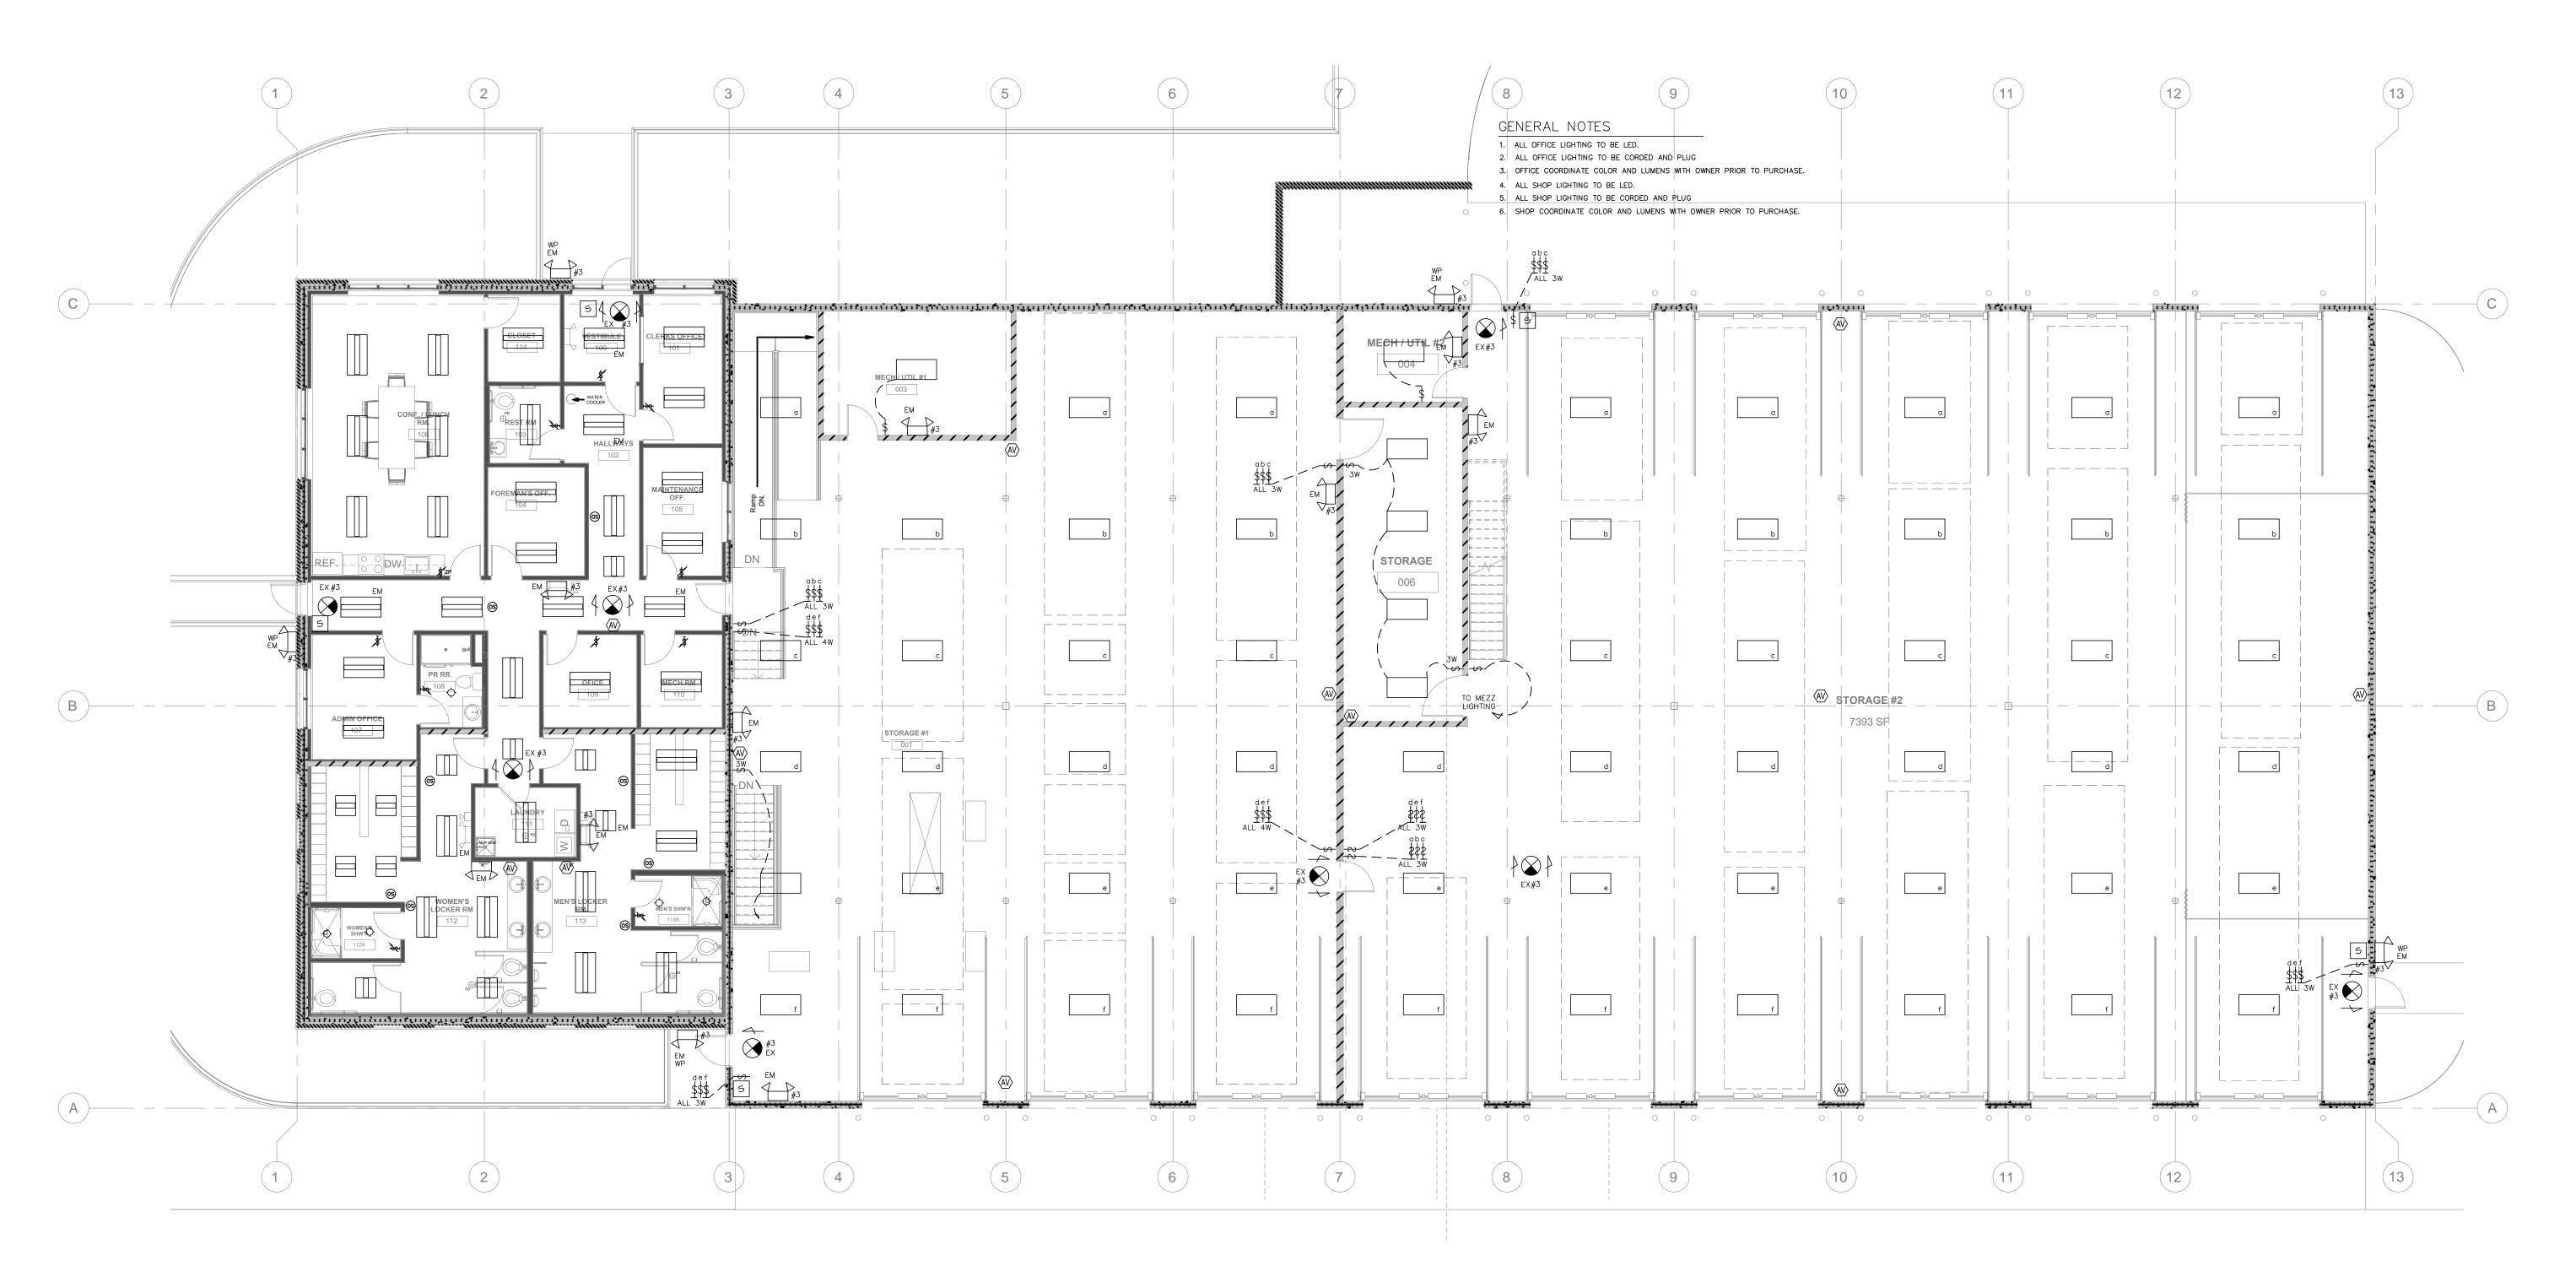


FIRST FLOOR PLAN
SCALE: 1/8" = 1'-0"

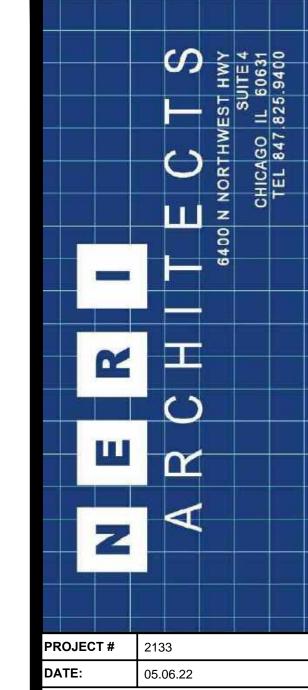

PUBLIC WORKS BUILDING	LOWELL, IN LAKE COUNTY FOR REFERENCE ONLY
05.06.22	ISSUED FOR PERMIT
11.11.21	PROGRESS SET
	REVISIONS
PRAWN BY:	SM/GV
APPROVED BY	: SM/GV
SCALE:	AS NOTED
ESCRIPTION:	ELECTRICAL LIGHTING PLAN

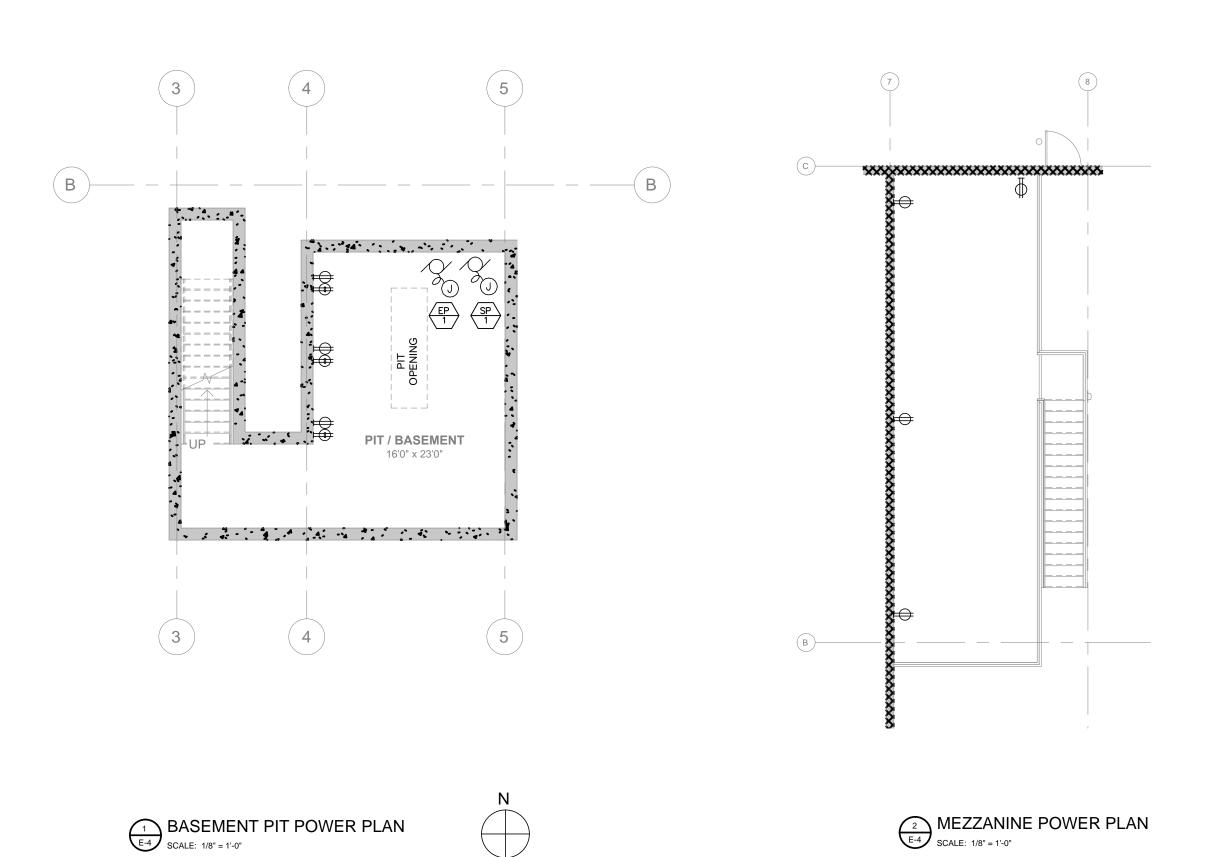

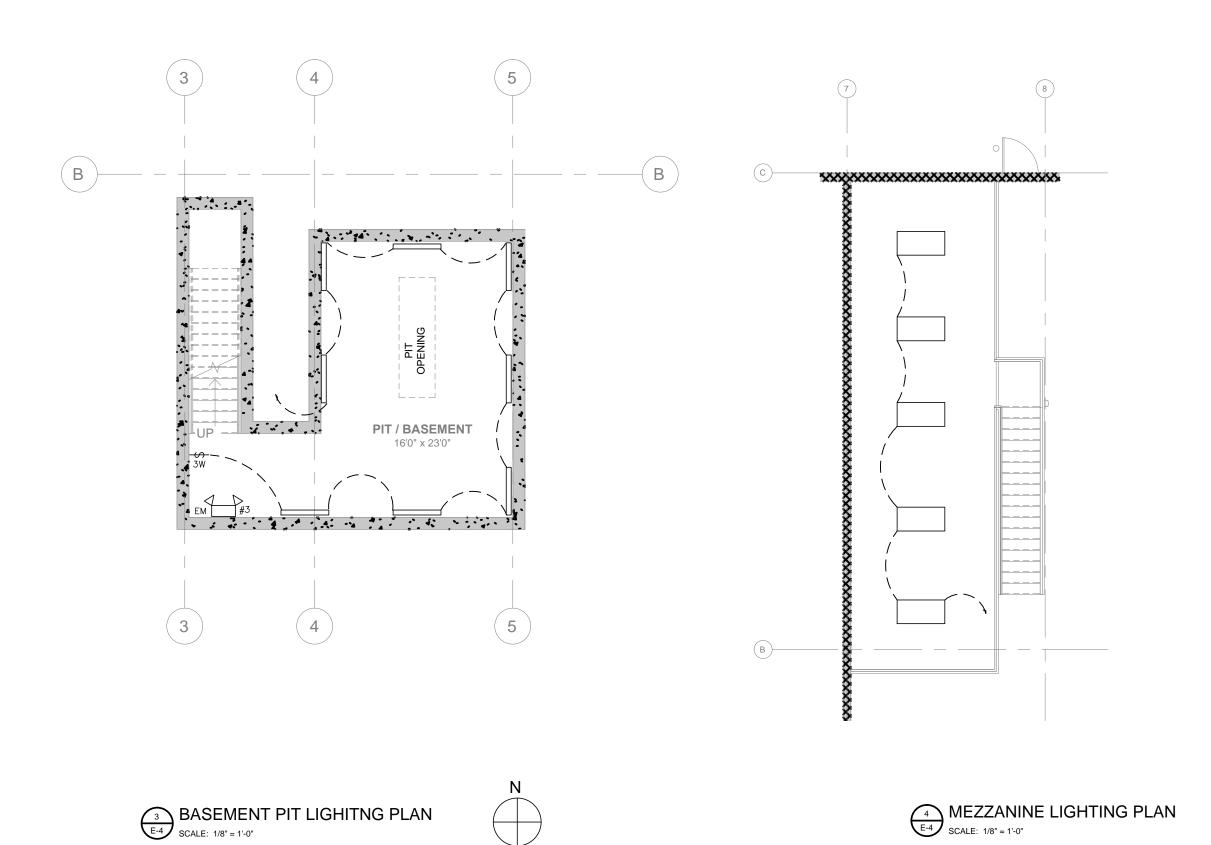

LIGHTING FIXTURE SCHEDULE NOTES:

- ELECTRICAL CONTRACTOR SHALL SUBMIT EIGHT (8) SETS OF CATALOG CUTS TO ARCHITECT/ENGINEER FOR REVIEW AND APPROVAL PRIOR TO ORDERING LIGHTING FIXTURES.
- ALL BALLASTS SHALL BE PROGRAMMABLE RAPID START, ELECTRONIC ENERGY SAVING TYPE.
- ALL EXIT SIGNS AND EMERGENCY LIGHT FIXTURES SHALL BE IN STRICT ACCORDANCE WITH LOCAL CODE AUTHORITY. ALL EXIT SIGNS SHALL BE INSTALLED IN A VISIBLE LOCATION, WITHOUT ANY OBSTRUCTIONS IN ORDER TO FACILITATE VIEWING. ELECTRICAL CONTRACTOR SHALL FURNISH AND INSTALL CONDUIT STEMS WHERE NECESSARY TO DROP A SIGN BELOW AN OBSTRUCTION.
- 4. ALLOWANCES TO BE PER FIXTURE SHOWN ON PLANS.
- ALLOWANCES TO INCLUDE FIXTURES, BULBS, TAX & DELIVERY.
- ELECTRICAL CONTRACTOR SHALL PROVIDE SUBMITTAL ON FULL LIGHTING FIXTURE PURCHASE FOR ARCHITECT'S APPROVAL PRIOR TO ORDER. FIXTURES SHALL HAVE APPROPRIATE UL LABEL, DAMP, OR WET AS REQUIRED BY LOCAL CODES.
- PROVIDE LAMPS FROM: OSRAM SYLVANIA, GE OR PHILIPS UNLESS OTHERWISE NOTED.
- CONTRACTOR SHALL VERIFY FINAL VOLTAGES AND CEILING TRIM COMPATIBILITY PRIOR TO ORDERING FIXTURES. 10. CEILING THICKNESS IN EXCESS OF 3/4" SHALL BE IDENTIFIED IN WRITING BY CONTRACTOR/ARCHITECT.
- FIXTURES LOCATED IN AN INSULATED CEILING AREA, SHALL HAVE AN IC HOUSING (ELECTRICAL CONTRACTOR TO COORDINATE). FIXTURES SHALL BE ORDERED WITH THE APPROPRIATE BALLASTS THAT HAVE UL AND CBM LABELS. BALLASTS SHALL CONFORM TO LOCAL CODE REQUIREMENTS FOR PERFORMANCE, SWITCHING, AND WRING (I.E. TANDEM).
- 13. PROVIDE APPROVED FIRE-RATED ENCLOSURES FOR LIGHTING FIXTURES LOCATED IN A FIRE-RATED CEILING.
- WALLS DIRECTLY ILLUMINATED SHALL BE INSTALLED AND FINISHED IN A MANNER TO ELIMINATE SHADOWS OR BLEMISHES (I.E. HANG DRY WALL VERTICALLY).
- THE ARCHITECT AND LIGHTING DESIGNER SHALL APPROVE FIXTURE SUBSTITUTIONS PRIOR TO BID. CONTRACTOR SHALL SUPPLY A SAMPLE AND/OR PHOTOMETRIC DATA IF REQUESTED. IF SUBSTITUTION IS REJECTED, CONTRACTOR SHALL PROVIDE SPECIFIED PRODUCT.
- 16. FIXTURES SHALL INCLUDE ACCESSORIES FOR INSTALLATION ACCORDING TO LOCAL AND NATIONAL CODES. 17. PRIOR TO ORDERING LIGHTING EQUIPMENT, THE CONTRACTOR SHALL VERIFY LOCATIONS AND RECESS DEPTHS. 18. LAMPS SHALL BE PROVIDED AND INSTALLED ACCORDING TO THE ATTACHED FIXTURE SCHEDULE.
- 19. VERIFY EXACT LOCATION AND MOUNTING HEIGHTS OF ALL LIGHTING FIXTURES WITH ARCHITECT PRIOR TO ROUGH-IN. LIGHTING WIRING NOTE
- 1. Each 120 volt lighting branch circuit shall have no more that 1500 volt amperes per each 20
- ampere 1 pole branch circuit. 2. Each 120 volt receptacle branch circuit shall be wired to no more than 6 duplex receptacles.
- 3. Each 277 volt lighting branch circuit shall have no more than 3800 volt amperes per each 20 ampere 1 pole branch circuit.

remotely configurable /upgradeable. System shall have a 5 year warranty.

LIGHTING CONTROL NOTE

Provide acuity controls nlight relay panels with 0-10v dimming and switching for all interior lighting


control. Each circuit and room shall have a separate control address. See plans for control device information. Relay panels shall be located in electrical closets. Control wiring shall utilize CAT-5e

cabling.connect the panel to a network backbone and system controller enables time based control, remote programming and monitoring from system software, and BMS integration capabilities. All relays

shall have a separate local manual override lever and is individually programmable. System shall



MEZZANINE LIGHTING PLAN
SCALE: 1/8" = 1'-0"

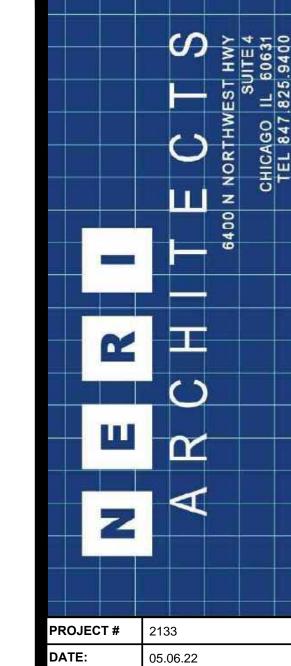



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REFE

05.06.22 ISSUED FOR PERMIT 11.11.21 PROGRESS SET REVISIONS SM/GV DRAWN BY: APPROVED BY: SM/GV AS NOTED DESCRIPTION: ELECTRICAL POWER AND LIGHTING PLAN

SHEET NO.

GENERAL ELECTRICAL SPECIFICATIONS (APPLICABLE TO ALL ELECTRICAL DRAWINGS)

1. <u>DEFINITIONS:</u>

"FURNISH" MEANS TO "SUPPLY" AND USUALLY REFERS TO DELIVERY OF AN ITEM OF EQUIPMENT TO THE PROJECT SITE, READY FOR INSTALLATION.

"INSTALL" MEANS TO SET IN PLACE, CONNECT AND PLACE IN FULL OPERATIONAL ORDER.

"PROVIDE" MEANS TO "FURNISH" AND "INSTALL".

"FUTURE", "BY OTHERS", "REFER (DISCIPLINE) DIVISION" AND SIMILAR EXPRESSIONS INDICATE WORK THAT MAY BE PERFORMED UNDER THE CONTRACT DOCUMENTS BUT, NOT NECESSARILY UNDER THE DIVISION OR DISCIPLINE ON WHICH THE NOTE APPEARS. THE CONTRACTOR SHALL BE RESPONSIBLE FOR COORDINATING THE WORK WITH SUPPLIERS, SUBCONTRACTORS, EMPLOYEES, ETC. SHOULD CLARIFICATION OF ANY PORTION OF THE WORK BE REQUIRED, CONTACT THE ARCHITECT/ENGINEER PRIOR TO SUBMITTING BID.

2. CODES:

THE WORK SHALL COMPLY WITH ALL APPLICABLE LOCAL, MUNICIPAL, AND NATIONAL CODES. THIS WOULD INCLUDE, BUT IS NOT LIMITED TO, THE CURRENT CITY BUILDING CODE, NFPA, ANSI, OSHA, AND ALL OTHER LOCAL OR MUNICIPAL BUREAUS AND DEPARTMENTS WHICH HAVE AUTHORITY OVER THE PROJECT; ANYTHING IN THESE CONTRACT DOCUMENTS NOT WITHSTANDING. THIS SHALL NOT BE CONSTRUED AS WAIVING COMPLIANCE WITH ANY REQUIREMENTS OF THE PLANS AND SPECIFICATIONS WHICH MAY BE IN EXCESS OF ANY REQUIREMENTS OF THESE CODES.

3. <u>INTERPRETATION OF THE DOCUMENTS</u>

THE CONTRACTOR SHALL CAREFULLY COMPARE THE DRAWINGS AND SPECIFICATIONS, CHECKING THE MEASUREMENTS AND CONDITIONS UNDER WHICH CONSTRUCTION IS TO BE IMPLEMENTED. FOR CLARIFICATION BETWEEN VARIOUS DRAWINGS AND/OR SPECIFICATIONS, THE DISPUTED ISSUE SHALL BE REFERRED TO THE ENGINEER BEFORE ANY WORK IS EXECUTED. THE CONTRACTOR SHALL STATE IN THEIR PROPOSAL ANY EXCEPTIONS NECESSARY TO MAKE THIS WORK A COMPLETE AND READY—TO—USE INSTALLATION. IF NOT SO—STATED IN THE CONTRACTOR'S PROPOSAL, ANY SUCH WORK WILL NOT BE CONSIDERED ADDITIONAL.

4. <u>COORDINATION</u>

THE ELECTRICAL DRAWINGS ARE DIAGRAMMATIC IN NATURE AND SHALL NOT BE SCALED. TO THIS EXTENT, DATA GIVEN ON THE DRAWINGS IS AS EXACT AS COULD BE SECURED. THE CONTRACTOR SHALL COORDINATE THE EXACT LOCATION OF ALL REQUIRED WORK AND EQUIPMENT WITH THAT OF THE OTHER TRADES. WHERE THERE ARE POTENTIAL CONFLICTS, THE CONTRACTOR SHALL OBTAIN AND VERIFY EXACT LOCATIONS, MEASUREMENTS, LEVELS, SPACE REQUIREMENTS, ETC. AT THE SITE AND SHALL SATISFACTORILY ADAPT HIS WORK TO ACTUAL FIELD CONDITIONS. REFER TO ARCHITECTURAL/MECHANICAL DRAWINGS FOR PLANS, ELEVATIONS AND DETAILS INDICATING THE LOCATIONS OF CEILING ELEMENTS (E.G., LIGHTS, SPRINKLERS, DIFFUSERS, ETC.) AND WALL ELEMENTS. CEILING MOUNTED ITEMS SHALL BE INSTALLED IN ACCORDANCE WITH THE ARCHITECTURAL REFLECTIVE CEILING PLANS. IF LOCATION FOR AN ITEM IS NOT SHOWN ON THE ARCHITECTURAL DRAWINGS, VERIFY THE EXACT LOCATION OF THE ITEM WITH THE ARCHITECT PRIOR TO INSTALLATION. THESE REQUIREMENTS APPLY TO ALL CEILING TYPES IN ALL AREAS.

5. <u>SITE EXAMINATION</u>

THE CONTRACTOR SHALL CAREFULLY EXAMINE THE CONTRACT DOCUMENTS, VISIT THE SITE, EXAMINE THE PREMISES, AND MAKE A THOROUGH SURVEY OF THE CONDITIONS UNDER WHICH CONSTRUCTION WILL BE IMPLEMENTED. THE SUBMISSION OF A PROPOSAL WILL BE CONSTRUED AS EVIDENCE THAT SUCH AN EXAMINATION HAS BEEN MADE. FAILURE TO DO SO SHALL NOT RELEIVE THE CONTRACTOR OF THE OBLIGATIONS OF THE CONTRACT. ANY LATER CLAIMS FOR LABOR, EQUIPMENT, OR MATERIALS REQUIRED FOR DIFFICULTIES ENCOUNTERED WHICH COULD HAVE BEEN FORESEEN HAD SUCH AN EXAMINATION BEEN MADE, WILL NOT BE RECOGNIZED.

6. <u>PERMITS</u>

THE CONTRACTOR SHALL SECURE, OBTAIN AND PAY FOR ALL PERMITS, INSPECTIONS, TAXES, LICENCES, AND FEES TO ALL GOVERNMENT AGENCIES REQUIRED FOR THE EXECUTION AND COMPLETION OF THE ELECTRICAL WORK. SCHEDULING OF ALL REQUIRED INSPECTIONS SHALL BE THE RESPONSIBILITY OF THE CONTRACTOR. CONTRACTOR SHALL PREPARE AND SUBMIT ALL SHOP DRAWINGS AS REQUIRED TO THE GOVERNMENTAL AGENCIES AND UTILITY COMPANIES FOR THEIR APPROVAL.

7. <u>SAFE</u>

THE CONTRACTOR SHALL TAKE ALL STEPS NECESSARY TO ENSURE THE SAFETY OF THE CLIENT'S EMPLOYEES, BUILDING EMPLOYEES AND GUESTS AS WELL AS THEIR OWN FORCES, BY ADEQUATELY PROTECTING ANY EXPOSED LIVE CABLE, EQUIPMENT, OR DEVICES THROUGHOUT THE COURSE OF THIS

8. CONTRACTOR'S DRAWING REVIEW

ALL CONTRACTORS/BIDDERS SHALL HAVE RECEIVED A COMPLETE SET OF CONSTRUCTION DOCUMENTS FOR REVIEW AND REFERENCE TO WORK INDICATED CONDUIT LOCATE SERVICES SHALL BE REQUESTED AND COMPLETED BEFORE DISTURBANCE OF ANY EXISTING GRADE OR ON-GRADE CONSTRUCTION, SLAB DEMOLITION, OR OTHER ACTIVITIES THAT MAY IMPACT BURIED UTILITIES OR COMMUNICATION CONDUITS. THE CONTRACTOR SHALL CONFIRM THAT CONDUIT LOCATE SERVICES HAVE BEEN COMPLETED AND THAT NO POTENTIAL CONFLICTS EXIST BEFORE EXISTING GRADE IS EXCAVATED OR EXISTING FLOORING DEMOLISHED, REGARDLESS OF THE LOCATION ON THE PROPERTY. THIS SHALL BE REVIEWED WITH THE OWNER'S PROJECT REPRESENTATIVE.

9. STATEMENT OF WORK

THE CONTRACTOR SHALL PROVIDE THE COMPLETE ELECTRICAL INSTALLATION OF WORK AS INDICATED IN THE CONSTRUCTION DOCUMENTS. PRIOR TO COMMENCEMENT, THE CONTRACTOR SHALL SUBMIT FOR REVIEW AND APPROVAL, ANY SEQUENCE OF WORK, MOP'S (METHOD OF PROCEEDURE) AND/OR COORDINATION SHOP DRAWINGS FOR THE INTENDED WORK. THE CONTRACTOR SHALL NOTIFY THE ARCHITECT/ENGINEER OF ANY MATERIALS OR APPARATUS BELIEVED TO BE INADEQUATE, UNSUITABLE, VIOLATION OF LAWS, ORDINANCES, RULES OR REGULATIONS OF AUTHORITIES HAVING JURISDICTION

10. <u>WORK PERFORMANCE REQUIREMENTS</u>

ANY PENETRATIONS OR OPENINGS IN FIRE—RATED PARTITIONS (WALLS OR FLOORS) SHALL BE CLOSED AT THE END OF EACH WORK DAY, OR WHENEVER IT IS ANTICIPATED THAT NO FURTHER WORK WILL OCCUR IN THAT OPENING DURING THE DAY. THIS INCLUDES ALL TEMPORARY OPENINGS. CLOSURE SHALL BE IN COMPLIANCE WITH 3M FIREPROOFING PRODUCT SPECIFICATIONS. ALL ROOF PENETRATIONS SHALL BE SEALED WATERTIGHT AT THE END OF EACH WORK DAY. ALL TEMPORARY WALL AND FLOOR OPENINGS SHALL BE PROTECTED AND MARKED AT ALL TIMES. PAINTING SHALL BE SCHEDULED SUCH THAT DRYING TIME OCCURS DURING NON—WORKING HOURS FOR OPERATIONS PERSONNEL COMFORT. NO WELDING SHALL TAKE PLACE INSIDE OF OPERATING FACILITY WITHOUT THE WRITTEN AUTHORIZATION OF THE OWNER'S PROJECT REPRESENTATIVE. WELDING SHALL NOT TAKE PLACE WITHIN 5 FEET OF ANY TELECOM EQUIPMENT RACK WITHOUT ADEQUATE PROTECTIVE MEASURES, AS DEEMED APPROPRIATE BY THE OWNER'S PROJECT REPRESENTATIVE. THE CONTRACTOR SHALL CHECK, VERIFY AND LABEL PHASE ROTATION ANY TIME LEADS ARE CONNECTED TO A NEW OR EXISTING AC SERVICE, GENSET, RECTIFIER OR ANY MOTOR—EQUIPPED, 3—PHASE EQUIPMENT. ALL THREE—PHASE PANELS SERVING SINGLE—PHASE LOADS SHALL BE BALANCED WITHIN 10 PERCENT, USING AMMETER READINGS. MEASUREMENTS SHALL BE TAKEN AT THE END OF CONSTRUCTION AND AGAIN AFTER 30 DAYS IN SERVICE.

11. <u>CUTTING AND PATCHING</u>

ALL CUTTING, DRILLING AND PATCHING OF MASONRY STEEL OR IRON WORK BELONGING TO THE BUILDING MUST BE DONE BY THIS CONTRACTOR IN ORDER THAT HIS WORK MAY BE PROPERLY INSTALLED, BUT UNDER NO CONDITIONS MAY STRUCTURAL WORK BE CUT, EXCEPT AT THE DIRECTIONS OF THE ARCHITECT/ENGINEER OR THEIR REPRESENTATIVE.

12. AS-BUILT DRAWINGS

THE CONTRACTOR SHALL PROVIDE ALL "AS-BUILT" DRAWINGS SACLED 1/4" MINIMUM AND SUBMIT FOR APPROVAL TO THE ARCHITECT/ENGINEER.

13. FIRESTOPPING

ALL PENETRATIONS IN WALLS, FLOORS, OR CEILINGS SHALL BE SUITABLY CLOSED UP AND SEALED WITH A FIRESAFING COMPOUND LISTED IN THE MOST RECENT FACTORY MUTUAL RESEARCH CORPORATION (FMRC) APPROVAL GUIDE. ONLY PRODUCTS MANUFACTURED BY HILTI SHALL BE PREFERRED (NO SUBSTITUTIONS).

14. TEMPORARY POWER AND LIGHTING

THE CONTRACTOR SHALL PROVIDE TEMPORARY POWER AND LIGHTING FOR THIS WORK DURING CONSTRUCTION. TEMPORARY LIGHTING SHALL AT LEAST BE THE EQUAL OF (1)100-WATT FIXTURE EVERY 100 SQUARE FEET, WITH A MINIMUM ONE FIXTURE PER ROOM. TEMPORARY LIGHTING SHALL BE LEFT IN PLACE UNTIL PERMANENT LIGHTING IS COMPLETELY OPERATIONAL. COORDINATE TEMPORARY POWER REQUIREMENTS WITH THE OTHER TRADES AND PROVIDE ADEQUATE PROVISIONS. THE CONTRACTOR SHALL PERFORM ALL COORDINATION WITH THE OWNER AND/OR LANDLORD.

15. SWITCH AND RECEPTACLE IDENTIFICATION

PROVIDE MACHINE—PRINTED, PRESSURE SENSITIVE, ABRASION RESISTANT LABEL TAPE ON FACE OF ALL DEVICE PLATES TO IDENTIFY THE PANELBOARD AND CIRCUIT NUMBER FROM WHICH EACH DEVICE IS SERVED.

16. UTILITY COMPANY COORDINATION

THE CONTRACTOR SHALL PERFORM ALL COORDINATION AND SCHEDULING OF THE INSTALLATION OF THE NEW ELECTRICAL SERVICE WITH THE LOCAL UTILITY COMPANY.

17. EXCAVATION/UNDERGROUND UTILITIES

UNDERGROUND UTILITY LOCATE SERVICES SHALL BE REQUESTED AND COMPLETED BEFORE DISTURBANCE OF ANY EXISTING GRADE OR ON-GRADE CONSTRUCTION, SLAB DEMOLITION, OR OTHER ACTIVITIES THAT MAY IMPACT BURIED UTILITIES OR FIBER-OPTIC CABLE CONDUITS. THE CONTRACTOR SHALL CONFIRM THAT UTILITY LOCATE SERVICES HAVE BEEN COMPLETED BEFORE EXISTING GRADE IS EXCAVATED OR EXISTING FLOORING IS DEMOLISHED, DRILLED, OR CUT, REGARDLESS OF THE LOCATION ON THE PROPERTY.

18. PANELBUARDS

ALL PANELBOARDS IN WHICH WORK OCCURS PER THESE DOCUMENTS, SHALL BE PROVIDED WITH UPDATED-TYPEWRITTEN DIRECTORIES. GIVEN ONLY FOR CLARITY AND QUANTITY, CIRCUIT NUMBERS SHOWN IN THE PLANS MAY NOT NECESSARILLY REPRESENT ACTUAL CIRCUIT NUMBERS IN PANELBOARD. FROM FLUSH-MOUNTED PANELBOARDS, STUB-OUT ONE 3/4" CONDUIT INTO THE CEILING CAVITY FOR EACH SET OF 3 SPARES AND/OR SPACES OR FRACTION THEREOF.

19, CABLEING

UNLESS NOTED OTHERWISE, ALL WIRE AND CABLE SHALL BE 600-VOLT COPPER CONDUCTORS WITH TYPE "THHN/THWN" INSULATION. MINIMUM WIRE SIZE SHALL BE #12 AWG FOR LIGHTING AND POWER CIRCUITS AND #14 AWG FOR CONTROL CIRCUITS. PROVIDE GROUNDING FOR CIRCUITS PER THE NEC. UNLESS SPECIFICALLY NOTED OTHERWISE IN THE PLANS, ALL CABLING SHALL BE (2) #12 AND (1) #12 G IN 3/4" C.

20. CABLE SIZING

BRANCH CIRCUIT CABLE SIZE SHALL BE ADJUSTED BASED ON THE CONDUCTOR LENGTH, AS INDICATED BELOW:

A.) 120/208V CABLING FROM PANEL TO ELECTRICAL LOAD SHALL BE AS FOLLOWS, UNLESS OTHERWISE INDICATED:

LESS THAN 100 FEET, USE #12 AWG MINIMUM FROM 100 TO 200 FEET, USE #10 AWG MINIMUM FROM 200 TO 250 FEET, USE #8 AWG MINIMUM

B.) 277/480277/480V CABLING FROM PANEL TO ELECTRICAL LOAD SHALL BE AS FOLLOWS, UNLESS OTHERWISE INDICATED:

FROM 0 TO 150 FEET, USE #12 AWG MINIMUM FROM 150 TO 250 FEET, USE #10 AWG MINIMUM FROM 250 TO 300 FEET, USE #8 AWG MINIMUM

21. COMMUNICATIONS WIRING CONDUIT SIZING

ALL DATA AND TELEPHONE OUTLET WIRING SHALL TERMINATE IN THE DATA/MDF ROOM. ALL DATA AND TELEPHONE WIRING SHALL BE PROVIDED BY THE ELECTRICAL CONTRACTOR AND SHALL BE INSTALLED IN CONDUIT. ELECTRICAL CONTRACTOR SHALL PROVIDE CONDUITS FOR DATA AND TELEPHONE OUTLETS AS FOLLOWS:

3 CABLES-3/4"C	13 CABLES-1 1/2"C	47 CABLES-3"C
5 CABLES-1"C	21 CABLES-2"C	63 CABLES-3 1/2
9 CABLES-1 1/4"C	30 CABLES-2 1/2"C	81 CABLES-4"C

22. CONDUIT/RACEWAY SYSTEMS

THE CONDUIT ROUTINGS INDICATED ARE ONLY DIAGRAMMATIC IN NATURE. FIELD CONDITIONS SHALL DICTATE THE CONTRACTOR'S EXACT CONDUIT ROUTING. THE CONTRACTOR SHALL BE RESPONSIBLE FOR SIZING AND LOCATING PULL BOXES PER THE NEC AND FOR COORDINATION WITH OTHER DISCIPLINES. ALL EXPOSED RACEWAYS SHALL BE INSTALLED PARALLEL OR PERPENDICULAR TO WALLS OR STRUCTURAL MEMBERS, SUCH AS TO FOLLOW STRUCTURAL SURFACE CONTOURS AND NOT OBSTRUCT PASSAGEWAYS. MULTIPLE RACEWAYS SHALL BE RUN TOGETHER, IN GROUPING. ALL EXPOSED CONDUIT SHALL BE ROUTED PERPENDICULAR, PARALLEL AND TIGHT TO COLUMNS AND BEAMS. ALL EXPOSED CONDUIT SHALL BE COORDINATED WITH THE ARCHITECT/ENGINEER PRIOR TO INSTALLATION. EXTRA TIME SHOULD BE ALLOWED FOR THIS REVIEW AND APPROVAL. NO ADDITIONAL COST TO OWNER WILL BE ALLOWED DUE TO LACK OF COORDINATION. ALL CONDUIT SHALL BE ELECTRICAL METALLIC TUBING (EMT) AND MINIMUM SIZE SHALL BE 3/4" UNLESS NOTED OTHERWISE. CONNECTORS AND COUPLINGS SHALL BE INSULATED—THROAT COMPRESSION TYPE ONLY. RIGID GALVANIZED—STEEL (RGS) CONDUIT SHALL BE USED WHEN CONDUIT IS INSTALLED IN OUTDOOR AREAS OR WHERE OTHERWISE EXPOSED TO PHYSICAL HARM. EMERGENCY SYSTEMS SHALL BE RUN IN SEPARATE RACEWAY/CONDUIT SYSTEM(S). A SEPARATE INSULATED EQUIPMENT GROUNDING CONDUCTOR SHALL BE PULLED WITH THE CIRCUIT CONDUCTORS, WHETHER OR NOT INDICATED ON THE DRAWINGS. METAL RACEWAY OR CABLE ARMOR/SHEATH SHALL NOT BE USED AS THE PRIMARY EQUIPMENT GROUNDING CONDUCTOR. RACEWAY SYSTEMS SHALL BE MECHANICALLY AND ELECTRICALLY CONTINUOUS AND SHALL BE BONDED AT ALL POINTS TO THE INSULATED EQUIPMENT GROUNDING CONDUCTOR. RACEWAY SYSTEMS SHALL BE MECHANICALLY AND ELECTRICALLY CONTINUOUS AND SHALL BE BONDED AT ALL POINTS TO THE INSULATED EQUIPMENT GROUNDING CONDUCTOR IN ACCORDANCE WITH THE APPLICABLE PROVISIONS IN ARTICLE 250 OF THE NEC.

23. EQUIPMENT

ALL MATERIALS AND EQUIPMENT PROVIDED IN THIS WORK SHALL BE NEW AND SHALL HAVE THE APPROPRIATE UL LISTING AND/OR FM APPROVAL.
UNLESS NOTED OTHERWISE, DISCONNECT/SAFETY SWITCHES SHALL BE NON-FUSED HEAVY-DUTY 600-VOLT TYPE. INDOOR ENCLOSURES SHALL BE NEMA 1 AND OUTDOOR ENCLOSURES SHALL BE NEMA 3R.

24. MECHANICAL EQUIPMENT

ALL MECHANICAL EQUIPMENT WILL BE INSTALLED BY THE DIVISION 15 CONTRACTOR. COORDINATE THE EXACT LOCATION AND NATURE OF ANY REQUIRED ELECTRICAL CONNECTION TO BE PROVIDED FOR MECHANICAL EQUIPMENT PRIOR TO ROUGH—IN. VERIFY THE ELECTRICAL SERVICE REQUIRED FOR EACH ITEM OF MECHANICAL EQUIPMENT WITH THE MECHANICAL CONTRACTOR PRIOR TO FURNISHING SUCH POWER. REFER TO MECHANICAL DRAWING FOR MECHANICAL EQUIPMENT REQUIRING ELECTRICAL CONNECTIONS. MAKE CONNECTION AND PROVIDE APPROPRIATE WIRE, CONDUIT AND OVERCURRENT PROTECTION FOR EQUIPMENT. THE DISCONNECTING MEANS FOR ALL MECHANICAL EQUIPMENT SHALL BE ACCESSIBLE AND HAVE CLEARANCES AS REQUIRED BY THE NEC. MOTORS SHALL BE FURNISHED AND INSTALLED UNDER DIVISION 15 WORK, WITH POWER CONNECTED UNDER DIVISION 16 WORK. FINAL CONNECTION SHALL BE MADE WITH SUITABLE LENGTH OF LIQUID—TIGHT FLEXIBLE METALLIC CONDUIT. ALL MOTOR BRANCH CIRCUITS, ETC., SHALL BE FIELD—VERIFIED FOR PROPER SEQUENCE AND MOTOR ROTATION. PHASE SEQUENCE SHALL BE A—B—C (VIEWED FROM FRONT: LEFT TO RIGHT, TOP TO BOTTOM, FRONT TO REAR). REFER TO MECHANICAL DRAWINGS FOR MOTORS THAT ARE TO BE INTERLOCKED.

25. MISCELLANEOUS SUPPORTING MEMBERS

ALL ANGLES, CHANNELS, AND OTHER MISCELLANEOUS STEEL, BOLTS, THREADED RODS, ETC., REQUIRED TO SUPPORT LIGHT FIXTURES, LADDER TRAY OR OTHER ELECTRICAL EQUIPMENT OR DEVICES SHALL BE FURNISHED AND INSTALLED BY THE CONTRACTOR. ALL THREADED RODS SHALL BE A MINIMUM OF 3/8" IN DIAMETER. ALL LIGHTING FIXTURES AT SUSPENDED CEILINGS SHALL BE PROPERLY SUPPORTED IN ACCORDANCE WITH 2006 NEC ARTICLES 410, 300—11 ETC.

GENERAL ELECTRICAL NOTES


- (APPLICABLE TO ALL ELECTRICAL DRAWINGS)
- 1 EMERGENCY SIGNS REQUIRED FOR ELEVATORS SHALL BE 7 INCHES BY 5 INCHES AND READ AS FOLLOWS: IN FIRE EMERGENCY, DO NOT USE ELEVATOR. USE EXIT STAIRS.
- 2 DOORS INTO ELECTRICAL CONTROL PANEL ROOMS SHALL BE MARKED WITH A PLAINLY VISIBLE AND LEGIBLE SIGN STATING ELECTRICAL ROOM OR SIMILAR APPROVED WORDING.
- 3 THE DISCONNECTING MEANS FOR EACH SERVICE, FEEDER OR BRANCH CIRCUIT ORIGINATING ON A SWITCHBOARD OR PANELBOARD SHALL BE LEGIBLY AND DURABLY MARKED TO INDICATE ITS PURPOSE UNLESS SUCH A PURPOSE IS CLEARLY EVIDENT.
- 4 EXIT SIGNS SHALL BE ILLUMINATED AT ALL TIMES AND HAVE EMERGENCY POWER BACKUP. PROPER LOCATION AND EFFECTIVENESS OF EMERGENCY LIGHTING AND FIRE EXTINGUISHERS WHERE APPLICABLE WILL BE VERIFIED DURING THE INSPECTION PROCESS. CHNGES OR ADDITIONAL EQUIPMENT MAY BE REQUIRED.
- 5 ALL NEW ELEVATORS SHALL BE QUIPED WITH EMERGENCY KEY OPENING DEVICE AT ALL LANDINGS. THE LOCATION AND SPECIFIC TYPE OF DEVICE SHALL BE APPROVED BY THE FIRE DEPARTMENT.
- 6 IF THE ELEVATOR USES AN AUTOMATIC DIALER, THE TEN DIGIT NUMBER 847.590.3470 SHALL BE USED. TH BIDIRECTIONAL COMMUNICATION IS AVAILABLE AND IS USED, THE ELEVATOR SHOULD CALL 911. THE PHONE LINE USED TO DIAL 911 MUST HAVE THE CORRECT ADDRESS INFORMATION AFFILIATED WITH THAT PHONE LINE.
- 7 FIRE ALARM SHOP DRAWINGS SHALL BE SUBMITTED UNDER A SEPARATE PERMIT APPLICATION THE REVIEW AND APPROVAL PRIOR TO ANY INSTALLATION.
- DUCT SMOKE DETECTORS SHALL BE LOCATED IN THE MAIN RETURN AIR AND EXHAUST AIR PLENUM OF EACH AIR CONDITIONING SYSTEM HAVING A CAPACITY GREATER THAT 2,000 CUBIC FEET PER MINUTE (CFM). DETECTORS SHALL BE LOCATED IN THE SERVICEABLE AREA DOWNSTREAM OF THE LAST DUCT INLET AND AT EACH CONNECTION TO A VERTICAL DUCT OR RISER SERVING TWO OF MORE STORIES FROM A RETURN AIR DUCT OR PLENUM OF AN AIR—CONDITIONING SYSTEM. SMOKE DETECTORS INSTALLED IN THE DUCTS SHALL BE LISTED FOR THE AIR VELOCITY, TEMPERATURE AND HUMIDITY PRESENT IN THE DUCT. DUCT SMOKE DETECTORS SHALL BE ACCESSIBLE AND CONNECTED TO THE BUILDINGS FIRE ALARM CONTROL UNIT WHEN A FIRE ALARM SYSTEM IS REQUIRED. ACTIVATION OF A DUCT DETECTOR SHALL INITIATE A VISIBLE AND AUDIBLE SUPERVISORY SIGNAL. DUCT SMOKE DETECTORS SHALL NOT BE USED AS A SUBSTITUTE FOR REQUIRED OPEN
- 9 ALL WORK MUST COMPLY WITH THE 2005 NATIONAL ELECTRICAL CODE 2008 STATE OF INDIANA ELECTRICAL CODE AND ANY ELECTRICAL AMENDMENTS FOUND IN THE MUNICIPAL CODE.
- 10 ALL CONDUCTORS SHALL BE COPPER
- 11 ½" INCH PLYWOOD SHALL BE INSTALLED BEHIND ALL WALL MOUNTED MAIN DISCONNECT
- PANELBOARDS. SECTION: 91(D).

 12 ALL UNDERGROUND CONDUIT WITHIN THE FOUNDATION WALLS SHALL BE RIGID
- GALVANIZED STEEL SECTION: VAH 74(A)

 13 RECEPTACLES AT THE EXTERIOR ROOF DECK AND ALL BALCONIES SHALL BE GFCI.
- 14 WATER PIPES AND GAS PIPE OF THE WATER HEATERS SHALL BE BONDED TOGETHER. SECTION: NEC 250.104(B)
- 15 DISHWASHERS SHALL HAVE A DISCONNECT SWITCH FOR EACH UNIT INCLUDING THE
- 16 APPLIANCES AND EQUIPMENT SHALL HAVE A DISCONNECT SWITCH INCLUDING EACH FURNACE, WATER HEATER AND AIR CONDITIONER.
- 17 RESIDENTIAL GENERAL LIGHTING SHALL NOT HAVE MOTE THAN 10 DEVICES PER CIRCUIT WITH A RATING OF NOT MORE THAT 15 AMPS.
- 18 ELECTRICAL BOXES SHALL BE AT LEAST 4"X4"X1 $\frac{1}{2}$ " IN SIZE.
- 19 GROUNDING CONDUCTORS SHALL BE INSULATED AND GREEN OR GREEN WITH YELLOW STRIPE.
- 20 WIRING FOR VOLTAGE ID: 120V-208V-240V SHALL BE BLACK, RED, AND BLUE WITH THE NEUTRAL WHITE ONLY. SECTION: 113(A)
- 21 EQUIPMENT GROUNDING CONDUCTOR FOR EACH PARKING LOT LIGHT POLE SHALL BE INSTALLED FROM THE ELECTRICAL PANEL TO EACH LIGHT POLE. THE CONDUCTOR SHALL BE SIZED PER 2008 STATE OF INDIANA ELECTRICAL CODE NEC TABLE 250.122 BASED ONT E SIZE OF THE CIRCUIT FOR THE PARKING LOT LIGHTS. BY VILLAGE ORDINANCE THE EQUIPMENT GROUNDING CONDUCTOR SHALL HAVE INSULATION OF GREEN OR GREEN WITH YELLOW STRIPE. SECTION: NEC 250.110 AND 410.15(B)
- 22 EQUIPMENT BONDING JUMPER SIZED ACCORDING TO 2008 TABLE 250.122 SHALL
- BOND EACH METAL LIGHT POLE TO THE EQUIPMENT GROUNDING CONDUCTOR.

 23 LOCATION OF THE METER CLOSETS FOR EACH FLOOR SHALL BE PROPERLY LABELED.
- 24 ONE GROUND CONDUCTOR SHALL RUN UNINTERRUPTED TO THE WATER SERVICE.

 25 SMOKE DETECTORS SHALL BE ARC—FAULT CIRCUIT INTERRUPTER PROTECTED.

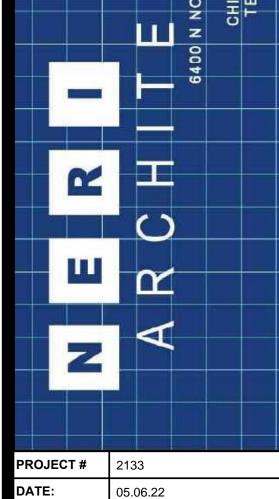



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	05.06.22	ISSUED FOR PERMIT
	11.11.21	PROGRESS SET
		REVISIONS
DR	AWN BY:	SM/GV
API	PROVED BY	: SM/GV
sc	ALE:	AS NOTED
DES	SCRIPTION:	ELEC SCHEDULES,

NOTES & DETAILS

SHEET NO.

LIGHTING CONTROLS SCHEDULE

LIGHTING CONTROL NOTES:

ALL SENSORS SELF-ADAPTING.

- 2. VERIFY NUMBER OF CONTROL UNITS.
- ELECTRICAL CONTRACTOR SHALL PROVIDE 1/4" SCALED LIGHTING CONTROL SHOP DRAWINGS CONSISTING OF ENGINEERED PLANS AND LIGHTING CONTROL DEVICE SCHEDULE FROM LIGHTING CONTROL MANUFACTURER FOR ENGINEER'S REVIEW.


SENSOR TAG	MANUFACTURER AND CATALOG NUMBER	FIELD VIEW	VOLT	LOCATION	REMARKS
*	SENSOR SWITCH ACUITY #WSX-PDT	SHORT: 20'	120 VAC	SMALL TOILET ROOMS, SMALL STORAGE ROOMS, UTILITY AND AUX. ROOMS	1-POLE DUAL TECHNOLOGY (PIR/MICROPHONICS) OCCUPANCY SENSOR, SELF-ADJUSTING WHITE, 120/277 VAC 800/1200 WATTS PER CIRCUIT WITH 180 DEGREE COVERAGE AND BUILT-IN MANUAL OVERRIDE CONTROL TO MANUALLY SHUT LIGHTS OFF WHEN DESIRED.
₹ 2P	SENSOR SWITCH ACUITY #WSX-PDT-2P	SHORT: 20'	120 VAC	CONF. ROOMS	2-POLE DUAL TECHNOLOGY (PIR/MICROPHONICS) OCCUPANCY SENSOR, SELF-ADJUSTING WHITE, 120/277 VAC 800/1200 WATTS PER CIRCUIT WITH 180 DEGREE COVERAGE AND TWO BUILT-IN MANUAL OVERRIDE CONTROL TO MANUALLY SHUT EITHER CIRCUIT OFF WHEN DESIRED.
(OS)	SENSOR SWITCH ACUITY WV-16	LONG: 30' SHORT: 12'	120 VAC	SURFACE CEILING GARAGE, LOCKER	DUAL TECHNOLOGY OCCUPANCY SENSOR, EXTENDED RANGE, SELF ADAPTING, UL LISTED POWER PACK. PROVIDE VIDE VIEW SENSOR MICROPHONIC-DUAL TECHNOLOGY-12 TO 24 VDC/VAC

SENSOR NOTES

- 1. SENSORS IN ELECTRICAL/MECHANICAL LOCATIONS NEED TO BE VERIFIED WITH AUTHORITY HAVING JURISTICTION. REFER TO NEC 110.26.D):
 "ILLUMINATION. ILLUMINATION SHALL BE PROVIDED FOR ALL WORKING SPACES ABOUT SERVICE
 - "ILLUMINATION. ILLUMINATION SHALL BE PROVIDED FOR ALL WORKING SPACES ABOUT SERVICE EQUIPMENT, SWITCHBOARDS, PANELBOARDS, OR MOTOR CONTROL CENTERS INSTALLED INDOORS. ADDITIONAL LIGHTING OUTLETS SHALL NOT BE REQUIRED WHERE THE WORK SPACE IS ILLUMINATED BY AN ADJACENT LIGHT SOURCE OR AS PERMITTED BY 210.70(A)(1), EXCEPTION NO. 1, FOR SWITCHED RECEPTACLES. IN ELECTRICAL EQUIPMENT ROOMS, THE ILLUMINATION SHALL NOT BE CONTROLLED BY AUTOMATIC MEANS ONLY."
- 2. SENSORS ON DRAWINGS WERE PLACED WITH CURRENT INFORMATION. ADDITIONAL SENSORS MAY BE REQUIRED TO PROVIDE COMPLETE COVERAGE DEPENDING ON CHANGES, FINAL PARTITION HEIGHT/PLACEMENT, FURNITURE PLACEMENT, EQUIPMENT HEIGHT/PLACEMENT AND SHELVING HEIGHT/PLACEMENT.
- 3. SENSOR MASKING KITS MAY BE REQUIRED TO LIMIT COVERAGE DEPENDING ON THE PROJECT REQUIREMENTS.


LIGH	ITING FIXTUI	RE S	CHEDUL	E							
FIXT.	SYMBOL		LAMP(S)		VOLTS	MOUNT	TING	LOCATION	MANUFACTURER	CATALOG NUMBER	REMARKS
TAG		QTY.	TYPE	TOTAL WATTS		TYPE	HEIGHT				
F1			LED	56	120	RECESSED	CEILING	THROUGHOUT	LIGHTOLIER		
F2			LED	28	120	RECESSED	CEILING	THROUGHOUT	LIGHTOLIER		
F3	NOT USED										

EX	IT AI	VD EN	MERGENC	CY LIGHT	ΓING	FIXTUR	E SC	HEDULE		
FIXT.	SYMBOL		LAMP(S)		VOLTS	MOUNT	ING	MANUFACTURER	R CATALOG NO	REMARKS
TAG		QTY.	TYPE	TOTAL WATTS		TYPE	HEIGHT			
EM		2	24W SEALED-BEAM		120	SURFACE WALL	8'-6"	SURE-LITES	HR12170C	EMERGENCY WALL PACK LIGHT FIXTURE WITH METALLIC ENCLOSURE; SEALED LEAD—CADMIUM 120 MINUTE BATTERY AND INTEGRAL TEST SWITCH
EX	*		LED SEALED-BEAM		120	SURFACE WALL	8'-6"	SURE-LITES		EMERGENCY EXIT SIGNS WITH INTEGRAL BATTERY PACK AS APPROVED BY LOCAL CODE AUTHORITIES

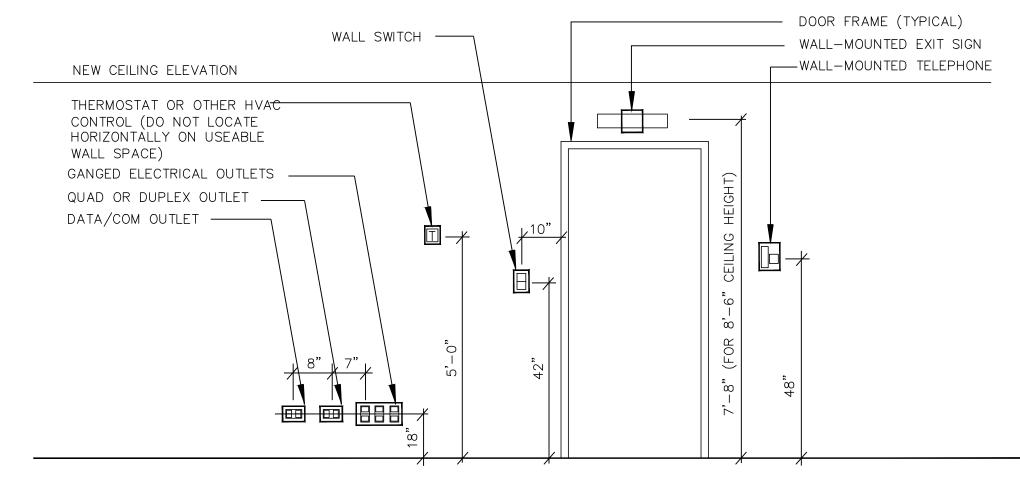

STANDARD ELECTRICAL MOUNTING HEIGHTS


2ND FLOOR

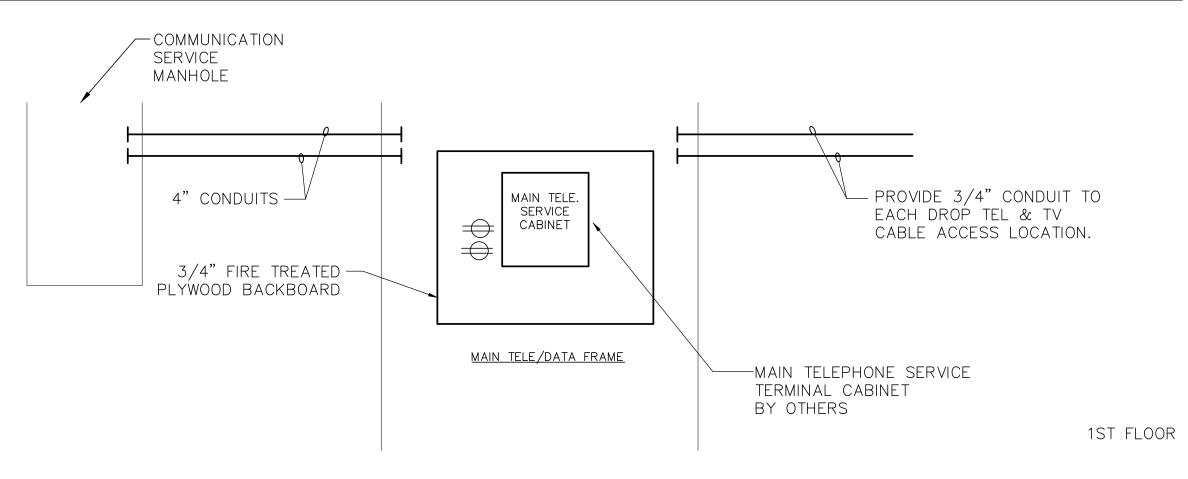

TELEPHONE / LOW VOLTAGE SYSTEM ONE-LINE RISER DIAGRAM NOT TO SCALE

LIGHTING FIXTURE SCHEDULE NOTES:

- 1. ELECTRICAL CONTRACTOR SHALL SUBMIT CATALOG CUTS TO ARCHITECT/ENGINEER FOR REVIEW AND APPROVAL PRIOR TO ORDERING LIGHTING FIXTURES.
- 2. ALL BALLASTS SHALL BE PROGRAMMABLE RAPID START, ELECTRONIC ENERGY SAVING TYPE.
- ALL EXIT SIGNS AND EMERGENCY LIGHT FIXTURES SHALL BE IN STRICT ACCORDANCE WITH LOCAL CODE AUTHORITY. ALL EXIT SIGNS SHALL BE INSTALLED IN A VISIBLE LOCATION, WITHOUT ANY OBSTRUCTIONS IN ORDER TO FACILITATE VIEWING. ELECTRICAL CONTRACTOR SHALL FURNISH AND INSTALL CONDUIT STEMS WHERE NECESSARY TO DROP A SIGN BELOW AN OBSTRUCTION.
- 4. NOT USED
- 5. NOT USED
- 6. ELECTRICAL CONTRACTOR SHALL PROVIDE SUBMITTAL ON FULL LIGHTING FIXTURE PURCHASE FOR ARCHITECT'S APPROVAL PRIOR TO ORDER.
- 7. FIXTURES SHALL HAVE APPROPRIATE UL LABEL, DAMP, OR WET AS REQUIRED BY LOCAL CODES.
- 8. PROVIDE LAMPS FROM: OSRAM SYLVANIA, GE OR PHILIPS UNLESS OTHERWISE NOTED.
- 9. CONTRACTOR SHALL VERIFY FINAL VOLTAGES AND CEILING TRIM COMPATIBILITY PRIOR TO ORDERING FIXTURES.
- 10. CEILING THICKNESS IN EXCESS OF 3/4" SHALL BE IDENTIFIED IN WRITING BY CONTRACTOR/ARCHITECT.
- 11. FIXTURES LOCATED IN AN INSULATED CEILING AREA, SHALL HAVE AN IC HOUSING (ELECTRICAL CONTRACTOR TO COORDINATE).
- 12. FIXTURES SHALL BE ORDERED WITH THE APPROPRIATE BALLASTS THAT HAVE UL AND CBM LABELS. BALLASTS SHALL CONFORM TO LOCAL CODE REQUIREMENTS FOR PERFORMANCE, SWITCHING, AND WIRING (I.E. TANDEM).
- 13. PROVIDE APPROVED FIRE—RATED ENCLOSURES FOR LIGHTING FIXTURES LOCATED IN A FIRE—RATED CEILING.
- 14. WALLS DIRECTLY ILLUMINATED SHALL BE INSTALLED AND FINISHED IN A MANNER TO ELIMINATE SHADOWS OR BLEMISHES (I.E. HANG DRY WALL VERTICALLY).
- THE ARCHITECT AND LIGHTING DESIGNER SHALL APPROVE FIXTURE SUBSTITUTIONS PRIOR TO BID. CONTRACTOR SHALL SUPPLY A SAMPLE AND/OR PHOTOMETRIC DATA IF REQUESTED. IF SUBSTITUTION IS REJECTED, CONTRACTOR SHALL PROVIDE SPECIFIED PRODUCT.
- 16. FIXTURES SHALL INCLUDE ACCESSORIES FOR INSTALLATION ACCORDING TO LOCAL AND NATIONAL CODES.
- 17. PRIOR TO ORDERING LIGHTING EQUIPMENT, THE CONTRACTOR SHALL VERIFY LOCATIONS AND RECESS DEPTHS.
- B. LAMPS SHALL BE PROVIDED AND INSTALLED ACCORDING TO THE ATTACHED FIXTURE SCHEDULE.
- 19. VERIFY EXACT LOCATION AND MOUNTING HEIGHTS OF ALL LIGHTING FIXTURES WITH ARCHITECT PRIOR TO ROUGH-IN.

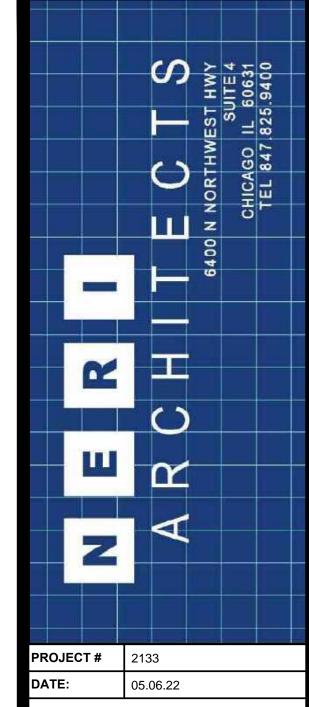

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O5.06.22 ISSUED FOR PERMIT

11.11.21 PROGRESS SET

REVISIONS

DRAWN BY: SM/GV

NOTES & DETAILS
sheet no.


APPROVED BY: SM/GV

SCALE:

E-6

AS NOTED


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CONCRETE ENCASED ELECTRODE DETAIL

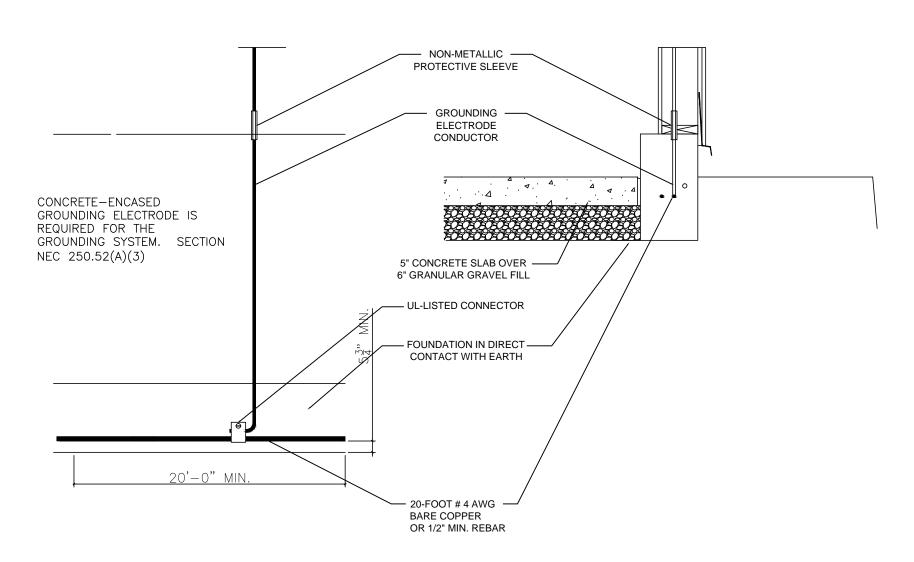
COMPRESSION LUG. REFER TO NOTES.


NOTE TO SCALE



GROUND BAR DETAIL NOTES:

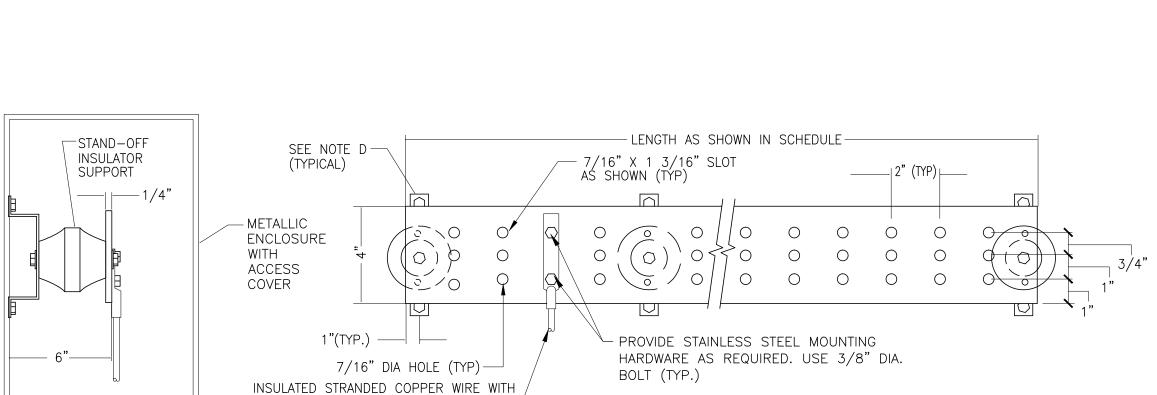- A. GROUND BAR SHALL BE MOUNTED WITHIN A METALLIC ENCLOSURE WITH HINGED COVER.
- B. CLEAN AND BURNISH GROUND BAR AND UTILIZE LIGHT COATING OF ANTI-OXIDATION GREASE PRIOR TO ATTACHING ANY HARDWARE.
- C. ATTACH LUGS TO BAR WITH 3/8" DIAMETER STAINLESS STEEL OR CADMIUM-PLATED BOLTS, NUTS AND WASHERS. NICKEL PLATED HARDWARE SHALL NOT BE ACCEPTABLE. UTILIZE TWO FLAT AND ONE LOCK WASHER FOR EACH BOLTED CONNECTION.
- D. 5/16" DIA. X 3 1/2" HEX HEAD CS WITH 3/8" DIA. PIPE SPACER 2" LONG AND 5/16" DIA. HS DROP IN ANCHOR.
- E. PROVIDE BUS BARS OVER 20" IN LENGTH WITH ADDITIONAL STAND OFF
- INSULATOR SUPPORTS, AT LEAST TWO OR AS SPECIFIED IN THE GROUND BAR SCHEDULE.

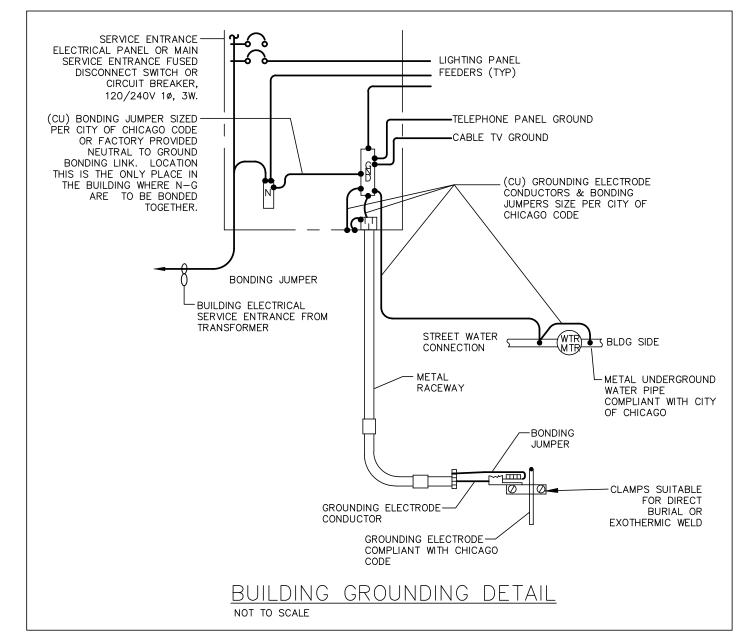

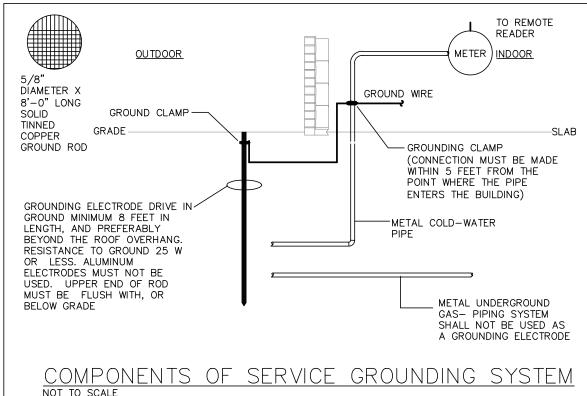

GENERAL GROUNDING NOTES


- TWO-HOLE LONG BARREL (DOUBLE INDENT) BOLTED-TYPE HYDRAULIC COPPER COMPRESSION CONNECTORS SHALL BE USED FOR CONDUCTORS LARGER THAN #8 AWG. ALL COMPRESSION CONNECTORS FOR CABLE SIZES #1/0 AWG AND LARGER SHALL EMPLOY HEX OR CIRAIMFERENTIAL TYPE CRIMPS, AND SHALL HAVE AN INSPECTION HOLE BETWEEN THE TONGUE AND BARREL. THE CABLE SHALL BE COMPLETELY INSERTED INTO THE CONNECTOR BEFORE THE CRIMPS ARE MADE. CONNECTORS SHALL BE AS MANUFACTURED BY BURNDY, TYPE YA "HYLUG", AND ONLY ON STRANDED WIRE. ALL SOLID WIRE GROUND CONNECTIONS MUST BE EXOTHERMIC ALLY WELDED OR, IF RUN IN THE INTERIOR, SOLDERED.
- 2. USE HYDRAULIC COPPER COMPRESSION H-TAP CONNECTORS AS MANUFACTURED BY BURNDY, TYPE YH "H COPPER CRIMPIT". PROVIDE FLAME RETARDANT INSULATING COVERS. PROVIDE THOMAS AND BETTS HARD COVER TYPE "HTC".
- 3. ALL COMPRESSION AND MECHANICAL CONNECTIONS SHALL BE COATED WITH THE CORROSION PREVENTATIVE COMPOUND NO-OX-ID "A", AS MANUFACTURED BY DEARBORN CHEMICAL COMPANY.
- 4. ALL GROUND CONDUCTORS SHALL BE COPPER WITH GREEN (COLOR) INSULATION. GREEN-INSULATED GROUND WIRE FOR ALL SIZES IS AVAILABLE THROUGH QUAD CABLCON (TROY, MI (800) 969-9220) OR RELTEC SERVICES (800-927-2780). GROUND CONDUCTORS LARGER THAN #1 SWG SHALL BE TYPE RHH/RHW (BRAIDED-CLOTH JACKET, SYNTHETIC RUBBER INSULATION).
- 5. ALL GROUNDING CONDUCTORS SHALL BE IN METALLIC CONDUIT, UNLESS OTHERWISE NOTED. GROUND CONDUCTORS SHALL NOT BE RUN CONCEALED IN SLABS, COLUMNS, OR WALLS. USE RIGID GALVANIZED STEEL CONDUIT SLEEVES WHERE GROUND CONDUCTORS PENETRATE WALLS OR FLOOR
- METALLIC STRAPS SHALL BE USED TO SEAIRE GROUND CONDUCTOR CONDUITS EVERY 18" HORIZONTALLY AND EVERY 9" VERTICALLY TO THE BUILDING COLUMNS OR WALLS. IF METALLIC STRAPS ARE USED, THEY SHALL BE OF THE TYPE WHICH DO NOT COMPLETELY ENCIRCLE THE CONDUCTOR. PLASTIC "CLIC" CONNECTORS BY LITCHFIELD INTERNATIONAL COMPANY (800-345-CLIC) ARE ACCEPTABLE FOR USE AS CONDUIT AND CONDUCTOR SUPPORTS. DO NOT USE CONDUIT, CABLE TRAY, MECHANICAL DUCT, OR PLASTIC TIE WRAPS TO SEAIRE GROUND CONDUCTORS.
- 7. THE MINIMUM BEND RADII ON GROUND CONDUCTORS SHALL BE AS FOLLOWS:

#12 – #6 #250- #750 KCMIL 24


- 8. PACK OPENINGS AROUND GROUND CONDUCTOR PENETRATIONS OF FLOOR SLABS OR WALLS WITH FIRE RETARDANT MATERIAL. APPROVED FIRE RETARDANT MATERIAL SHALL BE HILTI FIRE BARRIER CAULK (NO SUBSTITUTIONS).
- 9. TAG ALL GROUND CONDUCTOR TERMINATIONS AT GROUND BAR WITH GRAY OVAL FIBER "FAR—END DESTINATION" 145P TAGS AS MANUFACTURED BY ONE OF THE FOLLOWING:
- A. ANIXTER (BLOOMINGTON, ILLINOIS) TEL. # 309/662-5162 OR 800/ANIXTER PART #847755246
- B. MARCONI (OHIO) TEL. # 800/927-2780 PART #847755246

GROUND SERVICES MAY BE STAMPED, ENGRAVED, OR LEGIBLY/NEATLY HANDWRITTEN ON FIBER TAG. AT GROUND BAR TERMINATIONS ALSO PROVIDE ENGRAVED BRASS "DO NOT DISCONNECT" TAGS MANUFACTURED BY:

- C. ANIXTER (MANUFACTURED BY FLEXTRONICS AND SOLD BY ANIXTER) PART # P0411719
- D. GUS BERTHOLD ELECTRIC COMPANY (CHICAGO ILLINOIS) TEL. # 312/243- 5767 (BLANK TAGS PURCHASED BY GBE CO. AND STAMPED)
- 10. ALL TAGS AT GROUND BAR TERMINATIONS SHALL BE SEAIRED WITH 9-PLY OR 12-PLY TWINE/CORD MANUFACTURED BY ANIXTER. TIE WRAPS SHALL NOT BE USED. 9-PLY PART # 095017, 12-PLY PART # 224758.
- 11. THE MAIN BUILDING GROUND BAR (MGB) SHALL BE THE EXTENSION OF THE BUILDING GROUNDING SYSTEM AND SHALL SERVE AS THE MAIN POINT OF BONDING WITHIN THE FACILITY AND SHALL COMPLY WITH CHICAGO BUILDING CODE. THE MGB SHALL BE THE COMMON GROUND POINT TO WHICH ALL GROUND POINTS FOR THE FACILITY ARE BONDED.
- 12. THE ROUTE OF THE BONDING CONDUCTORS FROM THE MGB TO THE FACILITY GROUND RING SHALL BE AS SHORT AND STRAIGHT AS PRACTICALLY
- 13. THE MGB WILL SHALL BE CONFIGURED TO MAINTAIN SEPARATION BETWEEN SURGE PRODUCERS, ABSORBERS, NON-ISOLATED AND ISOLATED GROUNDS. THE MGB SHALL BE PERMANENTLY AND APPROPRIATELY LABELED AND IDENTIFY WITH "P", "A", "N", AND "I" SECTIONS OF THE MGB.
- 14. BONDING CONDUCTORS BETWEEN THE MGB AND OTHER ANCILLARY GROUND BARS OR EQUIPMENT BAYS SHALL RUN IN THE STRAIGHTEST ROUTE MINIMIZING THE TOTAL LENGTH OF THE CONDUCTOR.
- 15. ALL GROUNDING SYSTEM CABLE RUNS THAT ARE ROUTED THROUGH WALLS, CEILINGS OR FLOORS SHALL BE PROTECTED BY METALLIC CONDUITS OR SLEEVES.
- 16. CONNECTIONS TO THE BURIED DELTA GROUND RING SHALL BE EXOTHERMIC ALLY WELDED BY TECHNICIANS CERTIFIED ON THE PROCESS. CONNECTIONS OTHER THAN EXOTHERMIC WELD SHALL BE LOCATED SO AS TO FACILITATE PERIODIC INSPECTION AND MAINTENANCE.
- 17. ALL BURIED CONNECTIONS SHALL BE EXOTHERMIC WELDS. ALL EXPOSED MECHANICAL AND/OR HIGH COMPRESSION CONNECTIONS SHALL BE TREATED WITH A PROTECTIVE, ANTI-OXIDANT COATING. ALL EXOTHERMIC WELDS TO GALVANIZING SURFACES SHALL BE SPRAYED WITH GALVANIZING PAINT.

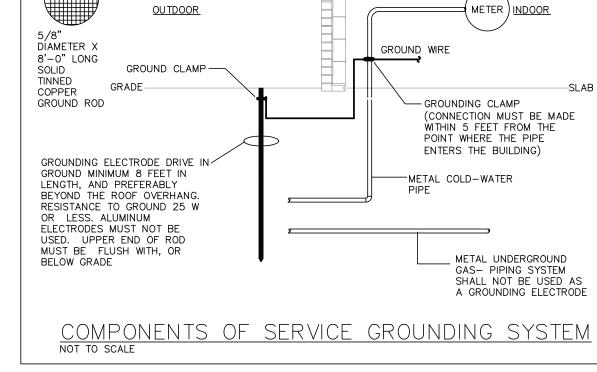

MAIN GROUND BAR DETAIL

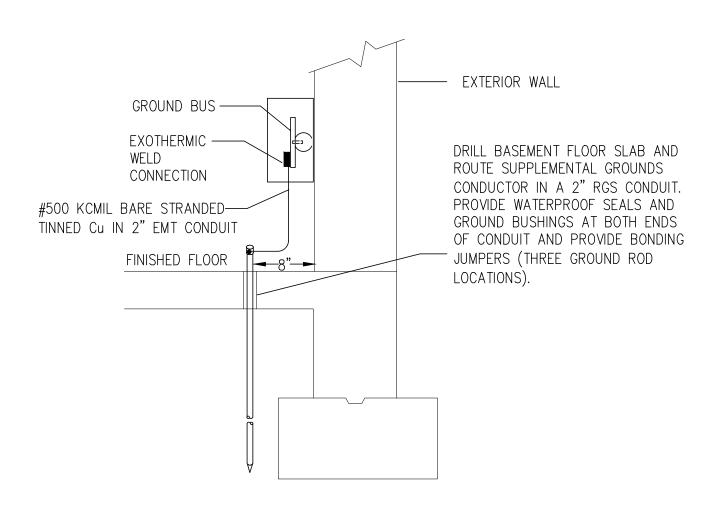

GROUND BUS CONNECTION TO BURIED GROUND ROD DETAIL

24"

MANUFACTURER: NEWTON INSTRUMENTS COMPANY,

INC. TEL: 919-575-6426 (PART NO. A-10389)

A-6065 | WALL MTG. BRKT.

3015-1 | 5/8-11 X 1 HHCS 3015-8 | LOCKWASHERS-5/8"

FOR EACH GROUND BAR ASSEMBLY.

GROUND BAR SCHEDULE

TAG | LENGTH | THICKNESS | MOUNTING

(INCHES) (INCHES) HEIGHT (IN)

1/4" | 18" A.F.F.


PROVIDE PART QUANTITIES AS REQUIRED

3061-4 INSULATORS

DESCRIPTION

PART NO.


1. CO-ORDINATE WITH STRUCTURAL ENGINEER FOR ALL DIMENSIONS SHOWN,

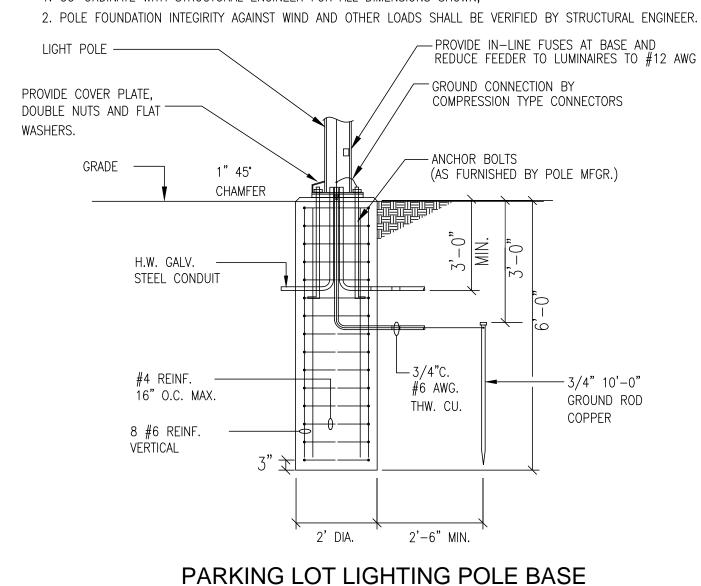

		BUCK-BOOST TRA	NSFORMER SO	CHEDULE		Tr.	7
EQUIPMENT TAG	TRANSFORMER TAG	EQUIPMENT DESCRIPTION	PRIMARY VOLTAGE	SECONDARY VOLTAGE	TRANSFORMER CATALOG NUMBER	SECONDARY WIRE	RECEPTACLE / DISCONNECT SWITCH
A	T-A	WELDER	208 V 1 PH	230 V 1 PH	Q1C0ERCB	2#8&1#8G-3/4"C	60 AMP RECPT
В	T-D	4 POST LIFT	208 V 1 PH	230 V 1 PH	QC75ERCB	2 # 10 & 1 # 10 G- 3/4" C	HARD WIRED 30 AMP 2 POLE
В	T-C	2 POST LIFT	208 V 1 PH	230 V 1 PH	QC75ERCB	2 # 10 & 1 # 10 G- 3/4" C	HARD WIRED 30 AMP 2 POLE
С	T-E	AIR COMPRESSOR	208 V 3 PH	230 V 3 PH	Q1C5ERCF (2)	3#6&1#8G-3/4"C	HARD WIRED 60 AMP 3 POLE
D	т-в	CUTTER	208 V 1 PH	230 V 1 PH	Q1C5ERCF	2#6&1#8G-3/4"C	60 AMP RECPT

TRANSFORMER CATALOG NUMBERS ARE FROM HAMMOND POWER SOLUTIONS

WIRE BUCK BOOST TRANSFORMERS PER MANUFACTURER'S RECOMMENDATIONS.

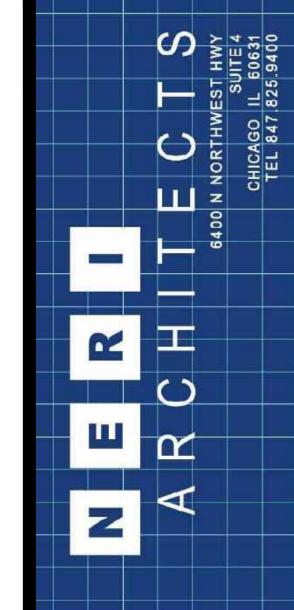

PROJECT # 05.06.22




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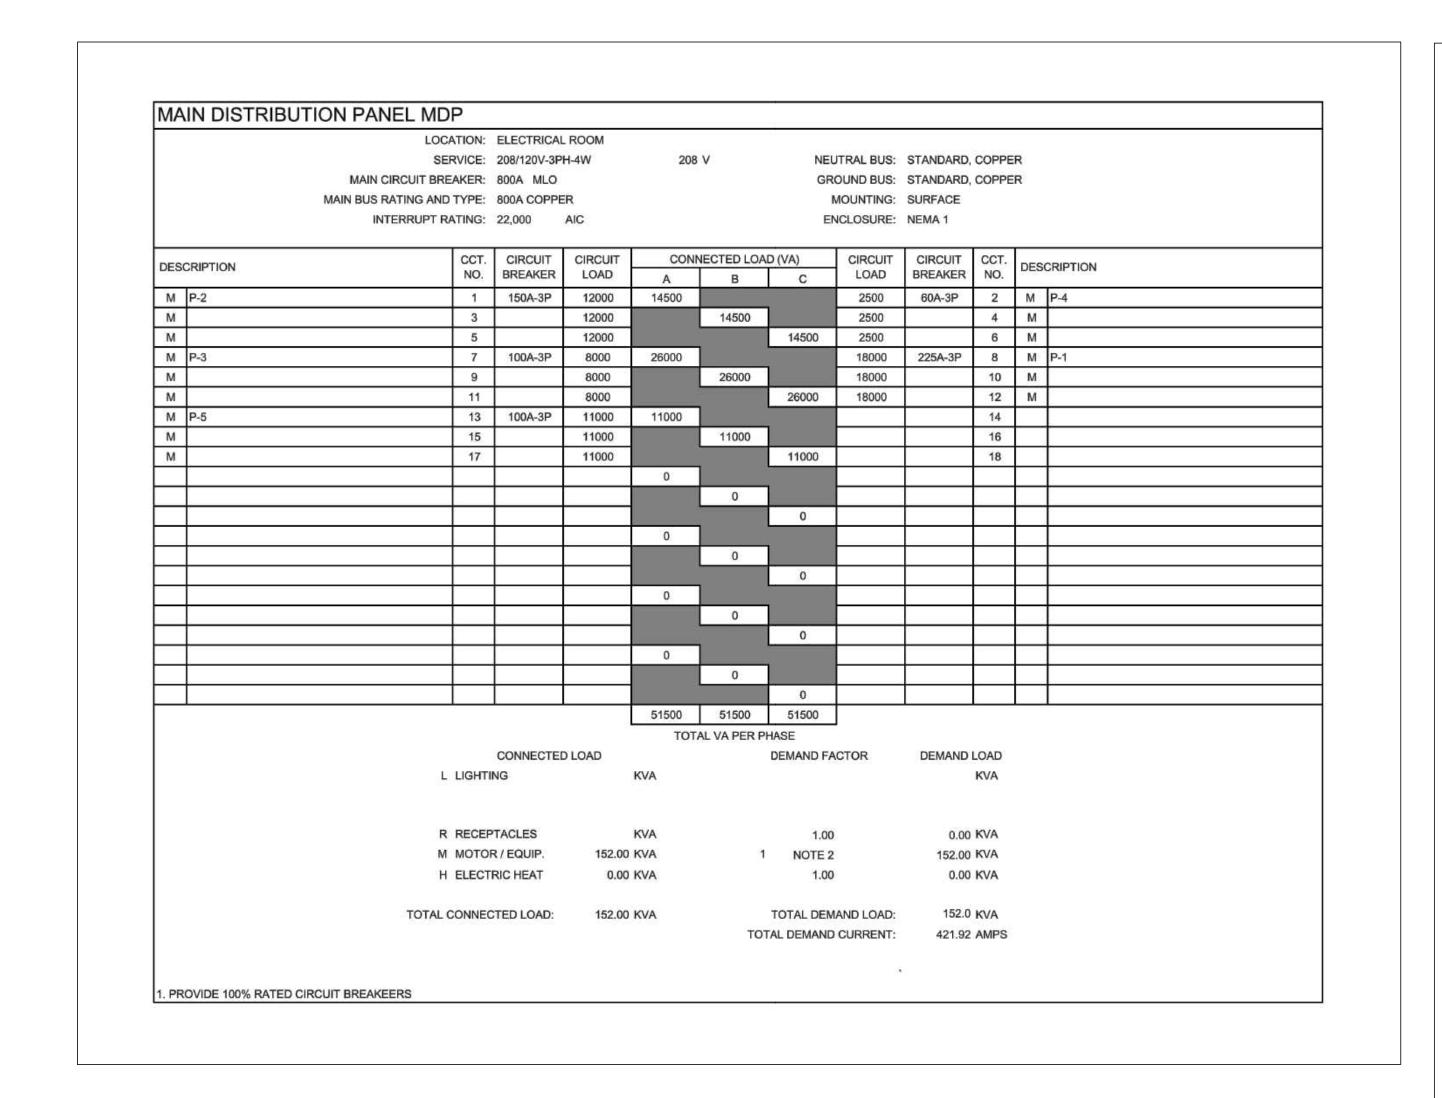
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	05.06.22	ISSUED FOR PERMIT
	11.11.21	PROGRESS SET
7		REVISIONS
R	AWN BY:	SM/GV
PI	PROVED BY	: SM/GV
C	ALE:	AS NOTED
ES	SCRIPTION:	ELEC SCHEDULES,


NOTES & DETAILS SHEET NO.



SINGLE LINE RISER DIAGRAM - 400A @ 120/208V. 3 PHASE, 4 WIRE

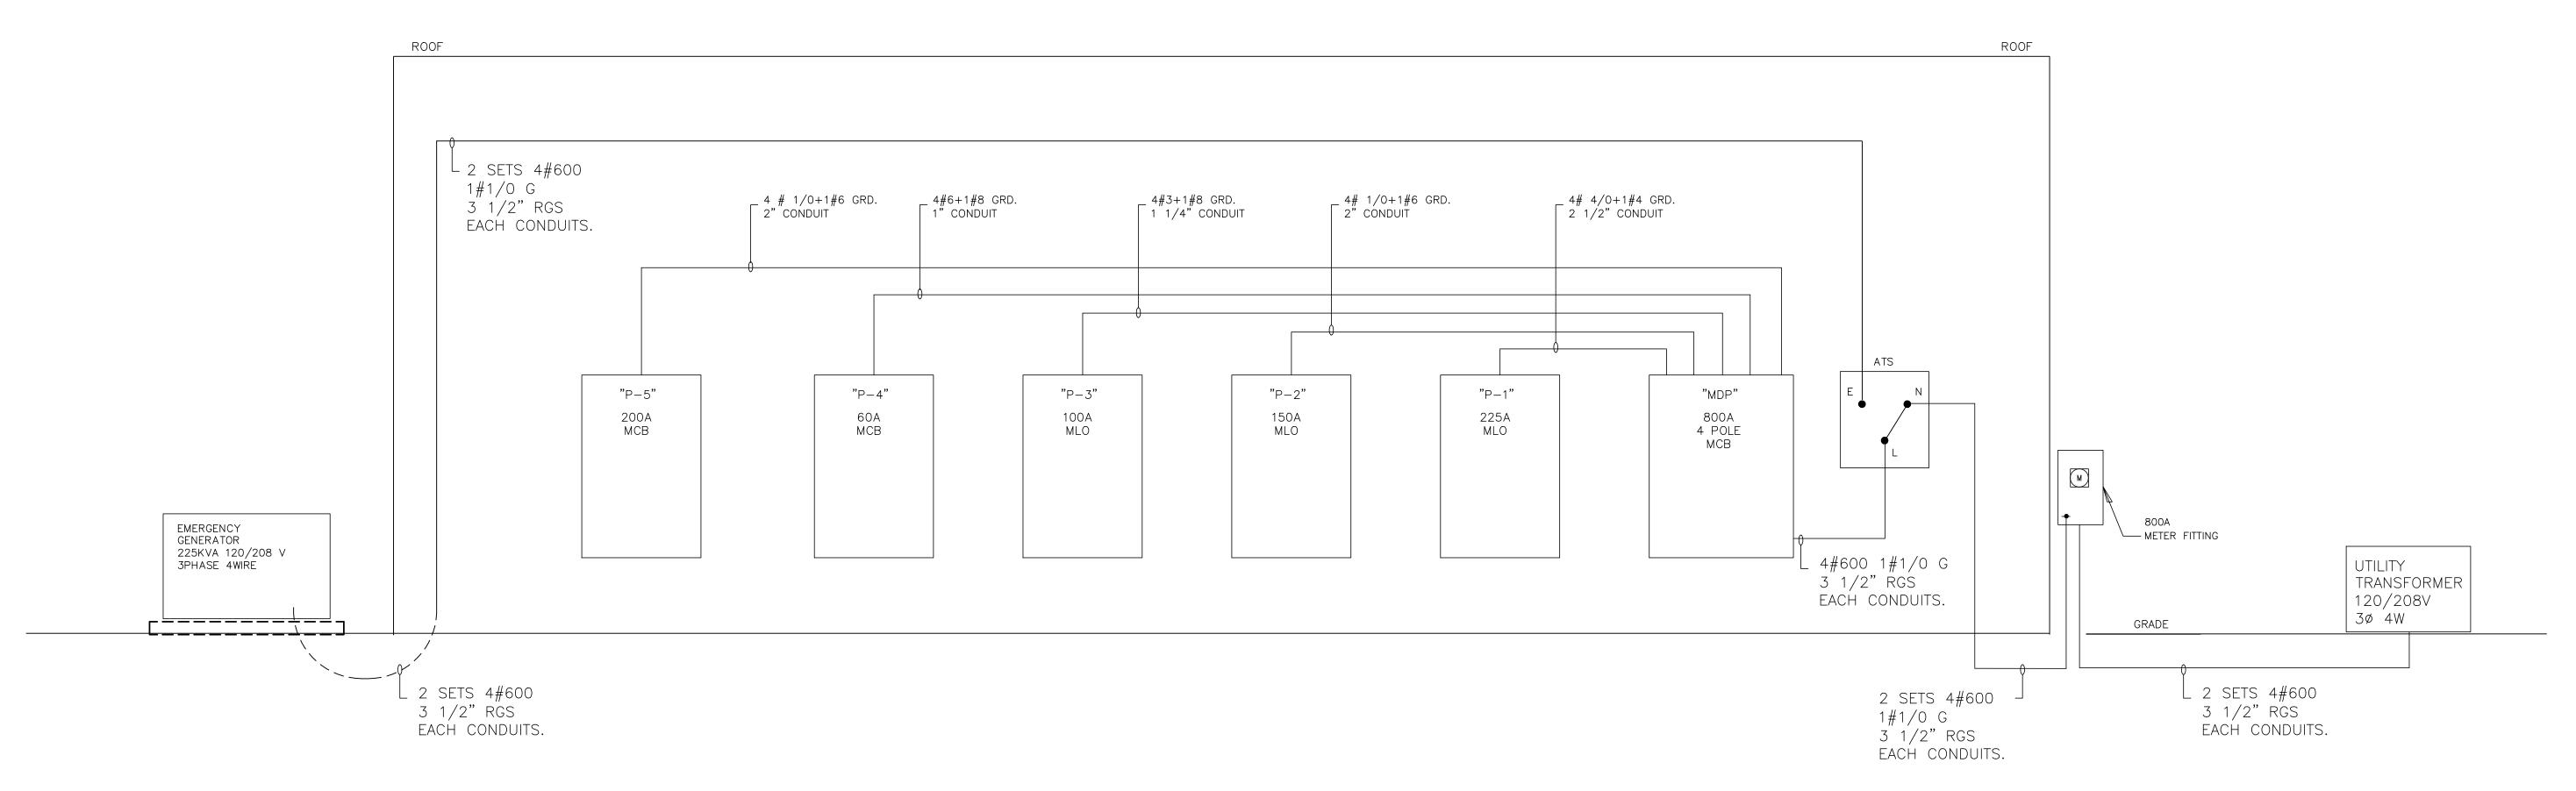

	1 1 1 1 1 1 1 1 1 1 1 1 1 1 1 1 1 1 1	LOCATION:	DARK ROOM	PREP ROOF	M		:					2/21/2022	
			120/208V-3P			208 V NEUTRAL BUS: S							
	MAIN CIRC	UIT BREAKER:							STANDARD,				
	MAIN BUS RATING AND TYPE:						MOUNTING: 5						
	INTER	RUPT RATING:	22,000	AIC			El	NCLOSURE:	NEMA 1				
nes	CRIPTION	CCT.	CIRCUIT	CIRCUIT	CONN	NECTED LOA	D (VA)	CIRCUIT	CIRCUIT	CCT.	DES	CRIPTION	
DES	CKIF HON	NO.	BREAKER	LOAD	Α	В	С	LOAD	BREAKER	NO.	DES	CAIFTION	
Р	"A" MILLER WELDER	2	40A-2P	3900	9420		-	5520	60A-2P	2	Р	"D" MILLER CUTTER	
Р	2#8+GRD. 3/4"C NOTE 1	4		3900		9420		5520		4	Р	2#6+GRD. 3/4"C NOTE 1	
Р	"A" MILLER WELDER	6	40A-2P	3900			9420	5520	60A-2P	6	Р	"D" MILLER CUTTER	
Р	2#8+GRD. 3/4"C NOTE 1	8		3900	9420		•	5520		8	Р	2#6+GRD. 3/4"C NOTE 1	
Р	"A" MILLER WELDER	10	40A-2P	3900	e/ 1	9420		5520	60A-2P	10	Р	"D" MILLER CUTTER	
Р	2#8+GRD. 3/4"C NOTE 1	12		3900			9420	5520		12	Р	2#6+GRD. 3/4"C NOTE 1	
Ρ	"A" MILLER WELDER	14	40A-2P	3900	9420			5520		14		SPARE	
Р	2#8+GRD. 3/4"C NOTE 1	16		3900	9	9420		5520		16		SPARE	
	SPARE	18	20A-1P	0			600	600	20A-3P	18	М	"MAU-1" MAKE UP AIR UNIT	
М	"RTU-1" ROOF TOP UNIT	20	50A-3P	4500	5100		•	600		20	М	3#12+GRD. 3/4"C	
М	3#8+GRD. 3/4"C	22		4500	6 6	5100		600	2	22	М	SEE SCHEDULE. SEE NOTE 2	
М	SEE SCHEDULE	24		4500		ì	5100	600	20A-3P	24	М	"MAU-1" MAKE UP AIR UNIT	
М	"C" AIR COMPRESSOR	26	60A-3P	1800	1800			600		26	М	3#12+GRD. 3/4"C	
М	3#6+GRD. 3/4"C NOTE 1	28		1800		2400		600		28	М	SEE SCHEDULE. SEE NOTE 2	
М		30		1800			2400	600	20A-3P	30	М	"MAU-1" MAKE UP AIR UNIT	
	SPARE	32	20A-1P		600		•	600		32	М	3#12+GRD. 3/4"C	
	SPARE	34	20A-1P		1/ 5:	600		600		34	М	SEE SCHEDULE. SEE NOTE 2	
	SPARE	36	20A-1P				2000	2000	30A-2P	36	М	"B" LIFT	
	SPARE	38	20A-1P		2000		•	2000		38	М	2#10+GRD. 3/4"C NOTE 1	
	SPARE	40	20A-1P			2000		2000	30A-2P	40	М	"B" LIFT	
	SPARE	42	20A-1P				2000	2000		42	М	2#10+GRD. 3/4"C NOTE 1	
					37760	38360	30940						
					TOTA	AL VA PER PI							
		P016 - #444-04-P0005	CONNECTED				DEMAND FA		DEMAND I				
		L LIGHTI			KVA		1.00		0.00				
			BLE EQUIPM				0.25		16.08				
			R / EQUIP.	32.30			1.00		32.30				
		H ELECT	RIC HEAT	0.00	KVA		0.00		0.00	KVA			
		TOTAL CONNEC	CTED LOAD:	96.62	KVA		TOTAL DEM	AND LOAD:	48.4	KVA			
						TOT	TAL DEMAND	CURRENT:	134.29	AMPS			
1. SE	E BUCK-BOOST SCHEDULE. COORDINA	TE DETAILS WIT	TH USER.										

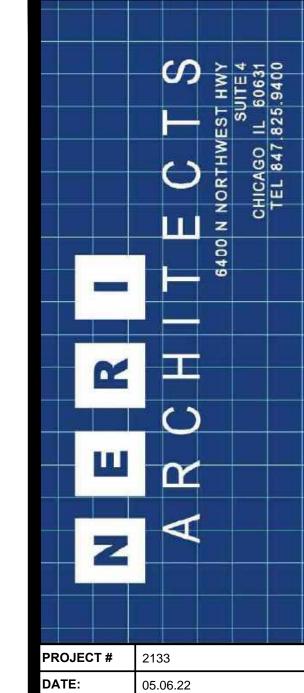



BUILDING

SCALE:

SHEET NO.

PUBLIC WORKS E	LOWELL, IN LAKE COUNTY	FOR REFERENCE
05.06.22	ISSUED FOR PERM	IIT
11.11.21	PROGRESS SET	
	REVISIONS	
DRAWN BY:	SM/GV	
APPROVED BY	: SM/GV	


AS NOTED DESCRIPTION: ELEC SCHEDULES,


NOTES & DETAILS

	i	OCATION:	DARK ROOM	PREP ROOM	1							2/21/2022
		SERVICE:	120/208V-3P	H-4W	208	٧	NEU	TRAL BUS:	STANDARD,	COPPE	R	
	MAIN CIRCUIT	BREAKER:	150A MLO				GR	OUND BUS:	STANDARD,	COPPE	R	
	MAIN BUS RATING	AND TYPE:	150A COPPE	R			9	MOUNTING:	SURFACE			
	INTERRUF	T RATING:	22,000	AIC			Ef	NCLOSURE:	NEMA 1			
DES	CRIPTION	CCT.	CIRCUIT	CIRCUIT	CON	NECTED LOA	D (VA)	CIRCUIT	CIRCUIT	CCT.	DES	CRIPTION
		NO.	BREAKER	LOAD	Α	В	С	LOAD	BREAKER	NO.	000	
М	(9) "TEF-1" "EF-1" "TEF-2" NOTE 1	2	20A-1P	500	1700			1200	20A-1P	2	R	RECEPTACLES
М	"GEF-2" "GEF-4"	4	20A-1P	150		1350		1200	20A-1P	4	R	RECEPTACLES
М	"GEF-1"	6	20A-1P	500			1700	1200	20A-1P	6	R	RECEPTACLES
M	"GEF-3"	8	20A-1P	700	1900			1200	20A-1P	8	R	RECEPTACLES
	SPARE	10	20A-1P			1200		1200	20A-1P	10	R	RECEPTACLES
L	LIGHTING	12	20A-1P	1200	y		2400	1200	20A-1P	12	R	RECEPTACLES
L	LIGHTING	14	20A-1P	1200	2400		•	1200	20A-1P	14	R	RECEPTACLES
L	LIGHTING	16	20A-1P	1200		1200			20A-1P	16		SPARE
L	LIGHTING	18	20A-1P	1200			2400	1200	20A-1P	18	R	RECEPTACLES
L	LIGHTING	20	20A-1P	1200	2400		_	1200	20A-1P	20	R	RECEPTACLES
L	LIGHTING	22	20A-1P	1200		2400		1200	20A-1P	22	R	RECEPTACLES
L	LIGHTING	24	20A-1P	1200		41/	2400	1200	20A-1P	24	R	RECEPTACLES
L	LIGHTING	26	20A-1P	1200	2400			1200	20A-1P	26	R	RECEPTACLES
L	LIGHTING	28	20A-1P	1200		1400		200	20A-1P	28	R	RECEPTACLES
L	LIGHTING	30	20A-1P	1200	2		1400	200	20A-1P	30	R	RECEPTACLES
L	LIGHTING	32	20A-1P	1200	1250			50	20A-1P	32	R	FIRE ALARM
L	LIGHTING	34	20A-1P	200		200		18	20A-1P	34	11	SPARE
L	LIGHTING	36	20A-1P	200	3	• • • • • • • • • • • • • • • • • • • •	200			36		
L	EXTERIOR LIGHTING	38	20A-1P	1200	1200					38	50	
L	EXTERIOR LIGHTING	40	20A-1P	1200		1200				40		
L	EXTERIOR LIGHTING	42	20A-1P	1200			1200	.:)		42	es:	
					13250	8950	11700					- III
				2	TOTA	AL VA PER P	HASE					
			CONNECTE	D LOAD			DEMAND FA	CTOR	DEMAND	LOAD		
		L LIGHTI	NG	17.20	KVA		1.00		17.20	KVA		
		R RECEP	PTACLES	14.85	KVA		1.00		14.85	KVA		
		м мото	R / EQUIP.	1.85	KVA		1.00		1.85	KVA		
		H ELECT	RIC HEAT	0.00	KVA		0.00		0.00	KVA		
	тот	AL CONNEC	CTED LOAD:	33.90	KVA		TOTAL DEM	IAND LOAD:	33.9	KVA		
						TO	TAL DEMAND		94.10	AMPS		
. PR	OVIDE LOCAL OCCUPANCY SENSOR FOR E	ACH FAN.										
	e avitain seu meeste troopstatistee eesta Tolmas kiitasta alkaa 1992 Talkaata Talkaata 1997 (1997). Pelateka t Talkaata											

		LOCATION:	DARK ROOM	I PREP ROOI	М	· ·		<u> </u>				2/21/2022
		SERVICE:	120/208V-3F	H-4W	208	V	NEU	TRAL BUS:	STANDARD	COPPE	R	
	MAIN CIRCUI	T BREAKER:	100A MLO			GRO		OUND BUS:	STANDARD	COPPE	R	
	MAIN BUS RATING	AND TYPE:	100A COPPI	ER			1	MOUNTING:	SURFACE			
	INTERRU	IPT RATING:	22,000	AIC			EN	ICLOSURE:	NEMA 1			
DES	SCRIPTION	CCT.	CIRCUIT BREAKER	CIRCUIT LOAD	CON	NECTED LOA	D (VA)	CIRCUIT LOAD	CIRCUIT BREAKER	CCT. NO.	DES	CRIPTION
М	OVERHEAD DOOR	2	20A-2P	500	1500			1000	20A-2P	2	н	"ECH-1" CAB HTR 2KW
М	NOTE 1	4		500		1500	1	1000		4	н	2#12+GRD. 3/4"C
М	OVERHEAD DOOR	6	20A-2P	500	8		1500	1000	20A-2P	6	н	"ECH-1" CAB HTR 2KW
М	NOTE 1	8		500	1500	1		1000		8	Н	2#10+GRD. 3/4"C
М	OVERHEAD DOOR	10	20A-2P	500		1600]	1100	20A-3P	10	Н	"ECH-2" CAB HTR 3.3 KW
M	NOTE 1	12		500	N		1600	1100		12	Н	3#10+GRD. 3/4"C
М	OVERHEAD DOOR	14	20A-2P	500	1000]		1100		14	Н	
М	NOTE 1	16		500		1000]	500	20A-2P	16	М	OVERHEAD DOOR
М	OVERHEAD DOOR	18	20A-2P	500	19 S		1000	500		18	М	NOTE 1
М	NOTE 1	20		500	1000	1		500	20A-2P	20	М	OVERHEAD DOOR
М	OVERHEAD DOOR	22	20A-2P	500		1000		500		22	М	NOTE 1
М	NOTE 1	24		500			1000	500	20A-2P	24	М	OVERHEAD DOOR
М	OVERHEAD DOOR	26	20A-2P	500	1000			500		26	М	NOTE 1
М	NOTE 1	28		500	·	1000		500	20A-2P	28	М	OVERHEAD DOOR
	SPARE	30	20A-1P		7		500	500		30	M	NOTE 1
	SPARE	32	20A-1P		500			500	20A-2P	32	М	OVERHEAD DOOR
	SPARE	34	20A-1P			500		500		34	М	NOTE 1
	SPARE	36	20A-1P			-	500	500	20A-2P	36	М	OVERHEAD DOOR
	SPARE	38	20A-1P		500			500		38	М	NOTE 1
	SPARE	40	20A-1P			500		500	20A-2P	40	М	OVERHEAD DOOR
	SPARE	42	20A-1P				#REF!	500		42	М	NOTE 1
					7000	7100	#REF!	U				
					TOT	AL VA PER P	HASE					
			CONNECTE	D LOAD			DEMAND FA	CTOR	DEMAND	LOAD		
		L LIGHTI			KVA		1.00			KVA		
		R RECEP			KVA		1.00			KVA		
		м мотог		14.00			1.00		14.00			
		H ELECT	RIC HEAT	7.30	KVA		1.00		7.30	KVA		
	то	TAL CONNEC	TED LOAD:	21.30	KVA		TOTAL DEM			KVA		
4 - D.C.	DOVIDE CONTROL WIRING CONTROL CTAT	IONE AND D	CONNECT	PIMITOU FOR	EACH	TO	TAL DEMAND	CURRENT:	59.12	AMPS		
1. PH	ROVIDE CONTROL WIRING, CONTROL STAT	IONS, AND DI	OCUNNECT!	SWITCH FOR	EACH.							
<u> </u>												

DESCRIP	MAIN CIRCUI MAIN BUS RATING		120/208V-3P	11 4142								2/21/2022
				H-4W	208	V	NEU	JTRAL BUS:	STANDARD,	COPPE	R	
	MAIN BUS RATING	I BREAKER:	60A MCB				GR	OUND BUS:	STANDARD,	COPPE	R	
		AND TYPE:	60A COPPE	₹			9	MOUNTING:	SURFACE			
	INTERRU	IPT RATING:	10,000	AIC			EN	NCLOSURE:	NEMA 1			
v Taus	PTION	CCT.	CIRCUIT BREAKER	CIRCUIT	CONI	NECTED LOA	D (VA)	CIRCUIT	CIRCUIT BREAKER	CCT.	DESC	CRIPTION
M JAIR	R COMPRESSOR	2	20A-2P	600	1200			600	20A-1P	2	R	RECEPTACLES
М		4		600	1	900	1	300	20A-1P	4		LIGHITNG
-	ATTERY HEATER	6	20A-1P	600			700	100	20A-1P	6	_	CONTROL PANEL
_	ADIATOR HEATER	8	20A-2P	600	600	1	200000		20A-1P	8		SPARE
М		10		600		600	1		20A-1P	10	_	SPARE
_	TTERY CHARGER	12	20A-1P	200			200			12		SPACE
_	PACE	14			0	1				14		SPACE
M EN	ICLOSURE HEATER	16	20A-2P	1000		1000	1	5		16		SPACE
SP/	PACE	18		1000			1000			18		SPACE
		20			0					20		
		22				0				22		
		24		Ü			0			24		er u
		26		į.	0					26		2; 20
		28		Ď.		0]			28		
		30					0			30		70 Y
		32			0					32		
		34			A.	0				34		
		36			10	2	0			36		
		38			. 0	:	4			38	0	
		40				0		=		40	0	
		42			g;		0			42		
					1800	2500	1900					
					TOT	AL VA PER P	HASE					
			CONNECTE	DLOAD			DEMAND FA	CTOR	DEMAND	LOAD		
		L LIGHTI		0.30			1.00		0.30			
		R RECEP		0.60			1.00		0.60			
		м мотог		4.30			1.00		4.30			
		H ELECT	RIC HEAT	0.00	KVA		1.00		0.00	KVA		
	то	TAL CONNEC	CTED LOAD:	5.20	KVA		TOTAL DEM	IAND LOAD:	5.2	KVA		
DANE	LOCATED IN CENERATOR ENGLOSUS	-				то	TAL DEMAND	CURRENT:	14.43	AMPS		
PANEL	LOCATED IN GENERATOR ENCLOSUR	E.										

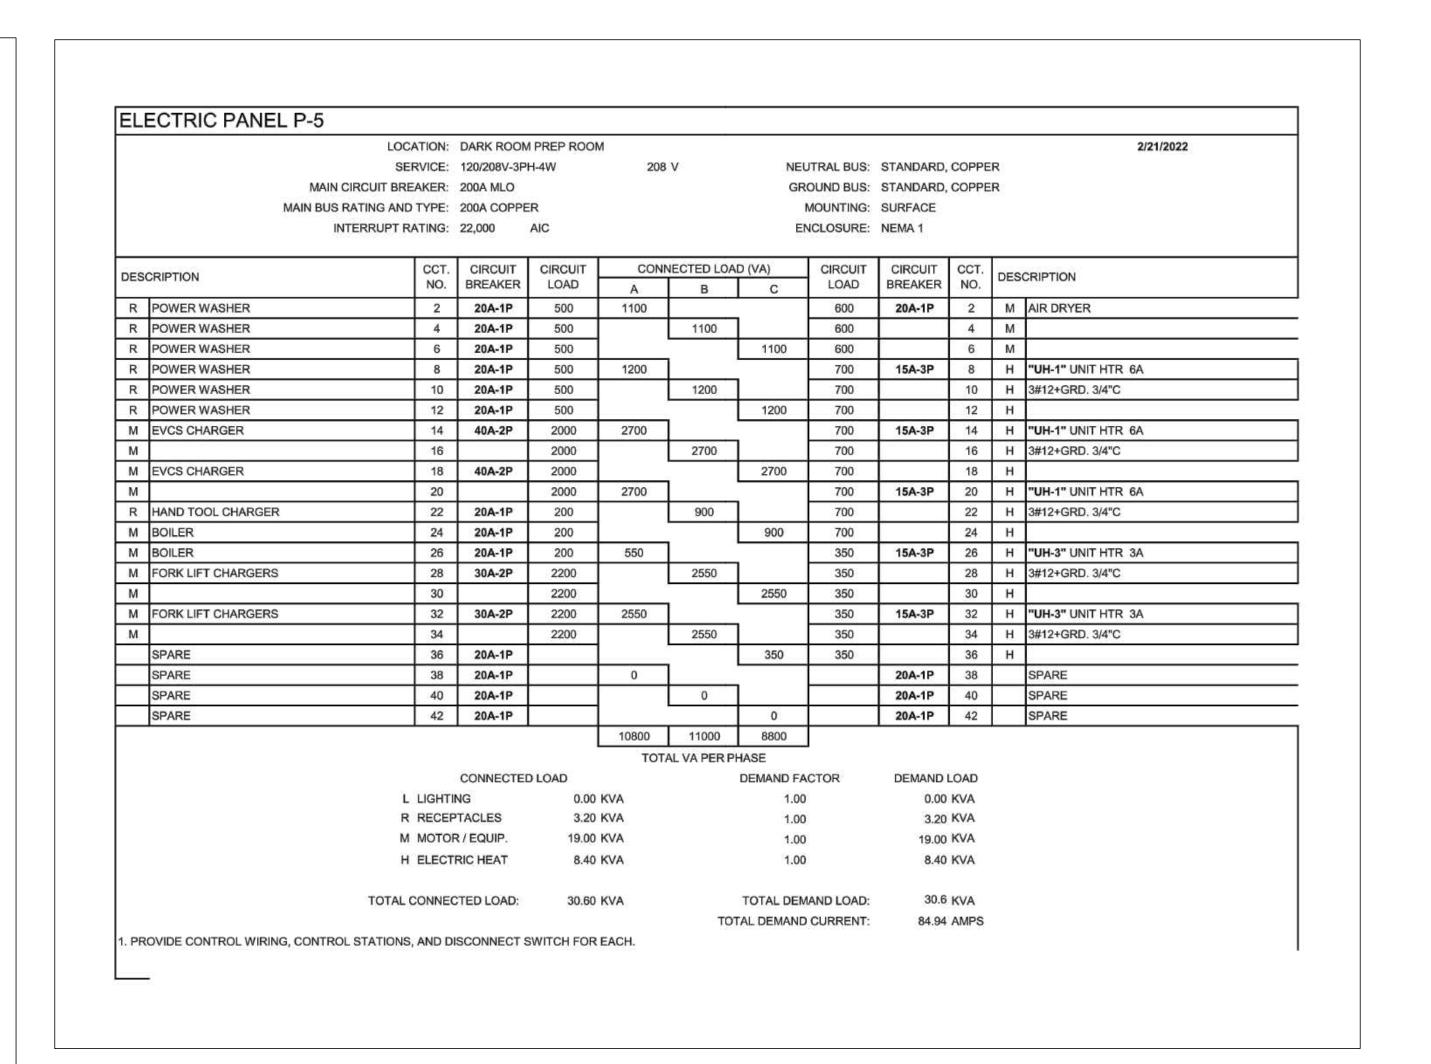

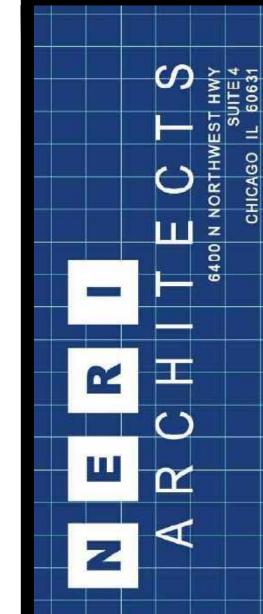

N. RASSONAL SERVICE OF THE PROPERTY OF THE PRO

IC WORKS BUILDING


LOWELL, IN LAKE COUNTY FOR REFERENCE


ONLY

	05.06.22	ISSUED FOR PERMIT
	11.11.21	PROGRESS SET
		REVISIONS
RAWN BY:		SM/GV
PI	PROVED BY	: SM/GV
C	ALE:	AS NOTED
FS	SCRIPTION:	ELEC SCHEDULES.


NOTES & DETAILS

SHEET NO.

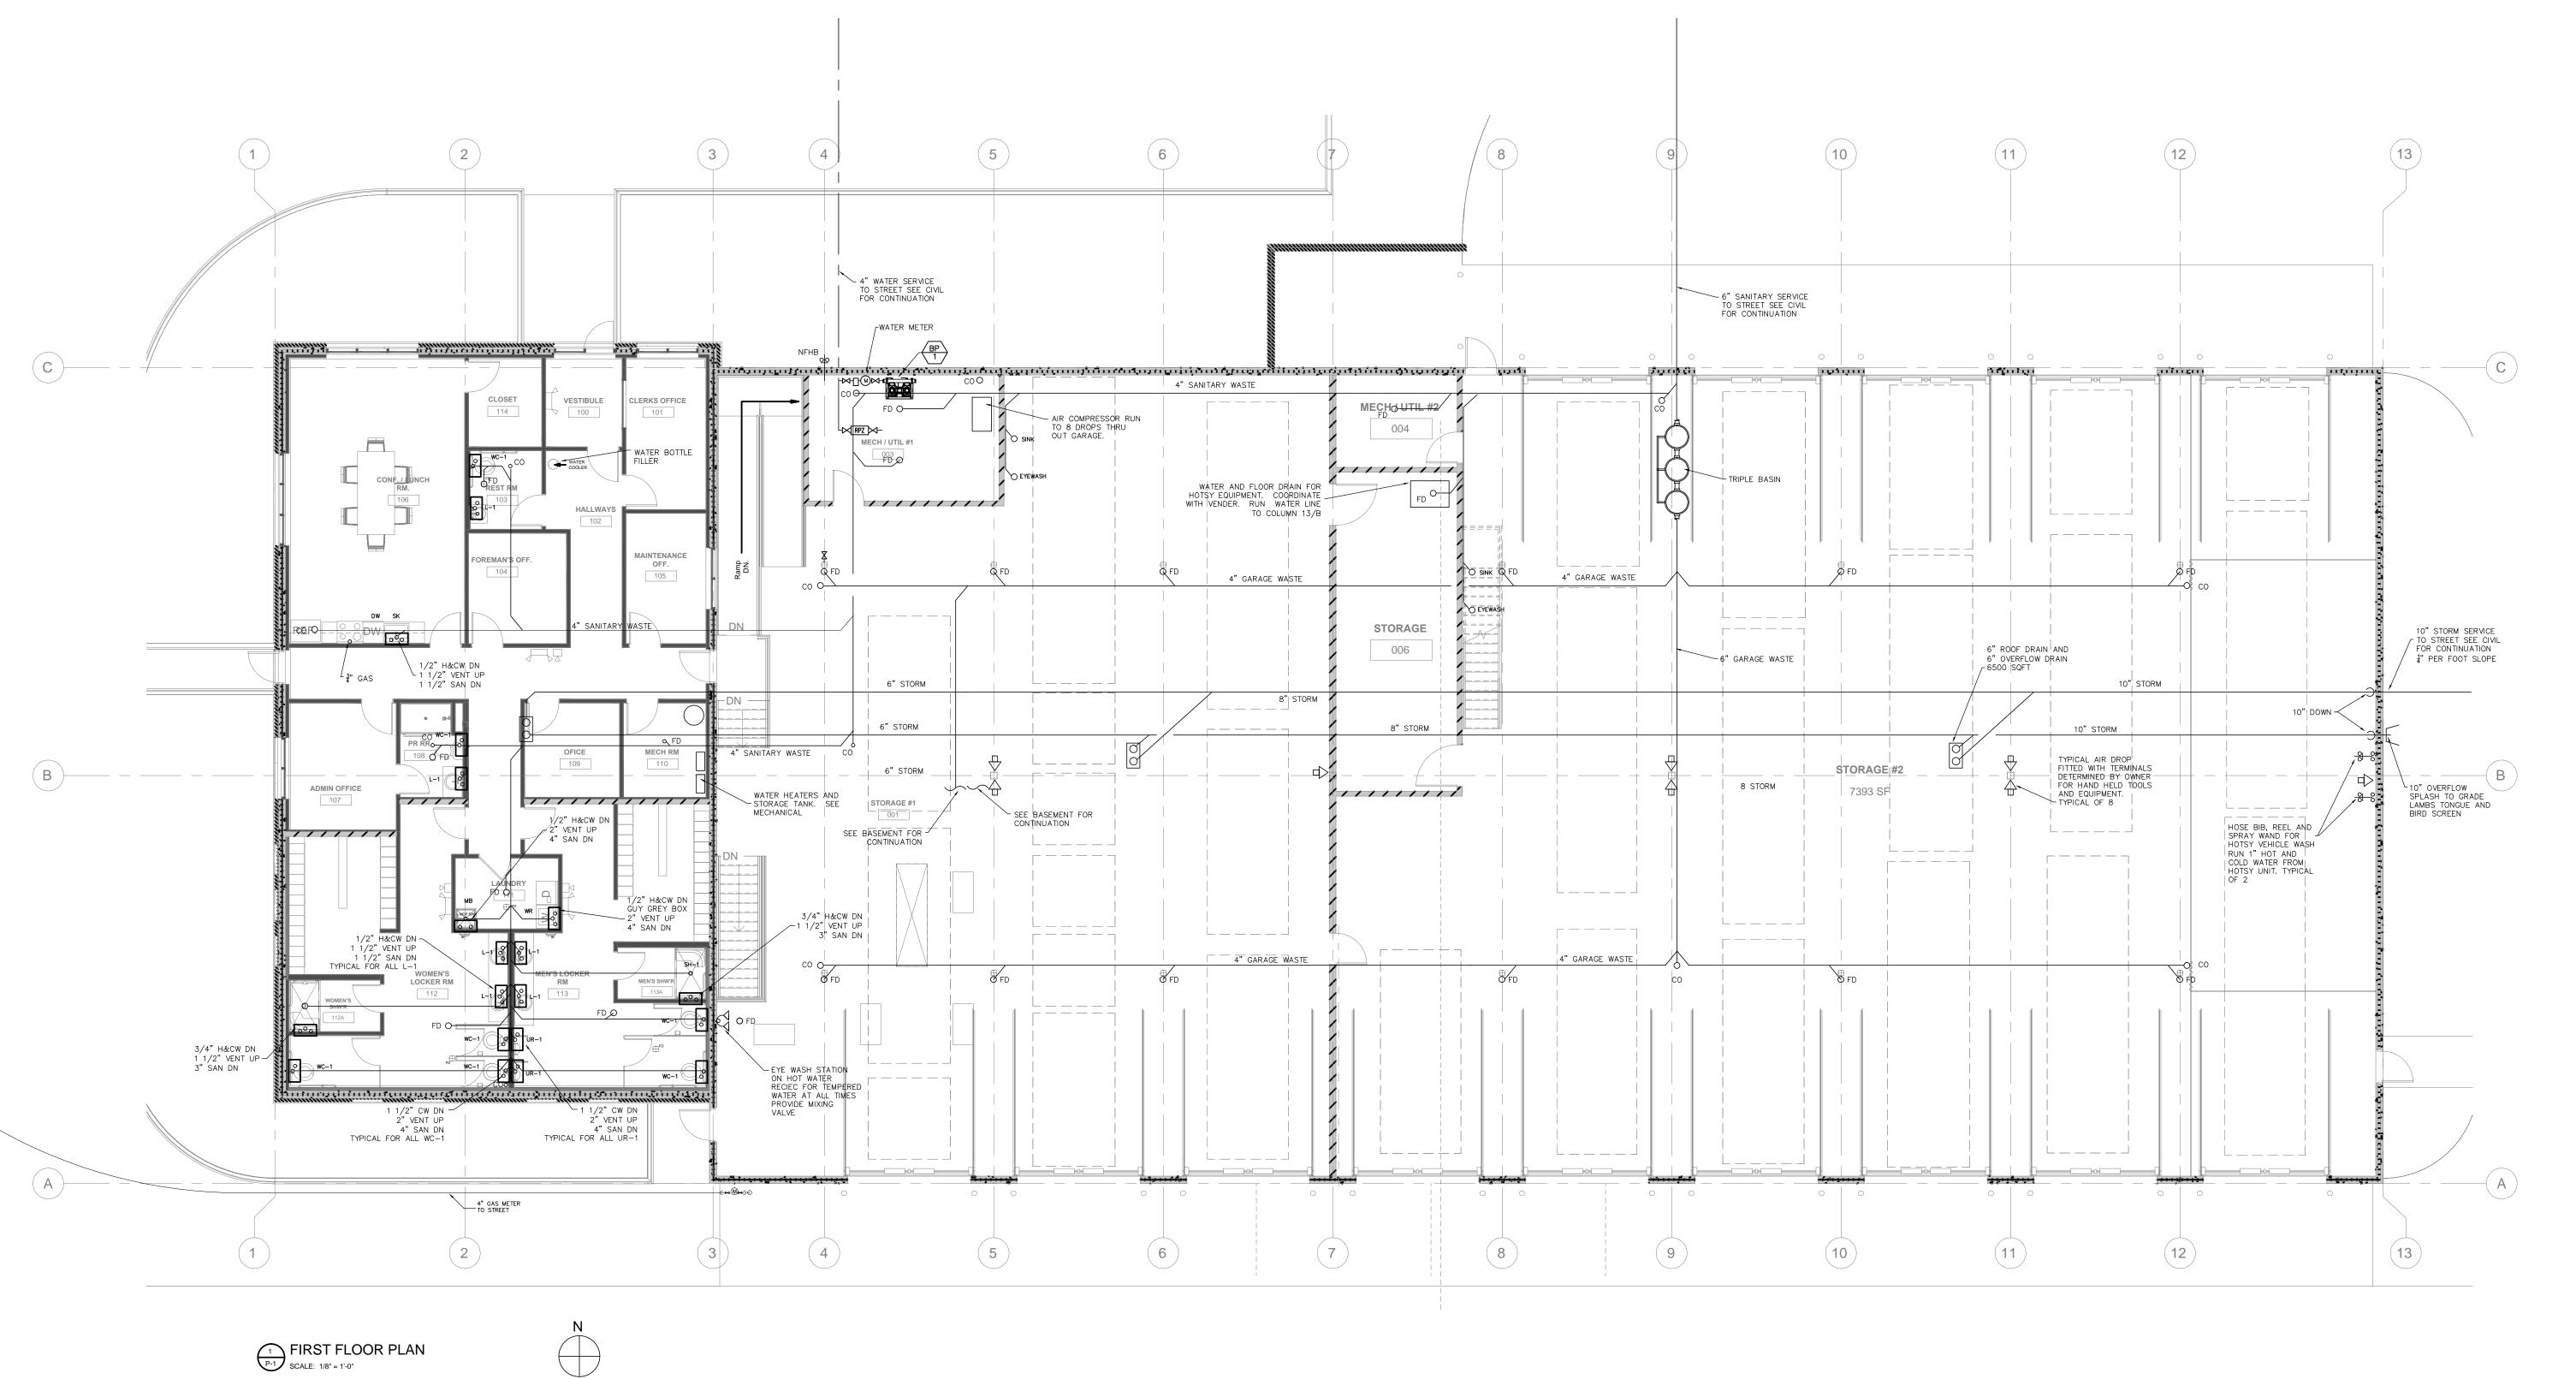


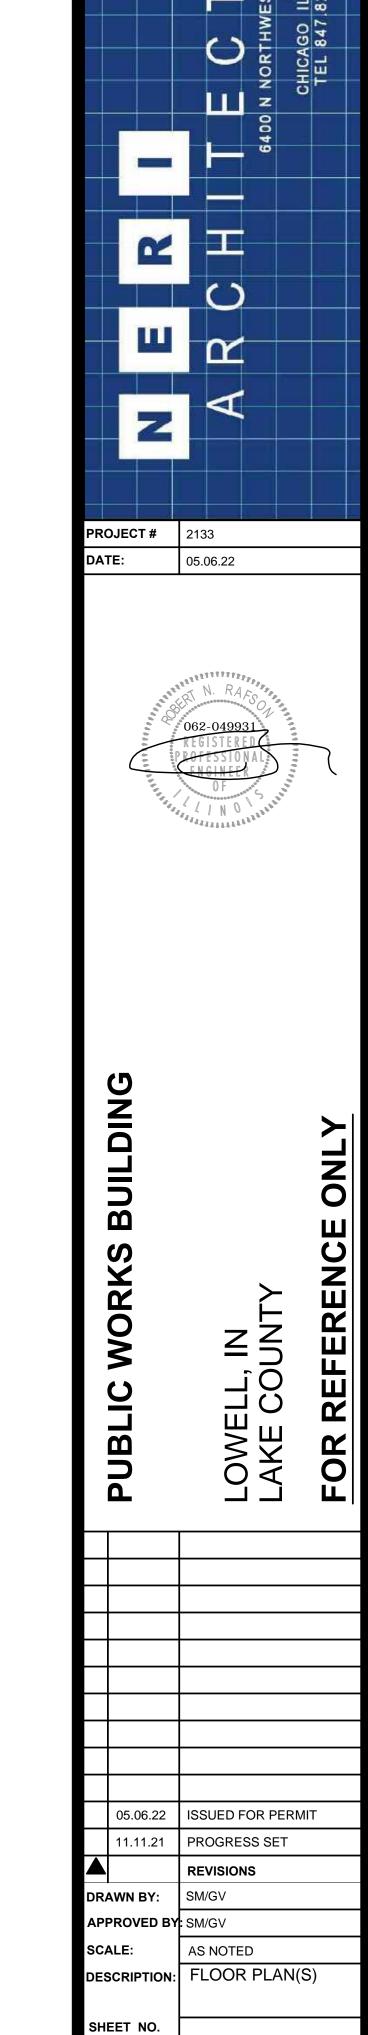



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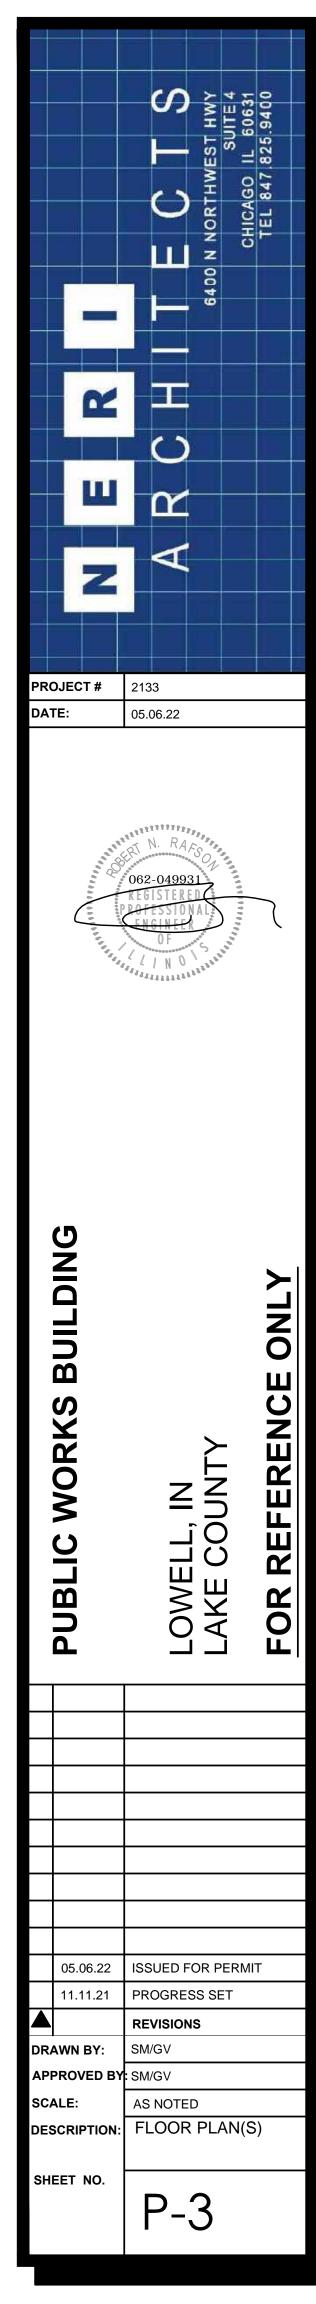


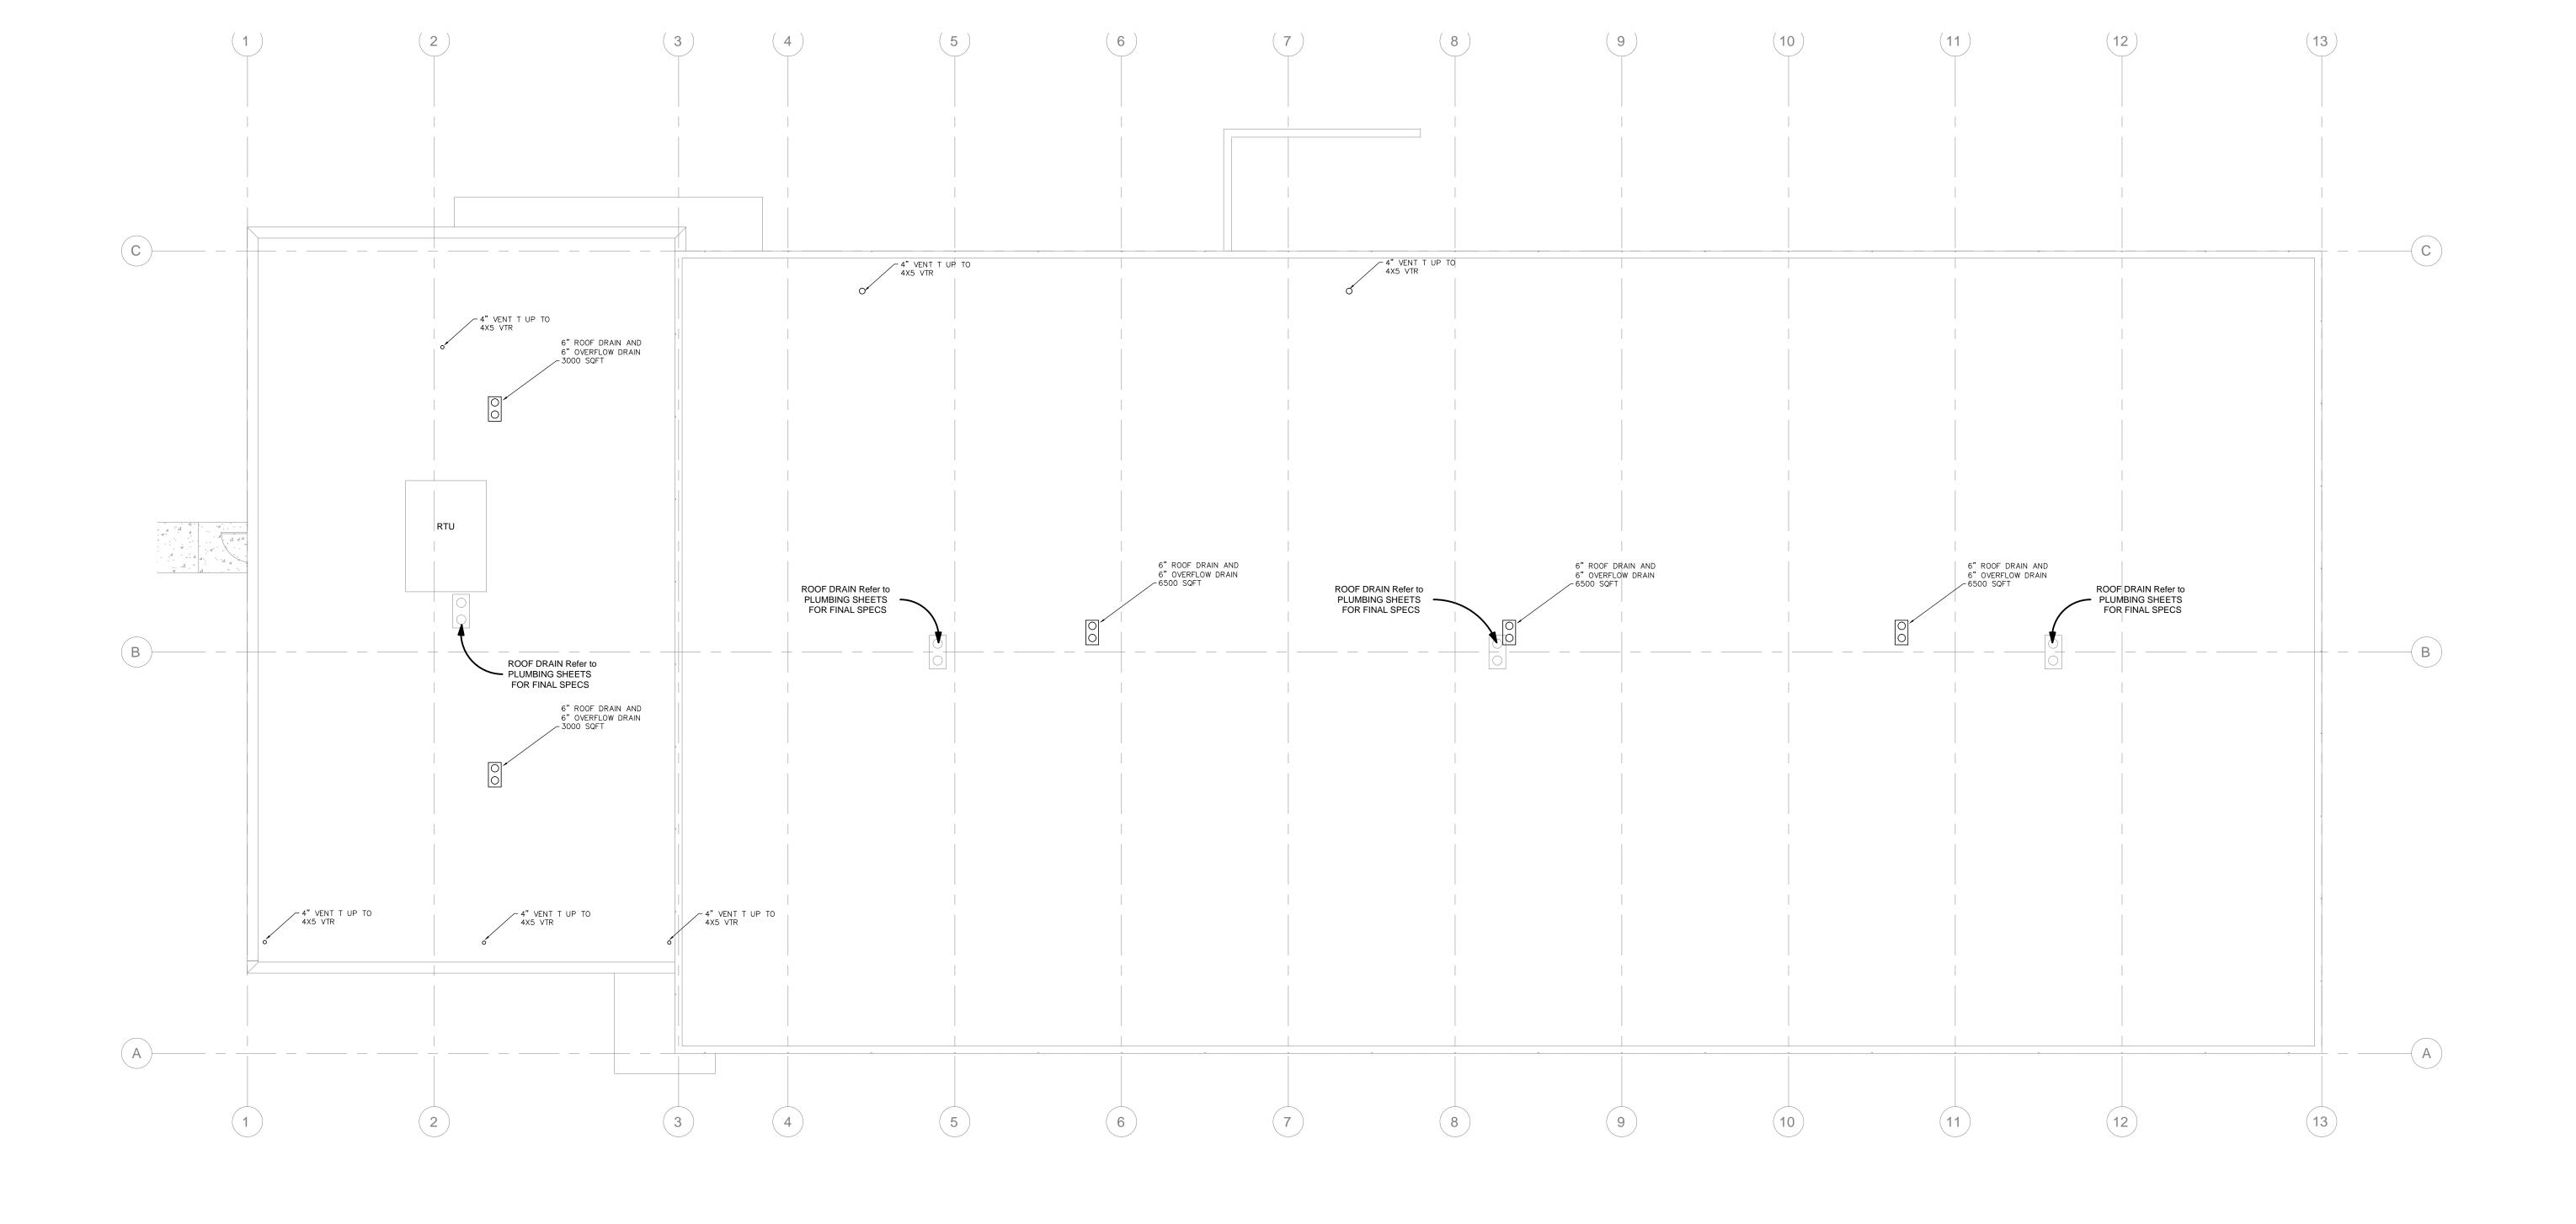



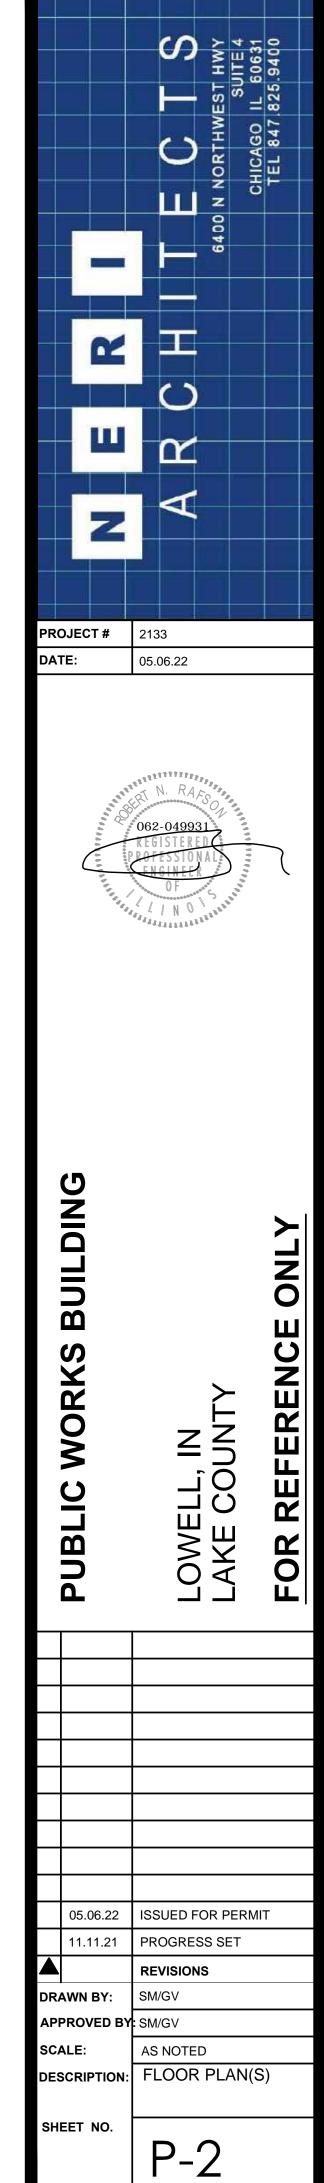

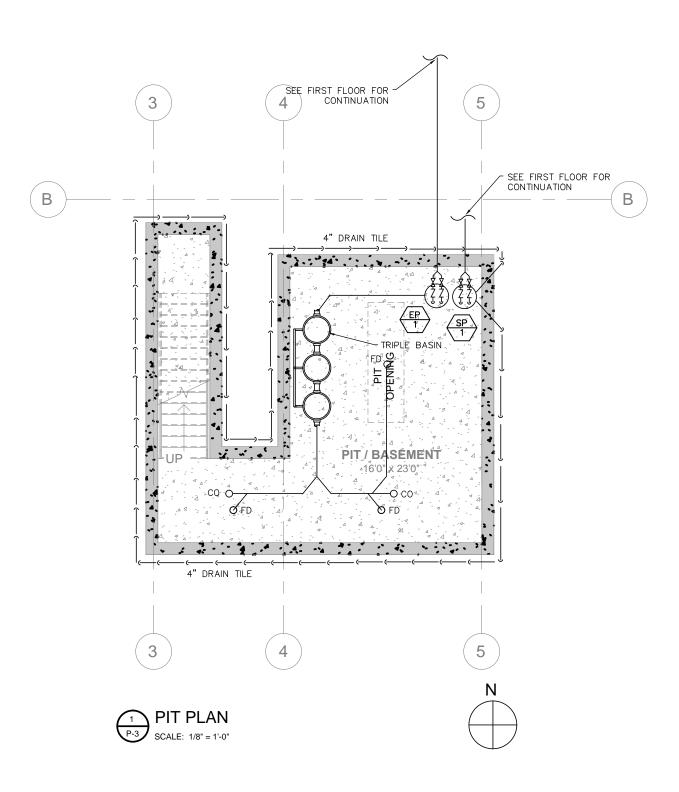

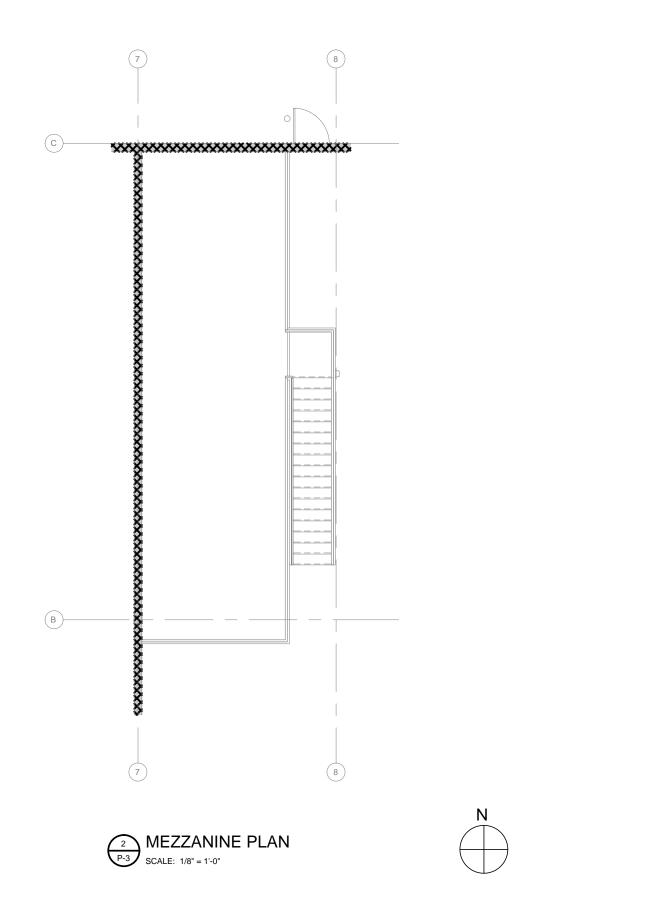

				PLUMBING FIXTURE SCHEDULE	
TAG	FLOW RATE (GPM)	FIXTURE	MFR. / MODEL No.	DESCRIPTION	REMARKS
WC-1	1.6/1.1 GPF	TOILET WALL HUNG	FOR TYPICAL MFR/MODEL# SEE A7.3 FOR FIXTURE, FAUCET AND TRIM	PROVIDE OPEN FRONT, ANTIBACTERIAL TOILET SEAT WITH STAINLESS STEEL CHECK HINGE. PROVIDE VANDAL RESISTANT QUARTER TURN SUPPLY STOP	SEE MFR. SPECIFICATIONS PRIC TO ROUGH—IN
UR-1	1.6/1.1 GPF	URINAL WALL HUNG	FOR TYPICAL MFR/MODEL# SEE A7.3 FOR FIXTURE, FAUCET AND TRIM	PROVIDE SLOAN "UPPERCUT" DUAL-FLUSH FLUSHOMETER MODEL No. WES-111. PROVIDE OPEN FRONT, ANTIBACTERIAL TOILET SEAT WITH STAINLESS STEEL CHECK HINGE. PROVIDE VANDAL RESISTANT QUARTER TURN SUPPLY STOP	SEE MFR. SPECIFICATIONS PRIC TO ROUGH—IN
L-1.	0.5 GPM	LAVATORY	FOR TYPICAL MFR/MODEL# SEE A7.3 FOR FIXTURE, FAUCET AND TRIM	PROVIDE GRID STRAINER, ADA P-TRAP & TAILPIECE & VANDAL RESISTANT QUARTER TURN SUPPLY STOPS. PROVIDE TRU-BRO LAV GUARD III FOR ALL LAV'S. PROVIDE THERMOSTATIC MIXING VALVE FOR ALL LAV'S.	SEE MFR. SPECIFICATIONS PRI TO ROUGH—IN
MB.	2.5 GPM	MOP BASIN	ZURN 1996-24	PROVIDE ZURN SINK FAUCET MODEL Z843M1 WITH POLISHED CHROME FINISH, INTEGRAL SERVICE STOPS, CAST BRASS SPOUT WITH CHEMICAL RESISTANT VACUUM BREAKER 3/4" HOSE THREADED OUTLET, PAIL HOOK AND ADJUSTABLE WALL HOOK. SPECIFY —CS (CHECK STOPS), —WHK (WALL HOOK) AND —5H (5' VINYL HOSE). INSTALL VACUUM BREAKER 7'—6" ABOVE FINISHED FLOOR.	SEE MFR. SPECIFICATIONS PRI TO ROUGH—IN
FD		FLOOR DRAIN	JR SMITH 2010	OPTIONS BY OWNER	SEE MFR. SPECIFICATIONS PRI TO ROUGH-IN
СО		CLEAN OUT	JR SMITH 420	OPTIONS BY OWNER	SEE MFR. SPECIFICATIONS PRI TO ROUGH—IN

SECTION 15400 PLUMBING

PART 1 - GENERAL

1.1 SCOPE OF WORK

- A. FURNISHING OF ALL LABOR, MATERIALS, TOOLS, TRANSPORTATION, SERVICES, AND RELATED ITEMS NECESSARY TO COMPLETE THE INSTALLATION OF THE PLUMBING SYSTEM AS ILLUSTRATED ON THE DRAWINGS AND INCLUDING BUT NOT LIMITED TO THE FOLLOWING:
- DRAWINGS AND INCLUDING BUT NOT LIMITED TO THE FOLLOWING:

 1.) HOT AND COLD WATER SYSTEMS WITH COMPLETE CONNECTIONS FROM THE WATER METER TO ALL PLUMBING FIXTURES AND EQUIPMENT REQUIRING WATER CONNECTIONS.
- 2.) SOIL, WASTE, VENT AND CONDENSATE SYSTEM LINES INSIDE THE BUILDING.
- 3.) PLUMBING FIXTURES, INCLUDING ALL THE REQUIRED TRIM AND SUPPORTS.
- 4.) TRENCHING AND BACKFILLING.
- 5.) FINAL PLUMBING CONNECTIONS TO HEATING AND AIR CONDITIONING
- 6.) METERS AND UTILITY CONNECTIONS.

PART 2 - PRODUCTS

2.1 DESCRIPTION

- A. SOIL, WASTE AND VENT PIPING BELOW FLOOR TO 5'-0" OUTSIDE BUILDING: STANDARD WEIGHT COATED CAST IRON PIPE AND CAST IRON/NEOPRENE GASKET FITTINGS.
- B. SOIL, WASTE AND VENT PIPING ABOVE FLOOR:
 STANDARD WEIGHT COATED CAST IRON PIPE AND STAINLESS
 STEEL/NEOPRENE GASKET FITTING, OR ABS OR PVC-DWV SCHEDULE 40,
 AS APPROVED BY LOCAL AUTHORITY IN CONCEALED LOCATIONS.
- C. HOT AND COLD WATER PIPING ABOVE FLOOR:
- TYPE "L" COPPER, HARD DRAWN. BELOW GROUND OUTSIDE OF BUILDING:
- TYPE "K" HARD COPPER.
- BELOW SLAB INSIDE OF BUILDING:
- TYPE "K" SOFT DRAWN COPPER TUBING WITHOUT JOINTS.
- D. CONDENSATE DRAIN PIPING:
- BY MECHANICAL CONTRACTOR.

 E. INSIDE STORM PIPING ABOVE GROUND:
- STANDARD WEIGHT COATED CAST IRON PIPE AND STAINLESS

 STEEL/NEOPRENE GASKET FITTING OR ABS OR PVC—DWV SCHEDULE 40, AS
- APPROVED BY LOCAL AUTHORITY.

 F. TRAPS AND VENTS FOR SERVICE SINKS:
- ABS OR PVC SCHEDULE 40, AS APPROVED BY LOCAL AUTHORITY.

2.2 INSULATION

- A. PROVIDE FOAM RUBBER INSULATION EQUAL TO ARMSTRONG ARMAFLEX TYPE "AP" ON COLD AND HOT WATER, AND CONDENSATE DRAIN PIPING. INSULATION TO BE SLIPPED ON WITH BUTT JOINTS. USE MITER CUT PIECES FOR FITTINGS AND PRE-FORMED FITTINGS FOR ALL VALVES. APPLY MANUFACTURER'S PAINT TO ALL EXPOSED RUNS. UTILIZE 1" THICK INSULATION ON HOT WATER PIPING AND 1/2"
- THICK ON COLD WATER AND CONDENSATE DRAIN PIPING.

 B. INSULATE "P" TRAP AND EXPOSED HOT WATER SUPPLY LINES BELOW HANDICAPPED ACCESSIBLE HAND SINKS AND LAVATORIES IN ONE OF THE FOLLOWING MANNERS:
- 1.) MOLDED FLEXIBLE VINYL INSULATION SYSTEM, MODEL #101
- "HANDI LAV—GUARD" AS MANUFACTURED BY TRUEBRO.
 2.) PVC 2 PIECE "P" TRAP COVER WITH INSULATION TUBING,
- "TRAP-GUARD" AS MANUFACTURED BY BUCKAROOS.

3.) OTHER MANUFACTURERS/TYPES BY PRIOR APPROVAL ONLY. 2.3 FIXTURES

A. ALL FIXTURES: AS INDICATED ON DRAWINGS WITH EQUAL PRODUCTS

FURNISHED BY AMERICAN STANDARD, KOHLER OR ELJER. 2.4 CLEANOUTS, FLOOR DRAINS, FLOOR SINKS AND ROOF DRAINS

A. ALL ACCESSORIES: AS INDICATED ON THE DRAWINGS THE EQUAL PRODUCTS FURNISHED BY WADE JOSAM OR ZURN BEING ACCEPTABLE.

2.5 EQUIPMENT

- A. SHUT-OFF VALVES UNDERNEATH LAVATORIES, TANK TYPE WATER CLOSETS AND KITCHEN FIXTURES:
- CHROME PLATED ANGLE STOP VALVES WITH CHROME PLATED ESCUTCHEON PLATES AND AS SCHEDULED ON DRAWINGS.
- B. HOSE BIBBS:
 AS SCHEDULED ON DRAWINGS.
- C. VACUUM BREAKERS:
 AS SCHEDULED ON DRAWINGS.
- D. BACKFLOW PREVENTERS:
 AS SCHEDULED ON DRAWINGS.

PART 3 - INSTALLATION

3.1 PIPING

- A. RUN ALL PIPING CONCEALED EXCEPT WHERE OTHERWISE INDICATED ON
- B. INSTALL VALVES, TRAPS, CLEAN—OUTS AND OTHER APPARATUS IN AN EASILY ACCESSIBLE LOCATION.
- C. INSTALL SOIL, WASTE, VENT OFFSETS AND CONDENSATE DRAINS WITH A
- MINIMUM UNIFORM GRADE OF ONE QUARTER INCH TO THE FOOT.

 D. MAINTAIN HOT AND COLD WATER LINES AT LEAST 6" APART WHERE PIPING IS PARALLEL.
- E. PROVIDE ESCUTCHEON PLATES WHERE ALL PIPES PASS THROUGH A FINISHED WALL.

3.2 HANGERS AND SUPPORTS

A. SUPPORT COPPER PIPING AT INTERVALS NOT TO EXCEED 7'-0" AND AT EACH CHANGE IN HORIZONTAL OR VERTICAL DIRECTION.

3.3 PLUMBING FIXTURES

- A. FURNISH AND INSTALL ALL PLUMBING FIXTURES COMPLETE WITH ALL EQUIPMENT FITTINGS, TRIMMINGS AND ACCESSORIES.
- B. ALL FIXTURES: GRADE A, WHITE.
- C. EXPOSED PIPING TO FIXTURES: A PRODUCT OF THE FIXTURE MANUFACTURER
- D. PROVIDE STOPS AS MANUFACTURED BY THE FIXTURE MANUFACTURER, WITH METAL—TO—METAL SEAT FOR ALL FIXTURES AND EQUIPMENT.

3.4 TEST

A. THE PLUMBING SYSTEM AND ASSOCIATED SYSTEM IS SUBJECT TO FINAL APPROVAL OF THE OWNER'S.

3.5 CLEANING

A. AFTER THE PLUMBING PIPING HAS BEEN INSTALLED, INSPECTED AND APPROVED, FLUSH THE PIPING SYSTEM TO REMOVE ANY FOREIGN MATTER FROM THE PIPES. WHERE REQUIRED, USE CHLORINE OR HTH SOLUTION TO SANITIZE THE NEW PIPING.

GENERAL PLUBMING NOTES:

- 1. ALL WORK TO MEET PLUMBING CODES AS SET FORTH BY THE ILLINOIS
- DEPARTMENT OF PUBLIC HEALTH 2014.

 2. THE LICENSED PLUMBER OF RECORD LISTED ON THE PERMIT SHALL BE PRESENT ON ALL PLUMBING INSPECTIONS.
- ACCORDING TO PUBLIC ACT 0940132 SEC. 37 A LETTER OF INTENT SHALL BE INCLUDED WITH ALL PERMIT APPLICATIONS. THE LETTER SHALL BE WRITTEN ON THE LICENSED PLUMBER OF RECORD'S BUSINESS STATIONARY AND SHALL INCLUDE THE LICENSE HOLDER'S SIGNATURE AND, IF THE LICENSE HOLDER IS INCORPRATED, THE LICENSE HOLDER'S CORPORATE SEAL. IF THE HOLDER IS NOT INCORPORATED, THE LETTER
- MUST BE NOTARIZED.

 4. DOMESTIC WATER AS WELL AS SANITARY WASTE SHALL BE TESTED USING A
- TEST METHOD DESCRIBED IN 890.1930 a)-c)
 5. ALL GAS PIPING TO MEET LOCAL AND NATIONAL APPLICABLE MATERIAL AND
- TESTING CODES
- 6. FOLLOW THE REQUIREMENTS SET FORTH IN ILLINOIS ENERGY CODE REGARDING WORK TO BE DONE.
- 7. PROVIDE PLAN REVIEW AT ALL INSPECTIONS.
- 8. ALL UNDERGROUND PIPING SHALL BE BACKFILLED PER IDPH INCLUDING 890.180, AS WELL AS MANUFACTURER SPECS. PROVIDE MANUFACTURER SPECS AT TIME OF INSPECTION.
- 9. ALL WORK SHALL BE INSPECTED AND APPROVED PRIOR TO BEING CONCEALED
- 10. SPRINKLER CONTRACTOR SHALL FOLLOW ILLINOIS PLUMBING LICENSE LAW (255 ILCS 320/2.5) IN ITS ENTIRETY.
- 11. ALL WORK SHALL MEET ALL ACCESSIBILITY CODES.
- 12. JOURNEYMAN PLUMBING LICENSE HOLDER SHALL PROVIDE PROOF OF UP TO DATE CONTINUING EDUCATION AT TIME OF INSPECTION.
- 13. ALL RPZ BACK FLOW PROTECTORS SHALL BE INSTALLED BY PLUMBER OF RECORD, THIS SHALL INCLUDE FIRE SUPPRESSION.
 14. WATER SERVICE IS TO BE INSTALLED BY LICENSED PLUMBING CONTRACTOR.
- PROVIDE LETTER OF INTENT, IDPH PLUMBING CONTRACTOR REGISTRATION (055) AND IL OR CITY PLUMBING LICENSE.
- 15. COMPLY WITH THE REQUIREMENTS OF THE FIRE DEPARTMENT 16. COMPLY WITH THE REQUIREMENTS OF THE VILLAGE ENGINEER
- 17. COMPLY WITH THE REQUIREMENTS OF PUBLIC WORKS

VARIABLE SPEED PUMP SCHEDULE FLOW RATE RATED PUMP HEAD TYPE LOCATION DESCRIPTION REMARKS //PH/HZ HP PSI CLOSE COUPLED 160 208/3/60 25 /ERTICAL MULTI-STAGE DUPLEX VARIABLE SPEED RATED FOR A SYSTEM CAPACITY OF FIRE PROTECTION, GAS DUPLEX DOMESTIC BP-1 & WATER METER ROOM WATER BOOSTER PUMI 320 GPM WITH A MAINTAINED SYSTEM PRESSURE OF 60 PSI INCLUDING A MINIMUM SUCTION PRESSURE OF 10 PSI. CLOSE COUPLED 208/3/60 160 25 VERTICAL MULTI-STAGE

TAG	MFR. / MODEL No.	FIXTURE	DESCRIPTION	REMARKS
NFHB	ZURN ECOLOTROL MODEL 1300-15	NON-FREEZE WAL HYDRANT	ENCASED ANTI—SIPHON AUTOMATIC DRAINING WALL HYDRANT FOR FLUSH INSTALLATION w/INTEGRAL BACKFLOW PREVENTOR, BRONZE CASING. NICKEL BRONZE BOX w/HINGED COVER AND OPERATING KEY LOCK.	SEE MFR. SPEC SHEET PRIOR TO INSTALL.
НВ	JR SMITH MODEL 5609QT	HOSE BIBB	QUARTER TURN NON-FREEZE HYDRANT, WITH 3/4" HOSE CONNECTION, BACKER PLATE AND INTEGRAL VACUUM BREAKER WITH VANDAL RESISTANT CAP AND "T" HANDLE. SPECIFY CHROME PLATED.	SEE MFR. SPEC SHEET PRIOR TO INSTALL.

			EJECTOF	R & SUN	MP PUMP	SCHEDULI				
	MEDIA OD CVCTEM	PUMP DATA MOTOR DATA					MANUFACTURER	DEMARKS		
PUMP NO.	UMP NO. LOCATION MEDIA OR SYSTEM		TYPE	CAPACITY (GPM)	HEAD (FT)	V / PH / HZ	HP	RPM	AND MODEL	REMARKS
SP-1	MECH. RM	STORM	SUBMERSIBLE DUPLEX	50	15	115/1/60	1/2	1725	ZOELLER MODEL M266	SEE MFR. SPEC. SHEET PRIOR TO INSTALL. WITH LEAD/LAG CONTROL
EP-1	MECH. RM.	SANITARY	SUBMERSIBLE DUPLEX EXPLOSION PROOF	50	15	115/1/60	1/2	1725	ZOELLER MODEL M266	SEE MFR. SPEC. SHEET PRIOR TO INSTALL.

Material	Permitted	Not Permitted	Standards to Follow
Wrought-Iron	Schedule 40 or better		ASME B 36.10.10M or ASTM A35 or ASTM A106
Steel	Schedule 40 or better		ASME B 36.10.10M or ASTM A35 or ASTM A106

N.G. DISTRIBUTION PIPING SHALL BE SCHEDULE 40 STEEL PIPE MEETING THE REQUIREMENTS OF ASTM A 53/A 53M WITH 150# MALLEABLE IRON FITTINGS. GAS PIPING LARGER THAN 3" OR MORE THAN 5 PSIG TO BE WELDED TO BE SCHEDULE 40 STEEL


Note: The gas piping design shall conform to all the requirements of IFGC 403

GENERAL GAS PIPING NOTES:

- 1. ALL WORK SHALL BE FURNISHED AND INSTALLED IN ACCORDANCE WITH BUILDING STANDARDS AND ALL APPLICABLE CODES.
- 2. FUEL GAS PIPING AND CONTROLS MUST CONFORM TO THE INTERNATIONAL FUEL GAS CODE(IFGC), CHAPTER 4 (WITH MODIFICATIONS AS NOTED IN ARTICLE 14). [18-28-1400]
- 3. GAS PIPING MUST BE SIZED IN ACCORDANCE WITH IFGC TABTES 402.(1) THROUGH 402.3(34). [IFGC 402.3]
- 4. THE MAXIMUM DESIGN OPERATING PRESSURE FOR GAS PIPING SYSTEMS LOCATED INSIDE BUILDINGS SHALL NOT EXCEED 5 PSIG (SOME EXCEPTIONS ARE NOTED). [TFGC 402.5]
- 5. GAS PIPING MATERIALS MUST CONFORM TO THE GAS PIPING & TUBING MATERIAL MATRIX (LFGC 403 REQUIREMENTS). [IFGC 403]
- 6. PIPING IN CONCEALED LOCATIONS MUST CONFORM TO THIS IFGC 404.3. [IFGC 404.3]
- 7. MINIMUM REQUIRED BURIAL DEPTH FOR UNDERGROUND PIPING SYSTEMS MUST CONFORM TO IFGC 404.9. (MINIMUM 12 INCHES BELOW GRADE). [IFGC 404.9]
- (MINIMON 12 HOLES BELOW GRADE). [II GO TOT.3]
- 8. GAS PIPES MUST BE SLOPED AT 1/4 INCH IN EVERY 15 FEET. [IFGC 408.1]
- 9. GAS PIPING GREATER THAN 2" INSIDE DIAMETER OR CARRYING MORE THAN 5 POUNDS(PSIG) SHALL BE SCHEDULE 40 STANDARD WELD FITTINGS.
- 10. PIPING METER IDENTIFICATION SHALL BE MARKED WITH AN APPROVED PERMANENT IDENTIFICATION AND BE READILY IDENTIFIABLE.
- 11. PAINT ALL GAS PIPING THAT IS EXPOSED TO THE ELEMENTS.
- 12. UNDERGROUND PIPING SHALL BE A MIN OF 18" BELOW GRADE. [IFGC 404.12]


GAS SERVICE ALTERNATE:

CITY OF CHICAGO TO UPGRADE GAS MAIN PRESSURE. IF CITY UP GRADE IS NOT COMPLETE BY THE TIME THIS ROJECT IS COMPLETE, ADD GAS BOOSTER EQUAL TO ECLIPSE COMPAC HB SERIES [PACKAGED HERMETICALLY SEALED GAS BOOSTER HB3314-1/2-N4, 1.2HP, 208V 3 PHASE.

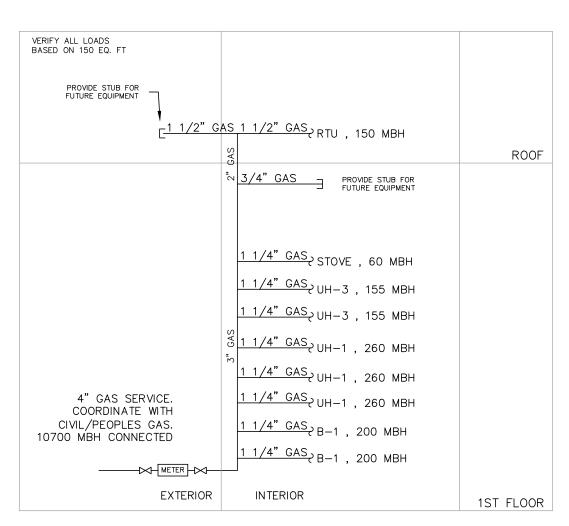

Gas Distribution

SCALE: NONE

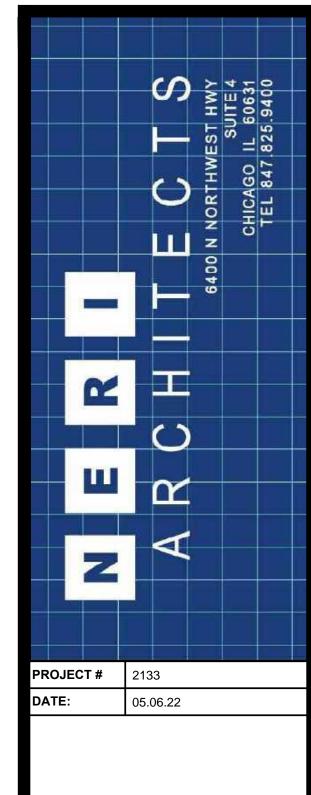



IC WORKS BUILDING

LOWELL, IN LAKE COUNTY FOR REFERE

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05.06.22 ISSUED FOR PERMIT

11.11.21 PROGRESS SET

REVISIONS

DRAWN BY: SM/GV

APPROVED BY: SM/GV


SCALE: AS NOTED


DESCRIPTION: PLUM SCHEDULES,

P-4

SHEET NO.

NOTES & DETAILS

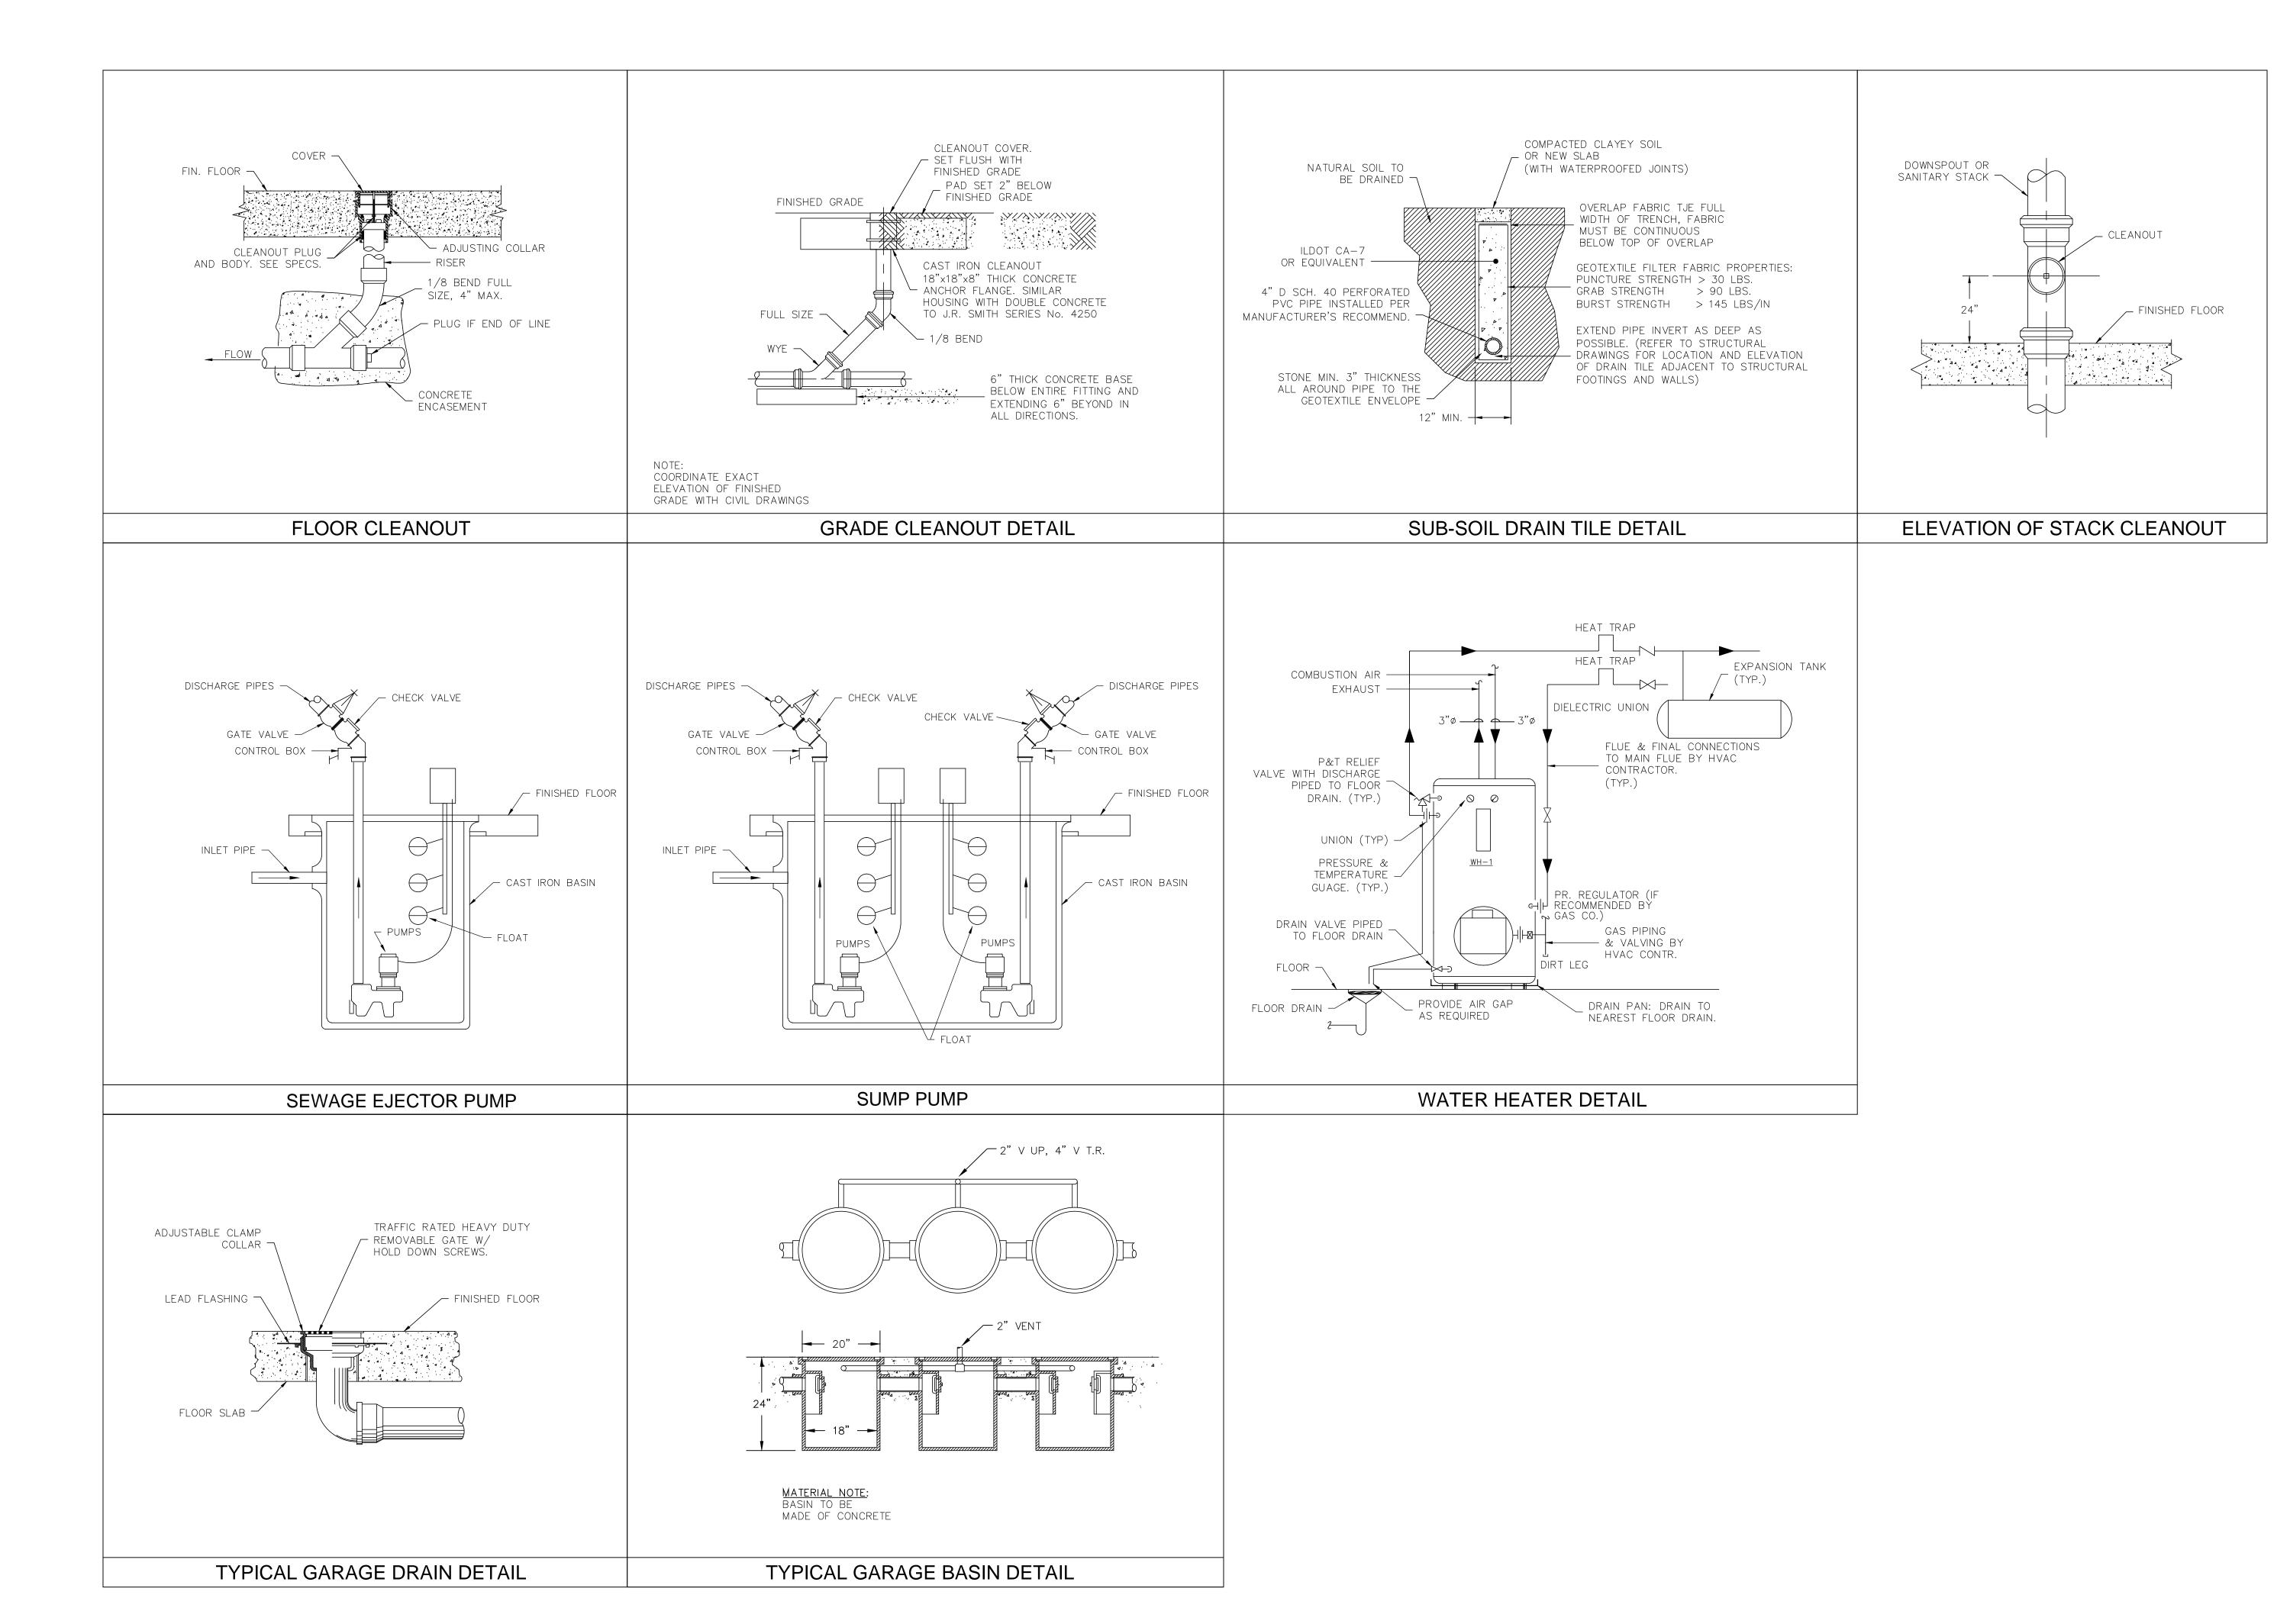

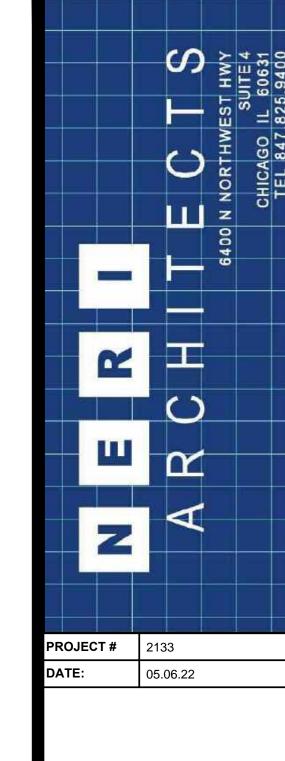


BUILDING


WORKS

FOR REFERENCE LOWELL, IN LAKE COUNTY

ONLY

	PUBLIC	LOWELL, LAKE CO
	05.06.22	ISSUED FOR PERMIT
	11.11.21	PROGRESS SET
		REVISIONS
OR/	AWN BY:	SM/GV
ΑPI	PROVED BY	: SM/GV
SCALE:		AS NOTED
DES	SCRIPTION:	PLUM SCHEDULES, NOTES & DETAILS
SH	EET NO.	P-5

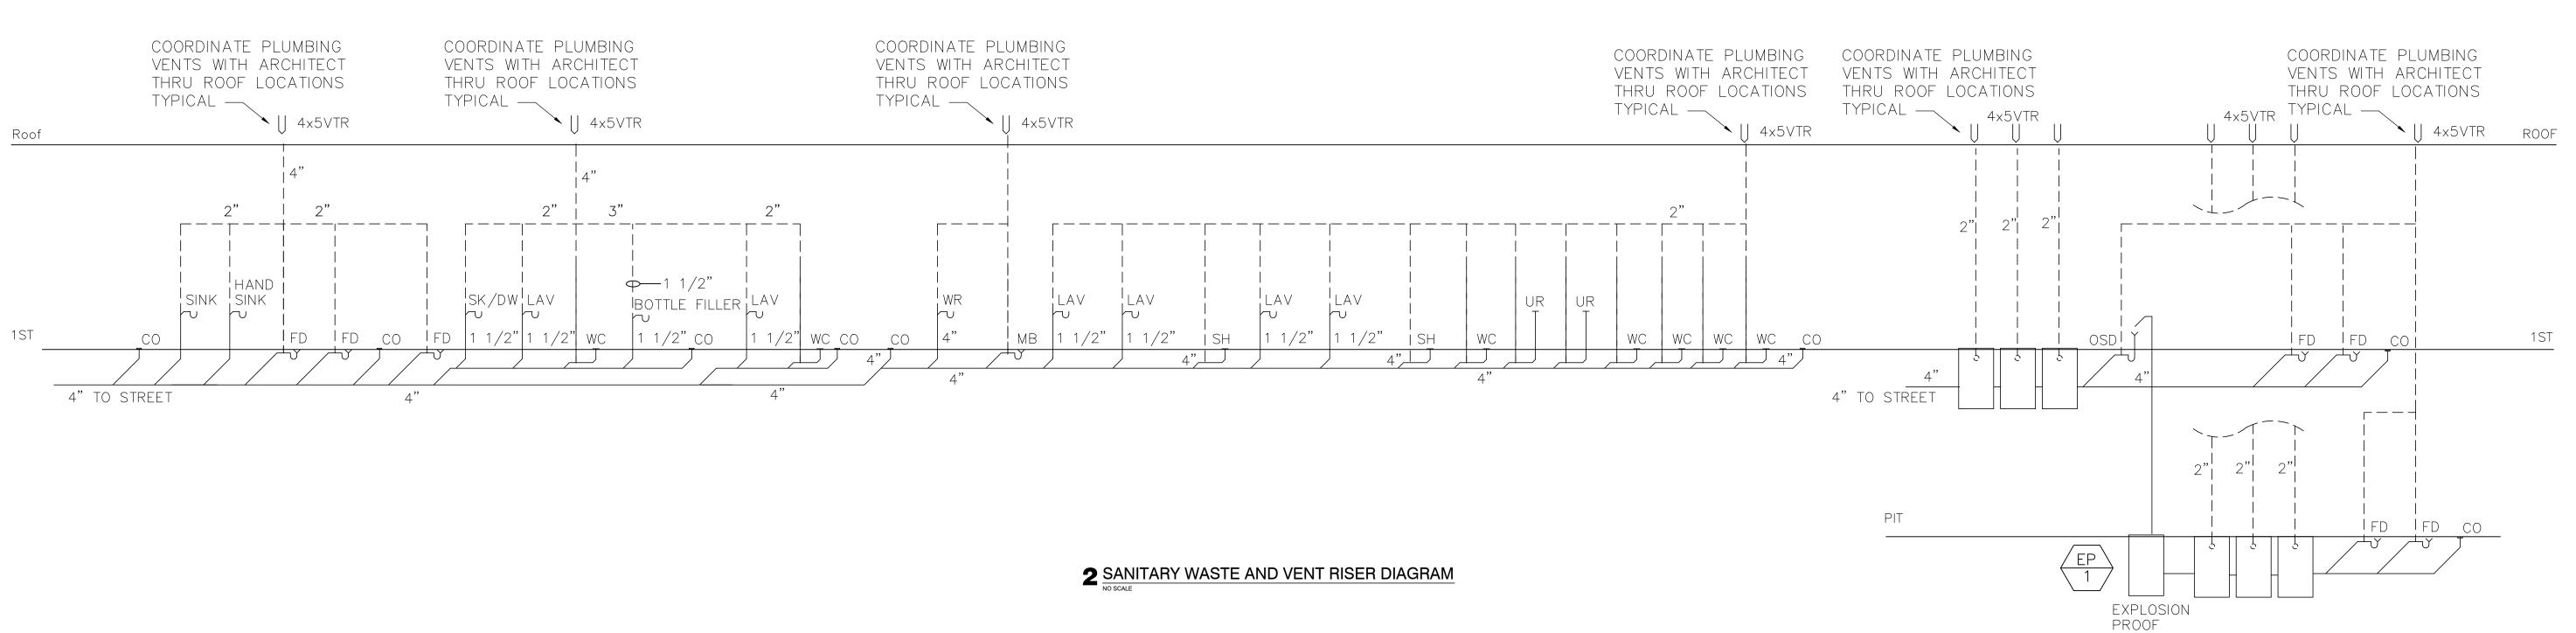

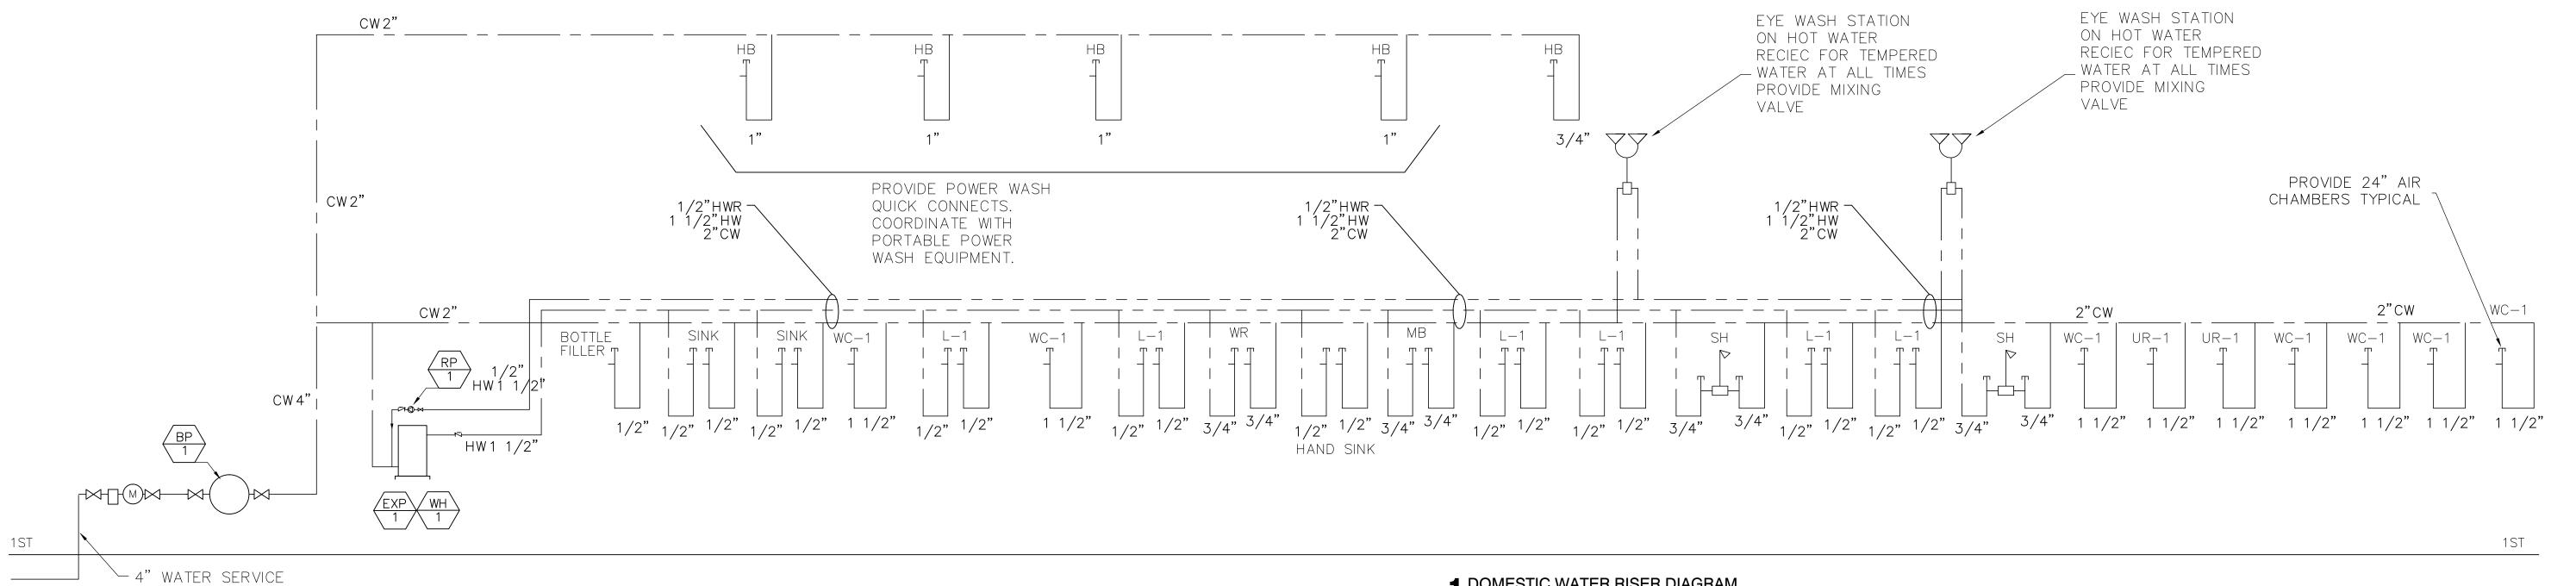

1 DOMESTIC WATER RISER DIAGRAM

Roof

BUILDING ONLY FOR REFERENCE WORKS LOWELL, IN LAKE COUNTY **PUBLIC** 05.06.22 ISSUED FOR PERMIT 11.11.21 PROGRESS SET DRAWN BY: APPROVED BY: SM/GV AS NOTED DESCRIPTION: PLUM SCHEDULES, NOTES & DETAILS SHEET NO.



